

LANDSCAPE VEGETATION MANAGEMENT SUB PLAN

Moorebank Precinct East Stage 2

13 OCTOBER 2022



SYDNEY INTERMODAL TERMINAL ALLIANCE MOOREBANK PRECINCT EAST STAGE 2

Landscape Vegetation Management Sub Plan

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Author Details

This Landscape Vegetation Management Sub Plan was originally prepared by Arcadis in consultation with Ground Ink (Landscape Architects).

This consolidated version of the LVSMP has been prepared by Aspect Environmental.

Contributor Details	Qualifications and Experience

Author Details	Qualifications and Experience





REVISIONS

Revision	Date	Description	Prepared by	Approved by
001	15/06/2018	Initial draft		
002	14/08/2018	Updated for submission to Liverpool City Council (also submitted to DP&E on 09/05/2018)	-	-
003	18/04/2019	Updated with GANSW and DP&E comments		
004	06/06/2019	Updated to reflect change in OSD 9 design layout		
005	13/02/2020	Updated to include Area 2		
006	25/02/2020	Updated to address client comments and include MOD2 requirements		
006B	14/05/2020	Updated to include LCC's consultation regarding Area 2		-
006C	31/07/2020	Updated to include DPE's consultation regarding Area 2		
007	26/06/2020	Updated to include all Areas (consolidated plan)		
008	3/11/2020	Updated to include DPE/GANSW and LCC's consultation regarding the Consolidated UDLP, and to reflect updates to Area 2		
009	13/10/2022	Updated to reflect design change to Area 3		



ACRONYMS AND DEFINITIONS

Term	Meaning
Area 1	Warehouse 1 and immediate surrounding area (not including the freight village)
Area 2	Area incorporating Warehouses 3, 4 and 5 between IMEX terminal and eastern boundary of MPE Site.
Area 3	Area incorporating Warehouses 6 and 7, including OSD2, between IMEX terminal and eastern boundary of MPE Site
Area 4	Area incorporating the freight village, within the northern portion of Area 1
Area 5	Area incorporating Warehouse 2, in the north eastern corner of the MPE Site
Area 6	Area incorporating Moorebank Avenue
CBD	Central Business District
CoC	Conditions of Consent
DPE	Department of Planning and Environment (formerly Department of Planning, Industry and Environment)
EIS	Environmental Impact Statement
EP&A Act	Environmental Planning and Assessment Act 1979
GANSW	Government Architect New South Wales
GFA	Gross floor area
IPA	Inner Protection Area
LCC	Liverpool City Council
LGA	Local Government Area
LOGOS	LOGOS Property Group
LVMSP	Landscape Vegetation Management Sub Plan
MPE	Moorebank Precinct East
MPW	Moorebank Precinct West
OEMP	Operational Environmental Management Plan
OFFMP	Operational Flora and Fauna Management Plan
RtS	Response to Submissions
SIOMP	Stormwater Infrastructure Operational Maintenance Plan
SIMTA	Sydney Intermodal Terminal Alliance
Project (the)	The construction and operational areas identified within the MPE Stage 2 RtS (previously referred to as the Amended Proposal Site within the MPE S2 RtS) and approved under SSD 7628.



Term	Meaning
Project Site (the)	The construction and operational areas identified within the MPE Stage 2 RtS (previously referred to as the Amended Proposal Site within the MPE S2 RtS) and approved under SSD 7628. The MPE Project Site includes Areas 1 to 6, as described in the UDLP and sub plans.
SSD	State significant development
TfNSW	Transport for NSW
UDLP	Urban Design and Landscape Plan



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1 BACKGROUND

The Project has been assessed by the Department of Planning and Environment (DPE) (formerly Department of Planning, Industry and Environment) (DPIE) under Part 4, Division 4.1 (now Division 4.7 as of 1 March 2018) of the *Environmental Planning and Assessment Act* 1979 (EP&A Act) as State significant development (SSD). The Planning Assessment Commission (PAC) granted approval for the Moorebank Precinct East (MPE) Stage 2 Project on 31 January 2018 subject to Conditions of Consent (CoC (SSD 7628)). The DPE subsequently approved Modification 1 (MOD 1) in March 2022, MOD 2 on 31 January 2020 MOD 3 on 8 December 2020 and MOD 4 on 19 January 2021 under Section 4.55(1) of the (EP&A Act).

This Landscape Vegetation Management Sub Plan (LVMSP) has been developed to assist in the monitoring and maintenance of landscape elements associated with Stage 2 of the MPE Project (hereafter, the Project).

This LVMSP addresses the relevant requirements of the consolidated SSD 7628 development consent, including the Environmental Impact Statement (EIS), Response to Submissions (RtS), CoCs, and all applicable guidelines and standards specific to the monitoring and maintenance of landscape vegetation around the Project Site. This LVMSP forms part of the Urban Design and Landscape Plan (UDLP).

1.1 Introduction

The MPE Site, including the Project Site, is located approximately 27 km south-west of the Sydney Central Business District (CBD) and approximately 26 km west of Port Botany and includes the former Defence National Storage and Distribution Centre site. The MPE Site is situated within the Liverpool Local Government Area (LGA), in Sydney's south-west subregion, approximately 2.5 km from the Liverpool City Centre.

The MPE Project involves the development of an intermodal facility including warehouse and distribution facilities, freight village (ancillary site and operational services), stormwater, landscaping, servicing and associated works on the eastern side of Moorebank Avenue, Moorebank.

Stage 2 of the MPE Project (the Project) involves the construction and operation of warehousing and distribution facilities on the MPE Site and upgrades to approximately 1.5 km of Moorebank Avenue from approximately 35 m south of the northern boundary of the MPE Site to approximately 185 m south of the southern MPE Site boundary. The Project has been assessed by DPE under Part 4, Division 4.1 (now Division 4.7 as of 1 March 2018) of the *Environmental Planning and Assessment Act* 1979 (EP&A Act) as State significant development (SSD).

Key components of the Project include:

- approximately 300,000 m² gross floor area (GFA) of warehousing and ancillary offices
- freight village, 8,000 m² GFA of ancillary retail, commercial and light industrial land uses
- internal road network and hardstand across the site
- ancillary supporting infrastructure within the site, including:
 - stormwater, drainage and flooding infrastructure
 - fencing, signage, lighting, remediation and landscaping
- Moorebank Avenue upgrade including:
 - raising by about 2 m and some widening
 - embankments and tie-ins to existing Moorebank Avenue road levels
 - signalling and intersection works.

1.2 Purpose and Application

This consolidated LVMSP has been prepared to assist in the monitoring and maintenance of landscape elements required for the Project and to address CoC B141(a). The LVMSP has been prepared by a suitably qualified and experienced person(s), and approved by the Secretary (DPE) prior to commencement of construction of permanent built surface works and/or landscaping. It is noted that changes to the



implementation timeframes have been agreed with DPE letter reference 19/630085 dated 25/07/2019. The most recent, approved version of this LVMSP will be implemented for the Project.

This LVMSP has been prepared for the entire Project Site. Area specific information is also included in this LVMSP and will be updated as per the staging detailed in Section 1.3.

1.3 Staging of this Plan

Delivery of this LVMSP will be staged (in accordance with CoC A14 and A15) to allow for the commencement of warehouse construction. The proposed staging of the LVMSP is shown on Figure 1-1 and detailed within Table 1. This LVMSP must be implemented prior to occupation of Warehouse 1 and/or the freight village, once approved by the Secretary in consultation with the Government Architect New South Wales (GANSW). Plan staging has been undertaken as per Table 1.

Works Area	Approximate Dates Plan Submission	Operational Area	Approximate Occupation Date
Area 1	Q2 2019	Warehouse 1 including area north of freight village	Interim OC 31/01/18
Area 2	Q2 2020	Warehouse 3, 4 and 5	Warehouse 3: Interim OC 20/03/20 Warehouse 4: Interim OC 22/05/20 Warehouse 5: Q4 2020
Area 3	Q2 2022	Warehouse 6 and 7	Q2 2023
Areas 4 – 6	ТВС	Warehouse 2, the freight village, Moorebank Avenue Upgrade	TBC ¹

Table 1: Staged submission of the LVMSP.

Note:

¹ Construction and occupational timing for Areas 4 – 6 is subject to market demand and future approvals.

1.3.1 Activities for the Stages

The activities associated with the stages include, but are not limited to:

- All ground preparation activities such as earthworks, services, on-site detention construction across the warehouses (managed through the Construction Environmental Management Plan and sub-plans, and Stormwater Management Plans)
- Upgrade works to Moorebank Avenue
- Construction and operation of the warehouses and freight village including:
 - construction and operation of parking facilities
 - construction and operation of internal road network and shared paths
 - installation of temporary solar lighting towers to illuminate roads and shared paths
 - landscaping
 - construction and operation of cycling and pedestrian facilities
 - installation of signage
 - construction and operation of end of trip facilities
 - construction and operation employee outdoor meal break areas.

The activities for the stages include construction activities such as bulk earthworks, landscaping, roads, pavements and carparks, and warehouse construction and fit-out.



1.3.2 Relationship to Future Stages

Area 1 was the first stage of this LVMSP and includes Warehouse 1 and the immediate area surrounding Warehouse 1 (excluding the freight village).

Area 2 was the second stage of this LVMSP and included Warehouses 3, 4 and 5 and surrounds.

The final stage of the LVMSP consolidated all areas into a final UDLP document, in order to demonstrate that the scheme and specific requirements of SSD 7628 have been achieved across the MPE Stage 2 Site. At the time of preparing the consolidated document, the detailed design and tenanting requirements for Areas 3 to 6 were not finalised. However, typical plans and drawings for these areas were developed based on what was approved for Area 1 and Area 2, and the requirements of the UDLP and this subplan (Appendix 3). They are therefore considered typical and representative of the urban design and landscape scheme that will be implemented across the site.

This LVMSP will be delivered as follows

- Area 1 details were prepared and approved by DPE prior to commencement of permanent built surface works and landscaping of Warehouse 1. This allowed the Project to commence construction of Warehouse 1, prior to the finalisation of the design for the remainder of the Project and did not restrict or constrain delivery of a compliant final detailed design across the remainder of the MPE Stage 2 Site.
- Area 2 was prepared and approved by DPE prior to commencement of landscaping of Warehouses 3, 4 and 5. Again, this allowed the Project to commence construction of warehousing in this Area, prior to the finalisation of the design for the remainder of the Project.
- The consolidated LVSMP included details for Areas 3 to 6. It was approved by DPE on 5 February 2021, prior to the commencement of permanent built surface works and/or landscaping of Warehouses 2, 6 and 7, the freight village (Area 4) and upgrade of Moorebank Avenue (Area 6).
- The consolidated UDLP, including this LVMSP, has been updated to reflect the amended layout for Area 3, reconfiguring Warehouses 6, 7 and 8 to two warehouses (Warehouses 6 and 7). The amended consolidated UDLP includes detailed design plans for Area 3 that are consistent with approved landscape plans for Areas 1 and 2. This updated UDLP, and including the updated LVMSP, has been submitted to DPE for information.

1.3.3 Triggers

The trigger for submission of the future stages of this LVMSP will be one month prior to permanent built surface works and/or landscaping of the next works area.



Urban Design and Landscape Plan



Figure 1-1 UDLP Staging



1.4 Compliance Matrices

The Project is being delivered under Part 4, Division 4.7 (previously Division 4.1 prior to 1 March 2018) of the EP&A Act. The CoCs include requirements to be addressed in this plan and delivered during the Project. These requirements and how they are addressed is provided within Table 2. Note that there are no specific CoC from approved modifications relating to this plan.

In Table 2, Primary Conditions are specific to the development of the management plans, while Secondary Conditions are conditions which are related to the environmental aspects associated with the plan.

Table 2 Conditions of Consent (CoCs)

CoC	Requirement	Document Reference	How Addressed		
Primary Condition					
B140	The UDLP must be prepared by a suitably qualified and experienced person(s), in consultation with the relevant council(s). The UDLP must be approved by the Secretary, in consultation with the NSW Government Architect.	Author Details (page ii and iii) Section 1.2 Section 1.5 Appendix 0A	This LVMSP has been prepared by a suitably qualified professional and in consultation with LCC, DPE and GANSW, as detailed in Section 1.5 and Appendix 0A. The consolidated UDLP including this subplan was approved by DPE on 5 February 2021.		
	A Landscape Vegetation Management Sub Plan to assist in the monitoring and maintenance of landscape elements required to delivered as part of the approval.	This plan	This LVMSP has been prepared to satisfy this condition.		
B141(a)	The Plan must be prepared and approved by the Secretary within twelve months of the date of this approval, unless otherwise agreed by the Secretary.	Section 1.2	This LVMSP has been prepared as a staged submission as detailed within Section 1.2. An extension of timing for implementation of these plans was agreed with DPE letter reference 19/630085 dated 25/07/2019.		
	The Plan must provide details of the monitoring and maintenance procedures for the landscape vegetation elements,	Section 2.3	Details of the monitoring and maintenance procedures are included in Table 4 of Section 2.3. The specific monitoring and maintenance procedures for Area 1 are outlined in Table 5.		
			The specific monitoring and maintenance procedures for Area 2 are outlined in Table 6.		
			Table 4, Table 5 and Table 6 provide details on the maintenance action, task, responsibility, timing, location and duration of the procedures.		
			Monitoring and maintenance procedures for Areas 3 to 6 will be consistent with those for Areas 1 and 2.		
	rehabilitated vegetation and landscaping (including weed and pathogen control)	Section 2.3 Section 2.4	All vegetation within the Project Site will be removed during Early Works and construction of the Project.		



CoC	Requirement	Document Reference	How Addressed
			Responsibilities and timing for weed and pathogen control are discussed in Section 2.3. Section 2.4 outlines the Project's approach to weed and pathogen control.
			For further detail on weed and pathogen control refer to the Operational Flora and Fauna Management Plan (OFFMP).
	including performance indicators, identification of commitments,	Section 2.1	Commitments and performance indicators relevant to landscape vegetation management are identified in Section 2.1.
	identification of the responsibilities of each entity involved in the management of the intermodal precinct including the overarching management responsibilities and obligations for common land and tenant responsibilities,	Section 2.3	Responsibilities for landscape and vegetation monitoring and maintenance procedures are identified in Table 4, Table 5 and Table 6 of Section 2.3.
	timing and duration,		Responsibilities for Areas 3 to 6 are consistent with those for Areas 1 and 2.
	as well as contingencies where rehabilitation of vegetation and landscaping measures fail.	Section 2.5	Contingencies where vegetation and landscaping measures fail are identified in Section 2.5.
	The approved plan must be implemented prior to occupation of the warehouse and freight village.	Section 1.3	Timing for implementation will be as per DPE letter reference 19/630085 dated 25/07/2019.
Seconda	ry Condition		
A14	With the approval of the Secretary, the Applicant may submit any strategy, plan or program required by this consent on a staged basis.	Section 1.3	The Secretary's approval for staging of this plan has already been obtained.
A15	If the submission of any strategy, plan or program is to be staged, then the relevant strategy, plan or program must clearly describe the specific stage of the development to which the strategy, plan or	Section 1.3	This LVMSP will be completed in stages as described in Section 1.3. This LVMSP defines the monitoring and maintenance of landscape vegetation on the site.
	program applies, the relationship of the stage to any future stages and the trigger for updating the strategy, plan or program		As outlined in Section 1.3.3, this LVMSP will be submitted to DPE one month prior to permanent built surface works and/or landscaping of the next stage.
B110	Prior to operation, the Applicant must prepare an Operational Flora and Fauna Management Plan (OFFMP) in consultation with OEH. The	Refer to MLP East Precinct OFFMP	All vegetation within the Project Site will be removed during Early Works and construction of the Project.
5110	OFFMP must form part of the OEMP required by condition C3 and must include measures to ensure biodiversity values not intended to be	Section 2.3 Section 2.4	Responsibilities and timing for weed and pathogen control are discussed in Section 2.3. Section 2.4 outlines the



CoC	Requirement	Document Reference	How Addressed
	impacted are protected, including but not limited to:		Project's approach to weed and pathogen control.
	(i) weed control		For further detail on weed and pathogen control refer to the OFFMP.
	The Applicant must: (a) take all reasonable steps to manage pests and vermin on the site;	Section 2.4 Refer to MLP East Precinct OFFMP	All vegetation within the Project Site will be removed during Early Works and construction of the Project. Responsibilities and timing for weed and pathogen control are discussed in Section 2.3. Section 2.4 outlines the Project's approach to weed and pathogen control. For further detail on weed and pathogen control refer to the OFFMP.
B127	(b) manage declared noxious weeds on the site in accordance with the requirements of the <i>Noxious Weeds Act 1993;</i> and	Section 2.4 Refer to MLP East Precinct OFFMP	All vegetation within the Project Site will be removed during Early Works and construction of the Project. Responsibilities and timing for weed and pathogen control are discussed in Section 2.3. Section 2.4 outlines the Project's approach to weed and pathogen control. For further detail on weed and pathogen control refer to the OFFMP.
	(c) inspect the site on a regular basis, no less than every 3 months to ensure that these measures are working effectively, and that pests, vermin or noxious weeds are not present on site in sufficient numbers to pose an environmental hazard, or cause the loss of amenity in the surrounding area. <i>Note: For the purposes of this condition,</i> <i>noxious weeds are those species subject to</i> <i>an order declared under the Noxious Weed</i> <i>Act 1993.</i>	Section 2.3 Refer to MLP East Precinct OFFMP	All vegetation within the Project Site will be removed during Early Works and construction of the Project. Responsibilities and timing for weed and pathogen control are discussed in Section 2.3. Section 2.4 outlines the Project's approach to weed and pathogen control. For further detail on weed and pathogen control refer to the OFFMP.
B140(p)	The UDLP must present an integrated urban and landscape design for the development, and must include, but not be limited to: details of where and how recommendations from the Bushfire Management Plan (condition B144) have been incorporated into the UDLP ,	Section 2.3 Table 4	Relevant requirements for management of the Inner Protection Area (IPA) detailed within Section F5.2 of the Bushfire Management Plan have been incorporated into the Monitoring and Maintenance Schedule within Table 4.

1.5 Consultation

This LVMSP has been prepared in consultation with Liverpool City Council (LCC), DPE and the Government Architect New South Wales (GANSW). Table 3 outlines the consultation that has taken place for this LVMSP. Supplementary information to support consultation undertaken is included in Appendix 0A of this sub plan, and Appendix 0F of the UDLP document.



Table 3 Consultation Summary

Agency	Date	Person Contacted	Comment	Status
	AREA 1			
	14/08/2018	LCC Representative	Draft UDLP and UDLP sub-plans emailed for review and comment	Closed
	14/08/2018	LCC Representative	Email requesting a meeting	Closed
	17/09/2018	LCC Representative	Email requesting a phone call	Closed
	21/09/2018	SIMTA	Email requesting a phone call regarding clarification on CoC A22, A23 and A24, as they relate to the above management plans	Closed
	02/10/2018	LCC Representative	Email requesting an update on progress of review	Closed
	03/10/2018	SIMTA	Email with reviewed plan, requesting feedback before finalisation	Closed
LCC	26/11/2018	LCC Representative	Email with updated UDLP and response to comments	Closed
	30/11/2018	SIMTA	Email confirming UDLP has been received for review	Closed
	23/01/2019	LCC Representative	Email requesting an update on progress of review	Closed
	23/01/2019	SIMTA	Email confirming review to occur within next week	Closed
	19/02/2019	SIMTA	Meeting request for 05/03/2019	Closed
	04/03/2019	LCC Representative	Meeting minutes sent via email	Closed
	06/03/2019	LCC Representative	Email with meeting minutes from 05/03/2019 meeting	Closed
	AREA 2			
	7/02/2020	LCC Representative	Email (from Aspect Environmental) requesting meeting	Closed
	13/02/2020	LCC Representative	LCC phone call requesting a meeting	Closed
	13/02/2020	LCC Representative	LCC provided UDLP documentation, advised that a meeting may not be required	Closed
	3/03/2020	LCC Representative	Aspect Environmental hand-delivered USB containing Area 2 UDLP documents to LCC. Phone call from LCC to confirm receipt of the USB, and to clarify request for comments in relation to Area 2	Closed
	4/03/2020	LCC Representative	Phone call and follow up email requesting an update on progress of review	Closed

SIMTA STERING

Agency	Date	Person Contacted	Comment	Status				
	10/03/2020	LCC Representative	Phone call requesting an update on progress of review, meeting suggested	Closed				
	18/03/2020	LCC Representative	Phone call requesting an update on progress of review	Closed				
	25/03/2020	LCC Representative	Phone call requesting an update on progress of review	Closed				
	1/04/2020	LCC Representative	Phone call requesting an update on progress of review	Closed				
	2/04/2020	LCC Representative	Council contacted Aspect Environmental to advise that LCC were preparing a compliance matrix table to communicate their concerns or issues, and which would be provided as soon as possible	Closed				
	16/04/2020	LCC Representative	LCC provided compliance matrix table to Aspect Environmental regarding concerns and comments	Closed				
	1/05/2020	LCC Representative	Aspect Environmental provided response to LCC comments and concerns	Closed				
	13/05/2020	LCC Representative	LCC provided email confirmation that Council has assessed all conditions in relation to Area 2 and deem the UDLP to be satisfactory	Closed				
	CONSOLIDATED (including AREAS 3 to 6)							
	26/06/2020	LCC Representative	Consolidated UDLP documentation for MPE Site provided to LCC for review and comment in relation to Areas 3 to 6	Closed				
	6/07/2020	LCC Representative	LCC email confirming that Consolidated UDLP documentation received for comment	Closed				
	7/07/2020	LCC Representative	Follow up email and phone call, to brief on Consolidated UDLP documentation	Closed				
	6/08/2020	LCC Representative	Email requesting an update on progress of review	Closed				
	7/08/2020	LCC Representative	Email confirmation from LCC that review is in progress	Closed				
	27/08/2020	LCC Representative	Phone call and email requesting an update on progress of review	Closed				
	9/09/2020	LCC Representative	Phone call and email requesting an update on progress of review	Closed				
	11/09/2020	LCC Representative	Email confirmation from LCC that review is in progress	Closed				

SIMTA STERATORIAL ALLANDE

Agency	Date	Person Contacted	Comment	Status
	28/09/2020	LCC Representative	LCC provided comments regarding the Consolidated UDLP	Closed
	16/10/2020	LCC Representative	Aspect provided response to Council comments	Closed
	AREA 1			
	28/08/2018	DP&E (on behalf of GANSW)	Presentation on UHIMS and UDLP at DP&E office	Closed
	05/09/2018	DP&E (on behalf of GANSW)	Draft plan emailed for review and comment	Closed
	18/10/2018	SIMTA	Email with table of review comments	Closed
	Various	Various	DP&E fortnightly meetings and emails discussing comments	Closed
	6/12/2018	DP&E (on behalf of GANSW)	Email with updated drawings and figures	Closed
	22/01/2019	DP&E (on behalf of GANSW)	Presentation on UDLP	Closed
	18/04/2019	DP&E (on behalf of GANSW)	Email updated UDLP and UDLP sub plans	Closed
GANSW	31/03/2020	DPE (on behalf of GANSW)	Updated UDLP provided to DPE as a result of amendments to the design of OSD 9 and resulting revisions to landscape design	Closed
	5/06/2020	DPE (on behalf of GANSW)	DPE – approval of updated Area 1 UDLP, excluding SSD 7628 CoC B140(e)(vi)	Closed
	20/08/2020	DPE (on behalf of GANSW)	Show Cause letter received by Qube regarding compliance with SSD 7628 CoC B140(e)(vi) for Area 1	Closed
	8/09/2020	DPE (on behalf of GANSW)	Aspect lodged SSD 7628 MOD 4 application with DPE regarding Area 1 exception to CoC B140(e)(vi) – car parking landscaping	Waiting response from DPE/GANSW
	28/10/2020	DPE (on behalf of GANSW)	Teams meeting with DPE to discuss SSD 7628 MOD 4 application	Closed
	AREA 2			
	6/08/2018	DPE (on behalf of GANSW)	Meeting with DPE, Aspect Environmental, Arcadis and Tactical Group to discuss issues to progress MPE UDLP	Closed
	27/02/2020	DPE (on behalf of GANSW)	Meeting between DPE and Aspect Environmental to update UDLP progress	Closed



Agency	Date	Person Contacted	Comment	Status			
	14/05/2020	DPE (on behalf of GANSW)	UDLP documentation for Area 2 provided to DPE (on behalf of GANSW)	Closed			
	19/06/2020	DPE (on behalf of GANSW)	DPE sent RFI providing GANSW/DPE comments for LVMSP and LSP for Area 2.	Closed			
	25/06/2020	DPE (on behalf of GANSW)	DPE sent RFI providing GANSW/DPE comments for SSP for Area 2.	Closed			
	7/07/2020	DPE (on behalf of GANSW)	Email requesting an update on provision of remainder of comments; advised by DPE that comments forthcoming	Closed			
	9/07/2020	DPE (on behalf of GANSW)	DPE sent RFI providing GANSW/DPE comments for UDLP, CPAFSP and EOMBASP for Area 2.	Closed			
	31/07/2020	DPE (on behalf of GANSW)	UDLP documentation for Area 2 updated and/or response provided to address DPE/GANSW comments	Closed			
	3/08/2020	DPE (on behalf of GANSW)	Follow up phone call to confirm receipt of updated UDLP documentation	Closed			
	3/08/2020	DPE (on behalf of GANSW)	Additional access to UDLP documentation requested by DPE and provided by Aspect, for DPE staff	Closed			
	12/08/2020	DPE (on behalf of GANSW)	UDLP, EOMBA and CPAFSP documentation for Area 2 updated and response provided to address DPE/GANSW comments	Closed			
	4/09/2020	DPE (on behalf of GANSW)	DPE – approval of updated Area 1 and Area 2 UDLP, excluding SSD 7628 CoC B140(e)(vi) for Area 1	Closed			
	CONSOLIDATED (including AREAS 3 to 6)						
	26/06/2020	DPE (on behalf of GANSW)	Consolidated UDLP documentation for MPE Site provided DPE (on behalf of GANSW)	Waiting response from DPE/GANSW			
	30/06/2020	DPE (on behalf of GANSW)	DPE confirmed by email that Consolidated UDLP documentation received for consultation and comment	Closed			
	7/07/2020	DPE (on behalf of GANSW)	As requested by DPE, link to documentation sent to GANSW independent reviewer	Closed			
	8/07/2020	DPE (on behalf of GANSW)	Follow up phone call and briefing with GANSW independent reviewer	Closed			

SIMTA STEREY INTERVODA

Agency	Date	Person Contacted	Comment	Status
	8/10/2020	DPE (on behalf of GANSW)	Phone call and email requesting an update on progress of review; DPE advised review process underway	Closed
	21/10/2020	DPE (on behalf of GANSW)	Phone call and email requesting an update on progress of review	Closed
	21/10/2020	DPE (on behalf of GANSW)	Comments regarding Consolidated UDLP documentation provided by DPE/GANSW	Closed
	4/11/2020	DPE (on behalf of GANSW)	Updated Consolidated UDLP documentation provided to DPE/GANSW for assessment	Closed
	5/02/2021	DPE (on behalf of GANSW)	Consolidated UDLP approved	Closed
	13/10/2022 (TBC)	DPE (on behalf of GANSW)	Consolidated UDLP, amended for the revised layout of Area 3, provided to DPE (on behalf of GANSW) for information	Waiting DPE response



2 IMPLEMENTATION

2.1 Landscape Planting

A proposed plant schedule for Area 1 is provided in Appendix 1, and a precinct-wide typical proposed plant schedule is provided in Appendix 0B. The schedules show that landscape planting will incorporate a range of canopy trees, shrubs, grasses and groundcovers across the MPE Site. A mixture of proposed species, planting densities and spacings, including the incorporation of low understory planting ranging to upright trees, will contribute to natural random environment continuity between the site, the streetscape and the public interface and articulate the random natural character of the existing landscape setting. Clumped plantings may be used to achieve the desired planting densities and spacings.

Proposed plant species have been selected for their site-suitability with many species selected from LCC's recommended plant list. Many of these species are consistent with the surrounding plant community types which will provide potential habitat connectivity as well as enabling the site to integrate into the surrounding environment.

In accordance with SSD 7628 CoC B140(e)(v) a minimum rate of 1 canopy tree per 30 m² will be provided across the MPE Site.

MPE2-GNK-LN-DWG-9000 (Appendix 0B) outlines the different soil horizons and provides typical specifications for proposed planting. The plan details the soil profile, which will be a minimum of 200 mm for turf, 400 mm for shrubs and mass planting and 450 mm for trees over a 45 litre (L) bag installation size, with a maximum depth of 600 mm. The top layer of soil will consist of 75 mm of mulch.

Garden bed planting of grasses, woody and herbaceous annuals and perennials that have high nutrient requirements for sustained optimum growth and are not subject to compaction by foot traffic will be planted within sandy loam to clay loam topsoil mix. Open granular well drained growing media is beneath the topsoil mix and will incorporate an aggregate drain with positive drainage connected to a site stormwater system. Planting will not be undertaken within the compacted site sub base, as the depth of soil will be specific to the pot sizing and species as nominated within the typical plant schedule provided in Appendix 0B (MPE2-GNK-LN-DWG-1000).

The typical proposed plant schedule includes:

- plant species (botanical name and common name)
- indication whether the plant is a native species
- expected canopy spread
- expected mature height
- install size.

Additionally and in accordance with CoC B140(f), the typical proposed plant schedule provides the following details:

- Pot size of trees will range from 140 mm to 100 L, shrubs will be 140 to 200 mm, and groundcover will be a minimum of 150 mm.
- Expected mature height of trees will range in height from 3 m to greater than 15 m, shrubs will range between 0.5 to 4 m and groundcover will range from creep to 1m.
- Expected canopy spread of trees will range from 3 to 18m, for shrubs is 0.5 to 4m, and groundcover is creep to 1 m.

Typical plant densities for the Precinct are expected to be similar to details provided for Area 1 (UDLA-02; Appendix 1), with plant densities for trees 5 to 6 m centres, for shrubs 0.5 to 2 m centres, and groundcover between 3 to 9 m^2 .

A low-volume drip irrigation system will be installed to support establishment and maintenance of proposed site landscaping. Rainwater tanks provided within each area will store rainfall collected from the warehouses and freight village building roofs for landscaping irrigation.



Whilst achieving the primary function for any requirement for water filtration and bio-retention, the planting proposed to the onsite detention (OSD) basins are to remain consistent with the overarching site wide objectives of uniform species use, endemic planting character, native landscape language and a variety of experiences and visual amenity from sites across the George's River. Increased treatment in the form of trees and planting will improve visual amenity, allowing the OSDs to act as a visual buffer to neighbouring sensitive receivers.

The indicative plant schedules are preliminary at this stage of the Project development; with confirmation of total plant numbers to be provided at the landscape detailed design stage.

2.1.1 Area 1

Where planting will occur, a mixture of site-suitable plant species has been selected as indicated in the landscape drawings (Appendix 1). A proposed plant palette for Area 1 is provided in Appendix 1 (UDLA-02). The schedule indicates potential tree, shrub, grass, sedge, climber and groundcover species to be used within Area 1 for the office open space and raingarden areas, as well as the overall area.

The proposed plant palette includes:

- plant species (botanical name and common name)
- indication whether the plant is a native species
- expected canopy spread
- expected mature height
- install size
- planting density.

Typical soil profile and planting specifications are outlined in Section 2.1. A rainwater tank, located underground in the northeast corner of Warehouse 1, will store rainfall collected from the Warehouse 1 roof for landscaping irrigation.

2.1.2 Area 2

The landscape design for Area 2 is included in Appendix 2. The overall landscaping strategy for Area 2 is consistent with that described above for Area 1 and detailed in Section 2.1, with regards to soil profiles, species composition, planting densities, rainwater harvesting and reuse for irrigation.

Typical proposed plant schedules for trees, shrubs, grasses and groundcovers, as well as species to be used for bio-retention areas and hydroseed mixes are provided in Appendix 0B.

As is the case for Area 1, a low-volume drip irrigation system will be installed to support establishment and maintenance of proposed site landscaping. The rainwater reuse tanks for irrigation use for Area 2 are located:

- Warehouse 3 north-eastern corner
- Warehouse 4 south-eastern corner
- Warehouse 5 under Warehouse 5 carpark

2.1.3 Area 3

Landscape design plans for Area 3 are provided in Appendix 3. Landscape details for Area 3 will be consistent with the landscaping strategies for Areas 1 and 2 and as detailed in Section 2.1, with regards to soil profiles, species composition, planting densities, rainwater harvesting and reuse for irrigation. Indicative tree and shrub species for Area 3 are provided in Appendix 3 (MPE-GNK-LN-DWG-3000) and typical proposed plant schedules for trees, shrubs, grasses and groundcovers, as well as species to be used for bio-retention areas and hydroseed mixes are provided in Appendix 0B.

The rainwater reuse tanks for irrigation use for Area 3 are located:

- Warehouse 6 north-eastern and north-western corners
- Warehouse 7 south-eastern and south-western corners.



Consistent with Areas 1 and 2, a low-volume drip irrigation system will be installed to support establishment and maintenance of proposed site landscaping within Area 3.

2.1.4 Area 4 and Area 5

Landscape designs for Area 4 and Area 5 are included in Appendix 4. The overall landscaping strategy for Area 4 and Area 5 is consistent with that described in the sections above with regards to soil profiles, species composition, planting densities, rainwater harvesting and reuse for irrigation.

Typical proposed plant schedules for trees, shrubs, grasses and groundcovers, as well as species to be used for bio-retention areas and hydroseed mixes are provided in Appendix 0B.

As is the case for Areas 1 and 2, low-volume drip irrigation systems will be installed within Area 4 and Area 5 to support establishment and maintenance of proposed site landscaping. The rainwater reuse tanks for irrigation use for these Areas are located:

- Freight village (Area 4) south-eastern corner
- Warehouse 2 (Area 5) north-western corner

2.1.5 Area 6

A landscape design for Area 6 is included in Appendix 3. The overall landscaping strategy for Area 6 is consistent with that described in the sections above with regards to soil profiles, species composition and planting densities. Where sufficient water is available in OSD 10 within Area 6 and is of appropriate water quality for irrigation use, OSD water may be used for irrigation of Area 6; otherwise, water carts may be used to irrigate Area 6, as required.

Typical proposed plant schedules for trees, shrubs, grasses and groundcovers, as well as species to be used for bio-retention areas and hydroseed mixes are provided in Appendix 0B.

2.2 Performance Indicators and Commitments

The following performance indicators will guide the monitoring and maintenance of landscaping and landscape vegetation:

- number of recorded instances of vegetation mortality, dieback, insect attack or fungal infection
- maintenance of landscape area percentages and canopy tree numbers as identified by the Landscape Plans (Appendix 1, Appendix 2, Appendix 3 and Appendix 0B).

Trends reporting on performance indicators will be used to guide any necessary rectifying actions.

The following specific commitments are made in relation to the monitoring and maintenance of landscaping and landscape vegetation:

- Undertake a landscape maintenance inspection once every two months which focuses on integrity of hard landscape elements, health of landscape vegetation and function of the irrigation system
- Undertake an annual arboreal and landscape health check, seeking advice from an AQF5 qualified arborist where required
- Remove weeds on a regular basis to limit the spread of weeds and minimise competition with landscape vegetation
- Replace failed, damaged or stolen plants when identified to maintain committed landscape area percentages and canopy tree numbers.

2.3 Monitoring and Maintenance

All existing vegetation within the Project Site will be removed (or where reasonable and feasible be relocated outside of the on-site landscape area and into the conservation area) and therefore there will be no opportunity for on-site rehabilitation of existing plants. The approach to monitoring and maintenance of landscaping and



landscape vegetation is outlined in Table 4, which also includes nominated timing and durations. A Landscape Maintenance Schedule for the Precinct is provided in Appendix 0B.

All monitoring and maintenance of common areas and the freight village will be managed by a singular entity (a maintenance contractor) that has been appointed by LOGOS. Monitoring and maintenance requirements within the limits of individual warehouses will be the responsibility of individual tenants, unless an independent contractor has been appointed under lease agreements specific to that tenant.

Monitoring and maintenance obligations are documented within the following documentation as well as Table 4. It will be the responsibility of individual tenants (for warehouses – unless otherwise agreed as part of lease arrangement) and the appointed maintenance contractor (for common areas and the freight village) to understand and undertake their obligations under these documents.

- Operational Environmental Management Plan (OEMP) which details the monitoring and maintenance requirements across various environmental aspects
- Operational Flora and Fauna Management Plan (OFFMP) which details measures for the management of weeds and pathogens
- Bushfire Management Plan (an appendix to the Emergency Response Plan) which details the monitoring and maintenance requirements specific to the Inner Protection Area (IPA) to minimise bushfire risk. It is noted that as per CoC B144 the entire site is managed as an IPA.

Table 4 Monitoring and Maintenance Schedule for the Project Site



Maintenance Action	Task	Responsibility*	Nominated Frequency	Location	Duration
Inspections	Landscape maintenance inspections will be conducted to identify landscaping that requires rectification/repair or areas of landscape planting that are in poor health	LOGOS	Every two months	Whole Project Site	Life of the Project
	Arboreal and landscape health check, seeking advice from an AQF5 qualified arborist where required	LOGOS	Annually	Whole Project Site	Life of the Project
	A low-volume drip irrigation system will be installed		Weekly	Landscaped areas with	
Watering	to allow regular watering to ensure continuous healthy plant growth	LOGOS	20-25 L/m ² of landscaped area	canopy trees, shrubs and vegetation	Life of the Project
	 Pruning work will maintain dense foliage conditions and encourage suitable growth habits Pruning of low tree branches 2 m from the ground to prevent a ground fire from spreading into the tree canopy 			Landscaped areas with canopy trees, shrubs and vegetation	Life of the Project
Pruning vegetation	 Any branches obstructing pathways and roads will be removed as directed by the Construction Manager, LOGOS Environmental Manager or Maintenance Contractor 	LOGOS	Every two months		
	 An approved wound dressing, such as 'Colgraft' will be applied to all cut surfaces in accordance with the manufacturer's instructions 				
	 Pruning will be undertaken in accordance with Australian Standard AS4373 where applicable 				
	 Separate and maintain tree crowns by at least 2 m so that the canopy is not continuous and 				

Maintenance Action	Task	Responsibility*	Nominated Frequency	Location	Duration
	does not encroach closer than 5 m to the buildings				
Weed / pest management	Manual removal or herbicide application before weeds are set.	LOGOS	Every two months	Whole Project Site	Life of the Project
	Insecticide and fungicide treatment will be undertaken in all occurrences of insect attack or disease in landscape vegetation.	LOGOS	As required	Whole Project Site	Life of the Project
Rubbish removal	Remove all rubbish from car parks, access roads, outdoor eating areas, warehouse entry ways and freight village	LOGOS/Warehouse Tenant	Weekly	Whole Project Site	Life of the Project
Removal of dead / dying plant material	Cut back and remove dead or dying plant material Keep areas under fences, gates and trees raked and clear of combustible fuels and keep strip and stormwater drainage pits free of leaf litter and combustibles	LOGOS	Every two months	Landscaped areas with canopy trees, shrubs and vegetation	Life of the Project
	Replace failed plantings with species and densities nominated in the Landscape Design, where possible	Construction Contractor	As required	Landscaped areas with canopy trees, shrubs and vegetation	Initial maintenance period
Replacement planting	Replace failed plantings with species and densities nominated in the Landscape Design, where possible	LOGOS*	As required	Landscaped areas with canopy trees, shrubs and vegetation	Life of the Project (excluding initial maintenance period)
	Replace plants lost due to vandalism or theft	LOGOS	As required	Landscaped areas with canopy trees, shrubs and vegetation	Life of the Project
Mulched surfaces	Mulched surfaces to be kept in a clean and tidy condition	LOGOS	Every two months	Landscaped areas	Life of the Project
	Mulch will be swept from other paved surfaces				

Maintenance Action	Task	Responsibility*	Nominated Frequency	Location	Duration
	Mulch will be reinstated to the depths of approximately 75 millimetres	LOGOS	As required	Landscaped areas	Life of Project
Specified soil / mulch levels	Specified levels of mulch will be maintained by lifting mulch, removing or adding topsoil mix and/or replacing mulch to the required levels	LOGOS	As required	Landscaped areas	Life of Project
Soil quality	Fertilizers (i.e. organic matter and nutrients) to be added as required for improvement of soil quality	LOGOS	As required	Landscaped areas	Life of Project
Drainage	Any areas of poor drainage will be rectified	LOGOS	As required	Whole Project Site	Life of Project
Stakes and ties	Stakes and ties will be adjusted and replaced as required.	LOGOS	As required	Landscaped areas	Life of Project
Raingardens	Regular ongoing and post-large rainfall inspections and maintenance of raingardens will be undertaken in line with measures outlined in the <i>Stormwater Infrastructure Operation and</i> <i>Maintenance Plan</i> (SIOMP), a subplan of the <i>Operational Environmental Management Plan</i> Maintenance activities will include: litter collection, minor replanting, repair of localised scouring, spot weeding, testing for contaminants and any other minor rectification works that are required.	LOGOS	As nominated in the Stormwater Infrastructure Operation and Maintenance Plan	OSDs	Life of Project
Grass cutting	Grass should be kept short and maintained in a clean and tidy condition, especially when adjacent to buildings activities may be reallocated depending on the specific needs	LOGOS	As required	Landscaped areas	Life of Project

* Responsibility of various activities may be reallocated depending on the specific needs of each warehouse tenant. In those cases, where LOGOS/Warehouse Tenant is nominated, LOGOS is responsible for common areas and the freight village, while the Warehouse Tenant is responsible for those activities within warehouse limits.



2.3.1 Area 1

Specific monitoring and maintenance requirements of landscaping and landscape vegetation, as well as appropriate nominated timing and durations within Area 1 are outlined in Table 5.

Table 5 Monitoring and Maintenance Schedule for Area 1

Maintenance Action	Task	Responsibility*	Nominated Frequency	Location	Duration
Upkeep of planter boxes and climbing plants	Watering	LOGOS	Bi-weekly	Employee outdoor meal break area in Warehouse 1	Life of Project
	Pruning of planter boxes and trellises	LOGOS	Every month	Employee outdoor meal break area in Warehouse 1	Life of Project
Clean and maintain rainwater harvest tank	Inspection and cleaning of catchment, gutters, filters and tank	LOGOS	Every month	Southeast corner of Warehouse 1	Life of Project

* Responsibility of various activities may be reallocated depending on the specific needs of each warehouse tenant. In those cases, where LOGOS/Warehouse Tenant is nominated, LOGOS is responsible for common areas and the freight village, while the Warehouse Tenant is responsible for those activities within warehouse limits.

2.3.2 Area 2 and Area 3

Specific monitoring and maintenance requirements of landscaping and landscape vegetation, as well as appropriate nominated timing and duration within Area 2 and Area 3 are outlined in Table 6.

Table 6 Monitoring and Maintenance Schedule for Area 2 and Area 3

Maintenance Action	Task	Responsibility*	Nominated Frequency	Location	Duration
Upkeep of planter boxes and climbing plants	Watering	LOGOS	Bi-weekly	Employee outdoor meal break areas in Warehouses 3, 4, 5	Life of Project
	Pruning of planter boxes and trellises	LOGOS	Every month	Employee outdoor meal break areas in Warehouses 3, 4,5, 6 and 7	Life of Project
		LOGOS	Every month	North-eastern corner of Warehouse 3	
Clean and maintain	Inspection and cleaning of catchment, gutters, filters and			South-eastern corner of Warehouse 4	Life of
maintain rainwater harvest tank				Carpark of Warehouse 5	Project
	tank			North-eastern and north-western corners of Warehouse 6	





* Responsibility of various activities may be reallocated depending on the specific needs of each warehouse tenant. In those cases, where LOGOS/Warehouse Tenant is nominated, LOGOS is responsible for common areas and the freight village, while the Warehouse Tenant is responsible for those activities within warehouse limits.

2.3.3 Area 4 and Area 5

The detailed design for warehousing in Area 5 and the freight village (Area 4) are currently not finalised. However maintenance, monitoring and responsibilities for landscaped elements will remain consistent with Areas 1 and Areas 2. Table 7 provides a typical schedule for these areas, which is to be confirmed at the development application stage.

Table 7 Monitoring and Maintenance Schedule for Areas 4 and 5

Maintenance Action	Task	Responsibility*	Nominated Frequency	Location	Duration
Upkeep of planter boxes and climbing plants	Watering	LOGOS	Bi-weekly	Employee outdoor meal break areas (where present)	Life of Project
	Pruning of planter boxes and trellises	LOGOS	Every month	Employee outdoor meal break areas (where present)	Life of Project
Clean and maintain rainwater harvest tank	Inspection and cleaning of catchment, gutters, filters and tank	LOGOS	Every month	Each rainwater tank (locations to be confirmed)	Life of Project

* Responsibility of various activities may be reallocated depending on the specific needs of each warehouse tenant. In those cases, where LOGOS/Warehouse Tenant is nominated, LOGOS is responsible for common areas and the freight village, while the Warehouse Tenant is responsible for those activities within warehouse limits.

2.3.4 Area 6

Landscaped elements that require specific maintenance and monitoring requirements (as per Table 5 – Table 7) are not applicable to Area 6, being the Moorebank Avenue upgrade area. Landscape maintenance and monitoring requirements for the landscaped areas along the alignment of Moorebank Avenue shall be undertaken in accordance with Table 4.

2.4 Weed and Pathogen Control

All existing vegetation and landscaping on the Project Site, will be removed during Early Works and construction phase of the development. Therefore, no existing vegetation or landscaping will be rehabilitated on the Project Site.

The approach to weed and pathogen control for newly landscaped areas is outlined below:

Insecticide and fungicide treatment: all occurrences of insect attack or disease in landscape vegetation
will be treated. Incorrect application of insecticide and fungicide treatment has the potential to impact upon
surrounding areas of native vegetation including Wattle Grove Offset Area, potentially resulting in the killing



of native vegetation in the Wattle Grove Offset Area. Therefore, insecticide and fungicide treatment will be undertaken in accordance with the following requirements:

- read the precautions and directions on labels
- appropriate protective clothing and equipment including: gloves, boots, overalls, goggles and respirator will be used
- open, pour and mix insecticides and fungicides on a stable surface in a well-ventilated area
- clean up any spills promptly
- avoid using insecticides and fungicides on windy days and prior to expected rainfall to reduce the likelihood of off-site impacts to surrounding vegetation
- avoid using insecticides and fungicides near food or people
- avoid the over-use of insecticides or fungicides.
- Weeding and rubbish removal: Weeds will be removed from around the base of the trees, planting areas, mulched areas and paths regularly so that at weekly intervals (at least) the landscape contract areas may be observed in a completely clean and tidy condition, free from rubbish and weeds. All weeds, debris, clippings etc. will be bagged and removed off site as soon as possible by the landscape contractor. Under no circumstances will the landscape contractor either burn off or stockpile weed clippings etc. on site.

2.5 Contingencies

Should landscaping be determined to have failed, i.e. vegetation perished, then it will be removed and replaced with vegetation that will provide a similar landscape function as soon as reasonable and feasible.

Where there have been multiple failures in the same area, soil testing or other investigations as deemed appropriate will be undertaken to determine the cause of failure. Appropriate treatments to the soil and/or cause of the failure will be implemented.



Appendix 0A – Evidence of Consultation



Qube Property Development Management Services Level 27, 45 Clarence Street Sydney NSW 2000

05/02/2021

Dear

Moorebank Precinct East Stage 2 (SSD 7628) Urban Design and Landscape Plan

I refer to your submission dated 4 November 2020 requesting approval of the consolidated Urban Design and Landscape Plan (UDLP), Revision 12, dated 18 December 2020, and associated Sub Plans required under condition B140 of SSI 7628. This plan has been staged with the approval of the Planning Secretary under condition A14 and A15 SSD 7628.

I acknowledge your response to the Department's review comments and requests for additional information. I note that these plans:

- have been reviewed by SMITA and no issues have been raised;
- have been prepared in consultation with Liverpool City Council; and
- have been reviewed by the Government Architect NSW.

I understand that the drawings accompanying the consolidated UDLP for the stages known as Areas 3 to 6 are indicative only and are subject to final detailed design. The consolidated UDLP and drawings for Areas 1 and 2 reflect the approved permanent built surface works and landscaping for these areas only.

I note that Liverpool City Council, and Government Architect NSW have been consulted on the indicative designs for Areas 3 to 6, and have provided comment, noting that these plans will need to be updated as the development of the site progresses. Further, I note your commitments to update the UDLP drawings and Sub Plans following detailed design.

Further, the consolidated UDLP and Sub Plans have satisfactorily demonstrated how Ecological Sustainable Development and Stormwater Management requirements have been incorporated into the overall design for MPE Stage 2, meeting the requirements for condition B140 (I) and (n).

I note that the UDLP has detailed how recommendations from the Heritage Interpretation Plan, required under condition B101, will be incorporated into the detailed design of the stage known as Area 4.

As nominee of the Planning Secretary, I approve the following documents under Condition B140 of SSD 7628 subject to you updating and resubmitting the UDLP and Sub-Plans for information with the detailed design for each future stage (Areas 3, 4, 5 and 6):

Document	Revision and date
Consolidated Urban Design and Landscape Plan	Rev 12, dated 18 December 2020
Cycling and Pedestrian Access and Facilities Sub Plan	Rev 7, dated 3 November 2020
Landscape Vegetation Management Sub Plan	Rev 8, dated 3 November 2020
Lighting Sub Plan	Rev 8, dated 3 November 2020
Employee Outdoor Meal Break Area Sub Plan	Rev 7, dated 3 November 2020
Signage Sub Plan	Rev 7, dated 3 November 2020

You must resubmit the updated UDLP and Sub-Plans, reflecting detailed design for each future stage, prior to commencement of permanent built surface works and/or landscaping for each stage, or as otherwise agreed by the Planning Secretary. The Department may request that you seek the Planning Secretary's approval of the UDLP and relevant sub-plans following detailed design for each stage if the 'for information' submission does not meet the requirements of the conditions of consent.

Further, I refer to the Planning Secretary nominee's letters dated 24 April 2020 and 4 September 2020 regarding the conditional approval for the MPE Stage 1 UDLP. These letters refer to the requirement for additional compensatory landscaping on MPE Stage 2. I note that the consolidated UDLP for MPE Stage 2 commits to delivering a minimum 14.2% of soft landscaping on the MPE Stage 2 site. When you have confirmed this following detailed design then the conditional approval of the UDLP for MPE Stage 1 will be resolved.

Please note, if there are any inconsistencies between the approved documents and the conditions of consent, then the requirements of the conditions of consent prevail.

Please ensure that the approved plans and drawing are placed on the project website at the earliest convenience.

further,

please

contact

matter



discuss the

As nominee of the Planning Secretary

lf

you wish to



Qube Property Development Management Services Level 27, 45 Clarence Street Sydney NSW 2000

04/09/2020

Dear

Moorebank Precinct East – Stage 2 (condition B140, SSI 7628) Urban Design and Landscape Plan

I refer to your submission dated 14 May 2020 requesting approval of the Urban Design and Landscape Plan (UDLP), Rev 9B dated 12 August 2020, and Sub Plans for Area 1 and Area 2 only in accordance with condition B140 of SSI 7628. I also acknowledge your response to the Department's review comments and requests for additional information. I note that these plans have been staged under condition A14 of SSD 7628.

The UDLP for Area 1 and Area 2 and associated Sub Plans have been reviewed and I note that these plans:

- have been reviewed by SIMTA and no issues have been raised
- have been prepared in consultation with Liverpool City Council
- have been reviewed by the Government Architect of NSW.

As nominee of the Planning Secretary, I approve the following documents under condition B140 and B141 for Area 1 and Area 2 only:

Document	Revision
Urban Design and Landscape Plan	Rev 9C, dated 12 August 2020
Landscape and Vegetation Management Sub Plan	Rev 6C, dated 31 July 2020
Lighting Sub Plan	Rev 6C, dated 31 July 2020
Cycling and Pedestrian Access and Facilities Sub Plan	Rev 5C, dated 12 August 2020
Employee Outdoor Meal Break Area Sub Plan	Rev 5C, dated 12 August 2020
Signage Sub Plan	Rev 5C, dated 31 July 2020

Please note that this approval does not extend to condition B140 (e)(vi) for Area 1, as this matter is still outstanding and has been referred to DPIE Compliance for review. I note that Area 2 meets the requirements of condition B140 (e)(vi).

I also note that the approved development layout plan has been amended (Reference: SSS2-RCG-AR-SKC-159, dated 11-08-2020). I approve the amended development layout under condition A22. I remind you that you must seek approval for any future changes made to the development layout of the site under condition A22.

You are also reminded that in my letter dated 24 April 2020, I approved the UDLP for MPE Stage 1 subject to you providing additional compensatory landscaping on MPE Stage 2. You must detail how this will be achieved in future stages of the MPE Stage 2 UDLP.

Further, in the subsequent consolidated UDLP and Sub Plans for the MPE Stage 2 site, you must satisfy all the requirements of condition B140 for the site overall, and must demonstrate that requirements not achieved in Areas 1 and 2 have been achieved overall. A copy of the review table containing outstanding matters will be provided to you for your reference.

Please note, if there are any inconsistencies between the approved documents and the conditions of consent, then the requirements of the conditions of consent prevail.

Please ensure that the approved plan is placed on the project website at the earliest convenience. If you wish to discuss the matter further, please contact

Yours sincerely





As nominee of the Planning Secretary



Good afternoon

As per my earlier phone call today, I am just checking that you received the following email on Friday in relation to the MPE Stage 2 UDLP. In accordance with DPIE's RFI, responses to DPIE/GANSW comments, and the updated Lighting Subplan, Signage Subplan and Landscape Vegetation Management Subplan for Area 2 were provided to DPIE. Additionally, the documents were uploaded to the DPIE portal on Friday afternoon.

The remainder of the MPE Stage 2 UDLP documentation and responses to DPIE/GANSW comments will be sent through as soon as possible.

Please let me know if you have any trouble accessing the documentation.

Kind regards,





in

From:

Sent: Friday, 31 July 2020 5:34 PM





Report to Dropbox

© 2020 Dropbox

DPE review comments - Condition B141(a) Landscape Vegetation Management Sub-Plan

SSD 7628 Mod 2 was approved on 31 January 2020 which included the removal of the requirement for maximum batters if 1V:4H for OSD 9 UDLP for Area 1 – Rev 8, dated 11/03/20

• SSD 762	28 Mod 2 v	vas approved on 31 January 2020 which included th	e removal of the requirement f	or maximum batters if 1V:4H for OSD	9 UDLP for Area 1 – Rev 8, dated 11/03/20	
CoC # and Requirements	Sec Ref	DPE Comment	Proponent Response	DPE Assessment (Rev 1 dated 15/6/18)	DPIE Comment May 20 (Rev 006B dated 08/05/20)	Proponent Response
B140 Prior to commencement of permanent built surface works and/or landscaping, or as otherwise agreed by the Secretary, and Urban Design and Landscape Plan (UDLP) must be prepared. The UDLP must be prepared by a suitably qualified and experienced person, in consultation with the relevant councils[and] in consultation with the NSW Government Architect. and must include but not be limited to: (j) the sub-plans identified in condition B141		 The Landscape Vegetation Management Sub-Plan (Revision 1 dated 15/6/18) was submitted to the Department on 1 July 2018 for consultation with the Government Architect NSW (GA). DPE notes that the Landscape Vegetation Management Sub-Plan was also sent to Liverpool City Council for comment along with the UDLP (as referenced in Appendix A of the UDLP) on 14/08/2018 although this is not noted in the current version of the plan. No specific comment about the plan from Liverpool City Council is included in Appendix A of the UDLP, however consultation was undertaken. DPE notes that following completion of GA consultation on 22/1/2019, their comments will be included in this review table as relevant. DPE notes that this submission is for the entire MPE precinct and will not be staged. Further action required. 1. Please confirm if this plan is not going to be staged as per the UDLP and remaining sub plans? 2. Please update the plan to evidence the consultation requirements (Liverpool City Council, and GANSW). B140 requires the UDLP and subsequent sub-plans to be prepared by a suitably qualified and experienced person(s). The Department notes that the author has 2 years' experience in environmental planning and assessment. Further action required. 3. Please clarify if the author, checker, and approver are suitably qualified and experienced person(s). 	 Area 5 – Warehouse 2 Area 6 – Moorebank Avenue 	 Noted reference to EONBASP should be LVMSP. Sec 1.3 and Table 1 updated with details of staging of the LVMSP. However, there is no formal request for the Secretary's approval to stage the LVMSP. Approval to stage the LVMSP in accordance with condition A14, to be noted in the approval for the UDLP and sub-plans under B140. Evidence of consultation with LCC is noted in Sec 1.5 with reference to Appendix A1 which contains letters from LCC: dated 3/10/2018 with comments on the UDLP but not the provided sub-plans; dated 21/01/2019 with additional comments, including for the LVMSP. There is no discussion about the issues raised by LCC nor how addressed in the LVMSP (required under condition A19(c). However, LCC note in response to the LVMSP that it is assessed as acceptable. The response table for GANSW is not included in Appendix A1, nor any discussion about the issues raised by GANSW or how addressed. OUTSTANDING COMMENT: Please update the LVMSP with evidence of consultation with GANSW with reference to the consolidated DPE/GANSW consolidated comments table as appropriate to the LVMP and include a discussion about the matters raised, how they have been addressed and how unresolved matters have been addressed, in accordance with condition A19(c). Noted details of suitably qualified person have been added. Satisfactory. 	The current version of this Plan (Rev 006B, dated 8 May 2020 – DOC 20/402154) has omitted content provided in the previous version (Rev 4, dated 6 June 2019 – DOC 19/635136). It is noted that the omitted content is noted in the Table of Contents for Rev 006B. The Plan's content is omitted from Section 1.4 onwards (ie. last Section is 1.3.3 & Figure 1-1: UDLP Staging). OUTSTANDING COMMENT: Evidence of GANSW consultation received by DPIE state: Neither the UDLP or the Landscape and Vegetation Plan have details of proposed species to be included. Provide more detailed plans which identify suitable large canopy trees and endemic and advanced tree species Drawings submitted in Appendices A2 & B2 of VMSP (Rev 006B) include detailed planting schedules. CLOSED Refer OVERALL DPIE COMMENT re updating LVMSP Rev 006B with content from LVMSP Rev 004.	The error in the document compilation as a PDF has been corrected. The complete document is now provided for comment

CoC # and Sec	c Ref	DPE Comment	Proponent Response	DPE Assessment	DPIE Comment May 20
Requirements			· ·	(Rev 1 dated 15/6/18)	(Rev 006B dated 08/05/20)
	ion 2.1	Section 2.1 includes performance indicators to guide the monitoring and maintenance of landscaping and landscape vegetation. Performance indicators that will be collected include recording instances of vegetation mortality, dieback, insect attach, or fungal infection. The plan states that Maintenance of landscape are percentages and canopy tree numbers as identified by the Landscape Plans (Appendix B in the UDLP). Further information on procedures is detailed in the review below.	Noted.	CLOSED	
B141(a)S 1The Plan must be prepared and approved by the Secretary within twelve months of the date of this approval, unless otherwise agreed by the Secretary.		SSD-7628 was approved on 31 January 2018. This plan was submitted on 1 July 2018, less than twelve months from the date of this approval. Satisfactory (if not resubmitting a staged plan).	Noted.	CLOSED	
B141(a)S 2The Plan must provide details of the monitoring and maintenance procedures for the landscape vegetationS 2elements, rehabilitated vegetation and landscaping (including weed and pathogen control) including performance indicators, identification of commitments, identification of the responsibilities of each entity involved in the management of the 	2.3 2.1 2.4	 Monitoring & Maintenance for landscape, vegetation elements Table 2 in Section 2.2 details the monitoring and maintenance schedule that will be implemented during operation. This includes, the timing of maintenance actions and the tasks that are applicable to those actions. What are the landscape vegetation elements? Please include a figure demonstrating this. Please clarify what methodology will be used to identify which vegetation should be pruned for safety. As the UDLP details the species to be planted within the Warehouse 1 Precinct, include a program for specific, species related monitoring and maintenance. Please also detail how the pruning of trees will be undertaken in order to preserve the beneficial contribution to the Urban Heat Island Mitigation Strategy (UHIS). Mulched Surfaces - (a) Please outline why two months was the chosen timeframe for keeping mulched surfaces clean & tidy. (b) Reinstating of mulch levels requires more information for the timing, as "periodically" is not a defined time period. Include a figure at appropriate scale which clearly demonstrates where the vegetated areas are, and delineate the management measures required to maintain viable plantings. Rehabilitated vegetation and landscaping (including weed and pathogen control) 	 4. The landscape drawings for Area 1 have been included in Appendix A2. The landscape drawings demonstrate the landscape vegetation elements including OSD planting, garden beds, canopy trees, and landscaping proposed for the employee outdoor meal break area. 5. Table 4 Maintenance Action 'Pruning vegetation for safety' has been updated to state the following: 'Pruning work will maintain dense foliage conditions and encourage suitable growth habits. Any branches obstructing pathways and roads will be removed as directed by the Operations Manager, Qube Safety, Health and Environmental Manager or Maintenance Contractor.'' Species-specific monitoring and maintenance requirements have not been included as the LVMSP outlines a holistic approach across the Precinct for all species. This is considered appropriate and in line with standard maintenance regimes and applicable to the species outlined in the planting schedule in Appendix A2. 6. Pruning of trees will be undertaken in accordance with Australian Standard AS4373 to improve the safety, structure, health and beauty of the tree. Maintenance of the canopy trees will not have a significant impact on the reduction of the urban heat island effect as the trees will not be removed. 7(a) Two months is appropriate as it ensures consistency with landscape maintenance inspections that will be undertaken every two months. (b) Updated to "As required". Landscape maintenance inspections that will be undertaken every two months will identify whether or not additional mulch is required to maintain soil depths identified in the UDLP. 	 Appendix A2 includes 'Area 1 Masterplan' which shows the plant palette for trees, shrubs and grasses; tank planter box lid plant palette; and office open space planter plant palette; as well as rain garden plant palette on MPW site. Landscape elements are numbered and described. Appendix A2, Landscape element 9 shows a continuous planting of tall upright trees (red ironbark) along the northern side of the carpark which is inconsistent with the requirements of B140(e)(vi) which requires 2.5m wide landscaped bays every 6-8 car spaces. &3. Update to Table 4 noted. Pruning measures to address heat island benefit include maintaining dense foliage and sustainable growth. Satisfactory. Snoted figure in Appendix A2 shows vegetated areas. Management measures updated in Table 4, showing locations of monitoring and maintenance schedule. Satisfactory. Update to Sec. 2.3 with precautions to prevent impact of herbicides on Wattle Grove conservation area. Satisfactory. Yupdates to Tables 4 and 5 noted, including GA nominated measures as listed in DPE comment. However, as noted above, evidence of GA consultation has not been included. OUTSTANDING COMMENT: As noted above, please update the LVMSP with evidence of consultation with GANSW and include a discussion about the matters raised, how they have been addressed, in accordance with condition A19(c). 	Comment on Rev 006B LVMSP Rev 006B includes: - Section 1.2 states that this Landscape Vegeta Management Sub-Plan (LVMSP) has been pre- entire Project site with area specific information and updated as per the staging details in section - Section 1.3 states that the LVMSP will be imp- prior to the occupation of Warehouse 1 (WH1) Table 1 (staged submission of this LVMSP) sta- staging will occur as follows: Area 1 – Q2 2019 Area 2 – Q2 2020 Area 3 - TBC - the final section in Rev 006B is Section 1.3.3 that the trigger for submission of future stages LVMSP is one month prior to permanent built s- works and or landscaping for the next works ar - Appendices A2, B2 & G contain area master landscape drawings including detailed planting (native species, size planted/mature & density) as follows: * A2 (Area 1 - WH1) - UDLA-02 dated 04/06/19 notes 1. Proposed mix of native grasses on OS planter box. This is inconsistent with other plan state that the OSD is open and concrete lined. drawing also includes planting schedules for: r- on MPW and office open space. * B2 (Area 2 – WH3 &WH4) - W3W4-GNK-LN dated 21/02/20, Issue 10 which includes of two * B2 (Area 2 – WH3 wH4) - W3W4-GNK-LN dated 21/02/20, Issue 10 which includes for: r- on MPW and office open space. * B2 (Area 2 – WH5) - W5-GNK-LN-DWG-1007 24/02/20 Rev G – notes proposed canopy tree 2.5m carpark bays spaced every 6-8 car space native tree canopy species to screen warehous canopy trees in 1,039m ² = 1 tree/21m ² - compr pages with second including plant schedule. * G (typical garden detail) – UDLA-06 – notes of including depths for 75mm mulching layer (75m planting (800), drip irrigation & ag drain, import types, surfaces & kerbing to engineer's specific Comment on Rev 004 LVMSP Rev 004 includes: - monitoring and maintenance which is detailed 2.2 together with scheduling in Table 4 that inco- various actions/landscape elements (including pathogen control), details of the task, responsil frequency, location and d

	Proponent Response
etation prepared for the ion included tion 1.3. nplemented 1) in Area 1. states that	
.3 which states ss of this t surface area. er plan ng schedules ty) for the site	
'19 Issue F – OSD tank lid lans which d. This : rain garden	This inconsistency has been corrected and the plan has been updated to reflect that the OSD is open and concrete lined
N-DWG-2001 wo pages. 001 dated ee plant in lices, mix of puses and 48 iprised of two	
s details 5mm) & tree orted soil ifications,	
led in Section ncludes ng weed and sibility, e life of the	
ty for on-site ing vegetation ere reasonable	


CoC # and Requirements	Sec Ref	DPE Comment	Proponent Response	DPE Assessment (Rev 1 dated 15/6/18)	DPIE Comment May 20 (Rev 006B dated 08/05/20)	Proponent Response
		 Maintenance of landscape are percentages and canopy tree numbers as identified by the Landscape Plans (Appendix B in the UDLP). Further information on procedures are detailed in the review below. Please update the plan to capture the outcomes of GA consultation, namely, any management measures that will arise from the proposed planting schedules e.g. maintaining soil permeability, maintaining viability of plantings, water-harvesting and re-use, maintaining soil quality etc. Identification of the responsibilities of each entity involved in the management responsibilities and obligations for common land and tenant responsibilities. Iming and duration DPE notes that the operator will be responsible for the monitoring and maintenance of landscaping on the site rather than individual tenants. These obligations will be documented within the OEMP for the MPE site (and for each progressive stage). If staging the plan, please update to reflect staging, and also the updates required prior to the construction of permanent built works for the freight village. As well as contingencies where rehabilitation of vegetation and landscaping measures fail. DPE notes if landscaping fails, then it will be removed and replaced with vegetation that will provide a similar landscape function as soon as reasonable and feasible. Where multiple failures occur in the same area, soil testing or other investigations will be undertaken, and appropriate treatments implemented. Please remove the sentence "The species and densities nominated in the Landscape Plans will be planted where the approved UDLP states they will be planted where the approved UDLP states they will be planted where the approved UDLP states they will be planted where the approved UDLP states they will be planted. Please update the plan to include the monitoring and maintenance of vegetation in the Employee Outdoor Meal Break Areas. 	 8. Appendix A2 includes landscape drawings which outline where all the vegetated areas are located for Area 1. Appendix G outlines the landscaping for the entire MPE Stage 2 area. Table 4 and 5 have been updated to include a new column identifying the location of where maintenance actions should be undertaken. 9. Section 2.3 of this plan has been updated to state Insecticide and fungicide treatment: all occurrences of insect attack or disease in landscape vegetation will be treated. Incorrect application of insecticide and fungicide treatment has the potential to impact upon surrounding areas of native vegetation including Wattle Grove Offset Area, potentially resulting in the killing of native vegetation in the Wattle Grove Offset Area. Therefore, insecticide and fungicide treatment will be undertaken in accordance with the following requirements: Read the precautions and directions on labels Appropriate protective clothing and equipment including: gloves, boots, overalls, goggles and respirator will be used Open, pour and mix insecticides and fungicides on a stable surface in a well-ventilated area Clean up any spills promptly Avoid using insecticides and fungicides on a stable surface in a well-ventilated area Clean up any spills promptly Avoid using insecticides and fungicides on in surrounding vegetation Avoid using insecticides and fungicides on component in cluding index to reduce the likelihood of off-site impacts to surrounding vegetation Avoid using insecticides and fungicides on people Avoid the over-use of insecticides or fungicides. 		-	 Table 1 has been updated to provide plan submission date expectations and occupation certificate details. This is now consistent across all subplans. All sections of the document are now provided. Section 2.3.2 provides maintenance and monitoring requirements for Area 2. Areas 3 – 6 are to be provided as part of subsequent updates to the Subplan. Appendix A2 has been updated (UDLA-02 dated 31/07/20) to remove OSD lid planter box. An additional plan has been provided in Appendix A2 (UDLA-07 dated 11/03/20) which quantifies hard and soft landscaping areas for Area 1. It is noted that landscaped area requirements, as per Condition B140 of SSD 7628, are based on the entire MPE Stage 2 Site, and are not a requirement for each individual area. The consolidated UDLP (covering all Areas) will demonstrate compliance with landscaping requirements. Section 2.3 and Table 4 – 6 have been updated to clarify roles and the freight village. Maintenance and monitoring requirements within the limits of individual averables will be the tenants' responsibility. Maintenance contractor sand tenants will be required to understand and implement maintenance and monitoring requirements will be required to understand and implement maintenance and monitoring requirements.

CoC # and Requirements	Sec Ref	DPE Comment	Proponent Response	DPE Assessment (Rev 1 dated 15/6/18)	DPIE Comment May 20 (Rev 006B dated 08/05/20)	Proponent Response
			 Maintain soil permeability Rainwater harvest tank maintenance Improving soil quality 11. Section 1.3 has been included to indicate that the LVMSP will be staged in accordance with the UDLP. 12. Sentence removed. 13. Monitoring and maintenance of vegetation in Employee Outdoor Meal Break Areas for Warehouse 1 has been included in Table 5. 			under the approved OEMP, OFFMP and BMP. - This version of the LVSMP is relevant to Areas 1 and 2 only. Areas 3 – 6 will form part of a consolidated UDLP (a draft of which has recently been provided to DPIE for comment). The LVSMP supporting the consolidated UDLP will include Masterplans for the whole site (i.e. Areas 1 – 6).
B141(a) The approved plan must be implemented prior to occupation of the warehouse and freight village.	S 1.3	 Section 1.3 state that the "LVMSP must be implemented prior to occupation of the warehouses and freight village.". 12. Please update this to be consistent with the current planned staging of the plans i.e. will be implemented prior to the occupation of warehouse 1 etc. 	12. Section 1.3 has been included to indicate that the LVMSP will be staged in accordance with the UDLP.	12.Noted CLOSED	Section 1.3 states that the LVMSP will be implemented prior to the occupation of Warehouse 1 (WH1) in Area 1. Table 1 (staged submission of this LVMSP) states that staging will occur as follows: Area 1 – Q2 2019 Area 2 – Q2 2020 Area 3 - TBC Refer OVERALL DPIE COMMENT.	Table 1 has been updated to provide plan submission date expectations and occupation certificate details. This is now consistent across all subplans.Section 1.3.3 (Triggers) has also been updated to clarify implementation and staging of the subplan.
B127 The Applicant must: (a) Take all reasonable steps to manage pests and vermin on the site; (b) Manage declared noxious weeds on the site in accordance with the requirements of the Noxious Weeds Act 1993; (c) Inspect the site on a regular basis, no less than every 3 months, to ensure that these measures are working effectively, and that pests, vermin or noxious weeds are not present on site in sufficient numbers to pose and environmental hazard, or cause the loss of amenity in the surrounding area.		 DPE notes that this condition is not cross referenced in this plan. 11. Please update the plan to include a cross-reference to this condition, i.e. Operational Flora and Fauna Management Plan etc. 	14. This condition has been included in Section 1.4 Compliance Matrices – <i>Table 2 Additional Conditions of</i> <i>Consent (CoC)</i> and refers to the MLP East Precinct OFFMP. Note the <i>Noxious Weeds Act 1993</i> was repealed in June 2017 and replaced with the <i>Biosecurity Act 2015</i> .	11.Noted CLOSED	LVMSP Rev 006B doesn't include the compliance table from LVMSP Rev 004 (Table 2) which refers to the MPE OFFMP. It is noted that Section 2.3 of LVMSP Rev 004 discusses weed and pathogen control. Refer OVERALL DPIE COMMENT .	The error in the document compilation as a PDF has been corrected. The complete document is now provided for comment
B110 Prior to operation, the Applicant must prepare an Operational Flora and Fauna Management Plan (OFFMP) in consultation with OEH. The OFFMP must form part of the OEMP required by condition C3 and must include measures to ensure biodiversity values not intended to be impacted are protected, including but not limited to: (i) Weed control		As above.	This condition has been included in Section 1.4 Compliance Matrices – <i>Table 2 Additional Conditions of</i> <i>Consent (CoC)</i> and refers to the MLP East Precinct OFFMP.	Noted CLOSED	Included in Compliance Table (Table 2) for LVMSP Rev 004 with reference to MPE OFFMP. Refer OVERALL DPIE COMMENT.	The error in the document compilation as a PDF has been corrected. The complete document is now provided for comment

NOTES

The current version of this Plan (Rev 6B, dated 8 May 2020 – DOC 20/402154) has omitted content provided in the previous version (Rev 4, dated 6 June 2019 – DOC19/635136). It is noted that the omitted content is noted in the Table of Contents for Rev 6B. The Plan's content is omitted from Section 1.4 onwards (ie. last Section is 1.3.3 & Figure 1-1: UDLP Staging.

- Appendix A Area 1 missing
- Appendix A1 Evidence of consultation has not been updated since the previous version (Rev 4)

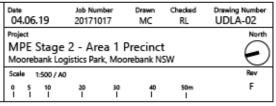

- Appendix B Area 2 cover page included
- Appendix B1 Evidence of Consultation includes DPIE initial review comments and Proponent response & notes GANSW comments not yet rec'd this is included in above table
- Appendix B2 Landscape Drawings included


Date 21-02-20	Jab Na 20190		Drawn KF	Checked RL	Drawing Number W3W4-GNK-LN-DWG-2001
Project Wareh Moorebar				P abank NSW	North
Scale 1.7	50 @ A1				Rev
0 5 I I	10 15 I I	20m I			10

Date 24-02-20	Job Number 20190511	Drawn KF	Checked RL	Drawing Number W5-GNK-LN-DWG-1001
	ouses 5 U nk Logistics P	North		
	50 @PA1 10 15 20m			Rev G

- Appendix C-F Area 3-6 (Provision for Future Stages) all missing.
- Appendix G Typical Garden Detail included





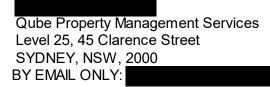

05/06/2020

Dear

Approval of Urban Design and Landscape Plan – Moorebank Logistics Park East (SSD 7628)

I refer to your correspondence requesting the Planning Secretary's approval for the staged Urban Design and Landscape Plan (UDLP) for Area 1 only under condition B140 of SSD 7628. This plan has been staged with the approval of the Planning Secretary in accordance with the requirements of conditions A14 and A15.

The UDLP for Area 1 has been carefully reviewed and I note that the plan:

- has been reviewed by SIMTA and no issues have been raised
- has been prepared in consultation with Liverpool City Council
- has been reviewed by the Government Architect of NSW.

As nominee of the Planning Secretary, I approve the UDLP for Area 1 (Revision 8, dated 11 March 2020) only pursuant to condition B140, <u>excluding condition B140 (e)(vi)</u>.

I also approve the amended development layout plan (Reference: SSS2-RCG-AR-SKC-161A), including the amended layout of OSD 9 pursuant to condition A22 of SSD 7628.

I note that the landscaping for the as-constructed car park within Area 1 does not satisfy the requirements of condition B140(e)(iv) and has therefore not been approved. This matter has been referred to the Department's Compliance team for review.

I note that Area 1 does not achieve all the minimum landscaping requirements of condition B140. However, I note your commitment that future stages will achieve the minimum landscaping requirements of condition B140 for the MPE Stage 2 overall. You are also reminded that in my letter dated 24 April 2020, I approved the changes to the UDLP for MPE Stage 1 subject to you providing additional compensatory landscaping on MPE Stage 2. You must detail how this will be achieved in future stages of the MPE Stage 2 UDLP.

You are reminded that If there is any inconsistency between the approved documents and the conditions of consent, then the requirements of the conditions of consent will prevail.

If you require any further information please contact

Yours sincerely



As nominee of the Planning Secretary

DPE review comments - Condition B141(a) Landscape Vegetation Management Sub-Plan, Rev 1 dated 15/6/18

Condition No.	Section Reference	DPE Comment	Proponent Response
B140 Prior to commencement of permanent built surface works and/or landscaping, or as otherwise agreed by the Secretary, and Urban Design and Landscape Plan (UDLP) must be prepared. The UDLP must be prepared by a suitably qualified and experienced person, in consultation with the relevant councils[and] in consultation with the NSW Government Architect. and must include but not be limited to: (j) the sub-plans identified in condition B141		 The Landscape Vegetation Management Sub-Plan (Revision 1 dated 15/6/18) was submitted to the Department on 1 July 2018 for consultation with the Government Architect NSW (GA). DPE notes that the Landscape Vegetation Management Sub-Plan was also sent to Liverpool City Council for comment along with the UDLP (as referenced in Appendix A of the UDLP) on 14/08/2018 although this is not noted in the current version of the plan. No specific comment about the plan from Liverpool City Council is included in Appendix A of the UDLP, however consultation was undertaken. DPE notes that following completion of GA consultation on 22/1/2019, their comments will be included in this review table as relevant. DPE notes that this submission is for the entire MPE precinct and will not be staged. Further action required. 1. Please confirm if this plan is not going to be staged as per the UDLP and remaining sub plans? 2. Please update the plan to evidence the consultation requirements (Liverpool City Council, and GANSW). B140 requires the UDLP and subsequent sub-plans to be prepared by a suitably qualified and experienced person(s). The Department notes that the author has 2 years' experience in environmental planning and assessment. Further action required. 3. Please clarify if the author, checker, and approver are suitably qualified and experienced to prepare a landscape vegetation management plan. 	 This LVMSP has been updated in Section 1.3 to include the different stages associated with this plan. The stages of this plan include: Area 1 – Warehouse 1 including area north of freight village Area 2 – Warehouse 3, 4 and 5 Area 3 – Warehouse 6, 7 and 8 Area 4 – Freight village Area 5 – Warehouse 2 Area 6 – Moorebank Avenue Works Section 1.3.2.outlines the following: "Area 1 is the first stage of this LVMSP and includes Warehouse 1 and the immediate area surrounding Warehouse 1 (excluding the freight village). The detailed plans for future stages, i.e. Areas 2 – 6, of this LVMSP are anticipated to be provided in multiple submissions as described in Table 1. Each future staged submission will be incremental and present the detailed maintenance and monitoring requirements for that stage." Reference to W1P has also been removed throughout the entire document. As outlined in Section 1.3.3, the trigger for updating this LVMSP will be submitted one month prior to permanent built surface works and/or landscaping of the next stage. Section 1.5 has been updated to include the consultation with LCC for the UDLP and UDLP subplans. Appendix A1 has also been added and includes the evidence of consultation with LCC and the response table for GANSW.

Condition No.	Section Reference	DPE Comment	Proponent Response
			3.
B141 (a) A Landscape Vegetation Management Sub Plan to assist in the monitoring and maintenance of landscape elements required to delivered as part of the approval.	This plan Section 2.1	Section 2.1 includes performance indicators to guide the monitoring and maintenance of landscaping and landscape vegetation. Performance indicators that will be collected include recording instances of vegetation mortality, dieback, insect attach, or fungal infection. The plan states that Maintenance of landscape are percentages and canopy tree numbers as identified by the Landscape Plans (Appendix B in the UDLP). Further information on procedures is detailed in the review below.	Noted.
The Plan must be prepared and approved by the Secretary within twelve months of the date of this approval, unless otherwise agreed by the Secretary.	S 1.3	SSD-7628 was approved on 31 January 2018. This plan was submitted on 1 July 2018, less than twelve months from the date of this approval. Satisfactory (if not resubmitting a staged plan).	Noted.
The Plan must provide details of the monitoring and maintenance procedures for the landscape vegetation elements, rehabilitated vegetation and landscaping (including weed and pathogen	S 2.2 S 2.3	 <u>Monitoring & Maintenance for landscape, vegetation elements</u> Table 2 in Section 2.2 details the monitoring and maintenance schedule that will be implemented during operation. This includes, the timing of maintenance actions and the tasks that are applicable to those actions. 4. What are the landscape vegetation elements? Please include a figure demonstrating this. 	4. The landscape drawings for Area 1 have been included in Appendix A2. The landscape drawings demonstrate the landscape vegetation elements including OSD planting, garden beds, canopy trees, and landscaping proposed for the employee outdoor meal break area.
control) including performance indicators, identification of commitments, identification of the responsibilities of each entity involved in the management of the intermodal	S 2.1 S 2.4	 Please clarify what methodology will be used to identify which vegetation should be pruned for safety. As the UDLP details the species to be planted within the Warehouse 1 Precinct, include a program for specific, species related monitoring and maintenance. 	5. Table 4 Maintenance Action 'Pruning vegetation for safety' has been updated to state the following: "Pruning work will maintain dense foliage conditions and encourage suitable growth habits. Any branches obstructing pathways and roads will be removed as directed by the Operations Manager, Qube Safety,

Condition No.	Section Reference	DPE Comment	Proponent Response
precinct including the			Health and Environmental Manager or Maintenance
overarching management		6. Please also detail how the pruning of trees will be	Contractor."
responsibilities and obligations		undertaken in order to preserve the beneficial	
for common land and tenant		contribution to the Urban Heat Island Mitigation	Species-specific monitoring and maintenance
responsibilities, timing and		Strategy.	requirements have not been included as the LVMSP
duration, as well as		7. Mulched Surfaces –	outlines a holistic approach across the Precinct for all
contingencies where		(a) Please outline why two months was the chosen	species. This is considered appropriate and in line with
rehabilitation of vegetation and		timeframe for keeping mulched surfaces clean &	standard maintenance regimes and applicable to the
landscaping measures fail.		tidy.	species outlined in the planting schedule in Appendix A2.
1 5		(b) Reinstating of mulch levels requires more	
		information for the timing, as "periodically" is not	6. Pruning of trees will be undertaken in accordance with
		a defined time period.	Australian Standard AS4373 to improve the safety,
		8. Include a figure at appropriate scale which clearly	structure, health and beauty of the tree. Maintenance of
		demonstrates where the vegetated areas are, and	the canopy trees will not have a significant impact on the
		delineate the management measures required to	reduction of the urban heat island effect as the trees will
		maintain viable plantings.	not be removed.
		Rehabilitated vegetation and landscaping (including weed and	
		pathogen control)	7(a) Two months is appropriate as it ensures consistency
			with landscape maintenance inspections that will be
		The Department notes that all vegetation within the Project	undertaken every two months.
		site is to be removed. The weed/pest management in section	
		2.2 is noted. The Department notes the further description of	(b) Updated to "As required". Landscape maintenance
		weed and pathogen control outlined in section 2.3.	inspections undertaken every two months will identify
			whether or not additional mulch is required to maintain
		9. The impacts of the insecticide and fungicide	soil depths identified in the UDLP.
		treatment upon the Wattle Grove Offset Area is not	
		outlined. Please update this sub-plan to specify	8. Appendix A2 includes landscape drawings which
		the impact that the weed and pathogen may have	outline where all the vegetated areas are located for
		on the offset areas for the project.	Area 1. Appendix G outlines the landscaping for the
			entire MPE Stage 2 area. Table 4 and 5 have been
		Including performance indicators, identification of	updated to include a new column identifying the location
		<u>commitments</u>	of where maintenance actions should be undertaken.
		Section 2.1 includes performance indicators to guide the	9. Section 2.3 of this plan has been updated to state
		monitoring and maintenance of landscaping and landscape	Insecticide and fungicide treatment: all occurrences
		vegetation. Performance indicators that will be collected	of insect attack or disease in landscape vegetation
		include recording instances of vegetation mortality, dieback,	will be treated. Incorrect application of insecticide
		insect attach, or fungal infection. The plan states that	and fungicide treatment has the potential to impact

Condition No. Section Reference	DPE Comment	Proponent Response
	 Maintenance of landscape are percentages and canopy tree numbers as identified by the Landscape Plans (Appendix B in the UDLP). Further information on procedures are detailed in the review below. 10. Please update the plan to capture the outcomes of GA consultation, namely, any management measures that will arise from the proposed planting schedules e.g. maintaining soil permeability, maintaining viability of plantings, water-harvesting and re-use, maintaining soil quality etc. <i>Identification of the responsibilities of each entity involved in the management of the intermodal precinct including the overarching management responsibilities, timing and duration</i> DPE notes that the operator will be responsible for the monitoring and maintenance of landscaping on the site rather than individual tenants. These obligations will be documented within the OEMP for the MPE site (and for each progressive stage). 11. If staging the plan, please update to reflect staging, and also the updates required prior to the construction of permanent built works for the freight village. As well as contingencies where rehabilitation of vegetation and landscaping measures fail. DPE notes if landscaping fails, then it will be removed and replaced with vegetation that will provide a similar landscape function as soon as reasonable and feasible. Where multiple failures occur in the same area, soil testing or other investigations will be undertaken, and appropriate treatments implemented. 12. Please remove the sentence "The species and densities nominated in the Landscape Plans will 	 upon surrounding areas of native vegetation including Wattle Grove Offset Area, potentially resulting in the killing of native vegetation in the Wattle Grove Offset Area. Therefore, insecticide and fungicide treatment will be undertaken in accordance with the following requirements: Read the precautions and directions on labels Appropriate protective clothing and equipment including: gloves, boots, overalls, goggles and respirator will be used Open, pour and mix insecticides and fungicides on a stable surface in a well-ventilated area Clean up any spills promptly Avoid using insecticides and fungicides on windy days and prior to expected rainfall to reduce the likelihood of off-site impacts to surrounding vegetation Avoid using insecticides and fungicides near food or people Avoid the over-use of insecticides or fungicides. 10. Table 4 and 5 has been updated to include the following maintenance actions: Maintain soil permeability Rainwater harvest tank maintenance Improving soil quality 11. Section 1.3 has been included to indicate that the LVMSP will be staged in accordance with the UDLP. 12. Sentence removed.

Condition No.	Section Reference	DPE Comment	Proponent Response
		be planted where practical", as these species will be planted where the approved UDLP states they will be planted. 13. Please update the plan to include the monitoring and maintenance of vegetation in the Employee Outdoor Meal Break Areas.	13. Monitoring and maintenance of vegetation in Employee Outdoor Meal Break Areas for Warehouse 1 has been included in Table 5.
The approved plan must be implemented prior to occupation of the warehouse and freight village.	S 1.3	Section 1.3 state that the "LVMSP must be implemented prior to occupation of the warehouses and freight village.". 12. Please update this to be consistent with the current planned staging of the plans i.e. will be implemented prior to the occupation of warehouse 1 etc.	12. Section 1.3 has been included to indicate that the LVMSP will be staged in accordance with the UDLP.
 B127 The Applicant must: (a) Take all reasonable steps to manage pests and vermin on the site; (b) Manage declared noxious weeds on the site in accordance with the requirements of the Noxious Weeds Act 1993; (c) Inspect the site on a regular basis, no less than every 3 months, to ensure that these measures are working effectively, and that pests, vermin or noxious weeds are not present on site in sufficient numbers to pose and environmental hazard, or cause the loss of 		 DPE notes that this condition is not cross referenced in this plan. 14. Please update the plan to include a cross-reference to this condition, i.e. Operational Flora and Fauna Management Plan etc. 	14. This condition has been included in Section 1.4 Compliance Matrices – <i>Table 2 Additional Conditions of</i> <i>Consent (CoC)</i> and refers to the MLP East Precinct OFFMP. Note the <i>Noxious Weeds Act 1993</i> was repealed in June 2017 and replaced with the <i>Biosecurity</i> <i>Act 2015</i> .

Condition No.	Section Reference	DPE Comment	Proponent Response
amenity in the surrounding area.			
B110 Prior to operation, the Applicant must prepare an Operational Flora and Fauna Management Plan (OFFMP) in consultation with OEH. The OFFMP must form part of the OEMP required by condition C3 and must include measures to ensure biodiversity values not intended to be impacted are protected, including but not limited to: (i) Weed control		As above.	This condition has been included in Section 1.4 Compliance Matrices – <i>Table 2 Additional Conditions of</i> <i>Consent (CoC)</i> and refers to the MLP East Precinct OFFMP.



Appendix 0B – Typical Garden Detail

PROPOSED PLANT SCHEDULE

BOTANICAL NAME	COMMON NAME	NATIVE	EXPECTED CANOPY SPREAD	EXPECTED MATURE HEIGHT	INSTALL SIZE
Trees					
Acacia decurrens	Black Wattle	√	3-7m	8-10m	140mm-100L
Acacia falcata	Sickle Wattle	✓	2-3m	3-4m	140mm-100L
Acacia parramattensis	Parramatta Green Wattle	✓	3-7m	8-10m	140mm-100L
Acer truncatum x platanoides	Keithsform Norwegian Sunset		6m	8-10m	140mm-100L
Allocasuarina littoralis	Black She-Oak	✓	5-10m	8-10m	140mm-100L
Angophora bakeri	Narrow Leafed Apple	√	8-13m	8-10m	140mm-100L
Angophora floribunda	Rough-barked Apple	√	10-15m	15m	140mm-100L
Corymbia ficifolia	Flowering Gum	✓	3-7m	8-10m	140mm-100L
Corymbia maculata	Spotted Gum	✓	6-10m	>15m	140mm-100L
Callistemon salignus	White Bottlebrush, Pink-tips	✓	3-7m	9m	140mm-100L
Eucalyptus amplifolia	Cabbage Gum	✓	5-10m	>15m	140mm-100L
Eucalyptus baueriana	Blue Box	✓	8-13m	>15m	140mm-100L
Eucalyptus bosistoana	Coast Grey Box	✓	8-13m	>15m	140mm-100L
Eucalyptus eugenioides	Thin-leaved stringybark	✓	8-13m	>15m	140mm-100L
Eucalyptus crebra	Narrow-leafed Ironbark	√	3-7m	10-15m	140mm-100L
Eucalyptus moluccana	Grey Box	√	13-18m	>15m	140mm-100L
Eucalyptus racemosa	Snappy Gum, Scribbly Gum	√	5-10m	10-15m	140mm-100L
Eucalyptus sideroxylon	Mugga, Red Ironbark	✓	3-6m	>15m	140mm-100L
Eucalyptus punctata	Grey Gum	✓	6-9m	>15m	140mm-100L
Eucalyptus tereticornis	Forest Red Gum	√	3-6m	>15m	140mm-100L
Melaleuca decora	White Cloud Tree	✓	6-10m	6-10m	140mm-100L
Melaleuca linariifolia	Flax-leaved Paperbark	√	3-7m	10m	140mm-100L
Pittosporum undulatum	Pittosporum	√	3-7m	10m	140mm-100L
Shrubs					
Acacia brownii	Golden Prickly Moses	✓	N/A	1m	140-200mm
Acacia floribunda	White Sally	√	N/A	3.5m	140-200mm
Acacia falcata	Sickle Wattle	✓	N/A	4m	140-200mm
Acmena smithii 'Hedgemaster'	Lilly Pilly	✓	N/A	1-1.5m	140-200mm
Banksa spinulosa 'Birthday Candles'	Birthday Candles	✓	N/A	0.5m	140-200mm
Bursaria spinosa	Sweet Bursaria	✓	N/A	1.5-3m	140-200mm
Callistemon citrinus 'White Anzac'	Bottlebrush	✓	N/A	1m	140-200mm
Callistemon linearis	Narrow-leaved Bottlebrush	✓	N/A	3m	140-200mm
Callistemon viminalis' 'Macarthur'	Red Bottlebrush	✓	N/A	1.8m	140-200mm
Crowea exalata	Small Crowea	✓	N/A	0.5m	140-200mm
Crowea saligna	Willow-leaved Crowea	✓	N/A	1m	140-200mm
Doryanthes excelsa	Gymea Lily	✓	N/A	2-4m	140-200mm
Dillwynia sieberi	Prickly Parrot Pea	✓	N/A	0.5-2m	140-200mm
Eriostemon australasius	Pink Wax Flower	✓	N/A	1.5m	140-200mm
Kunzea ambigua	Tick-bush	✓	N/A	2.5m	140-200mm
Leptospermum polygalifolium	Tantoon	✓	N/A	0.5-3m	140-200mm
Melaleuca nodosa	Ball Honey-myrtle	✓	N/A	4m	140-200mm
Philotheca buxifolius	Box-leaf Waxflower	✓	N/A	0.5m	140-200mm



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REIDCAMPBELL

Architect

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Project Manager

BOTANICAL NAME	COMMON NAME	NATIVE	EXPECTED CANOPY SPREAD	EXPECTED MATURE HEIGHT	INSTALL SIZE
Grasses and Groundcovers		•			
Anigozanthos 'Bush Gold'	Kangaroo Paw	 ✓ 	N/A	1m	150mm
Arthropodium milleflorum	Pale Vanilla Lily	 ✓ 	N/A	0.3-1m	150mm
Austrodanthonia fulva	Wallaby Grass	 ✓ 	N/A	0.7m	150mm
Austrodanthonia racemosa	Clustered Wallaby Grass	 ✓ 	N/A	0.6m	150mm
Dianella caerulea	Blue Flax-lily	 ✓ 	N/A	0.6m	150mm
Dianella revoluta	Blue Flax-lily, Spreading Flax-lily	 ✓ 	N/A	0.8m	150mm
Dichondra repens	Kidney-weed, Mercury Bay Weed	\checkmark	N/A	0.3m	150mm
Ficinia nodosa	Knobbly Club-Rush	~	N/A	1m	150mm
Gardenia augusta 'O So Fine'	Cape Jasmine	\checkmark	N/A	0.3m	150mm
Grevillea juniperina 'Prostrate Gold'	Juniper-leaf grevillea	~	N/A	0.15m	150mm
Hardenbergia violacea	False Sarsaparilla	~	N/A	Creeper	150mm
Hibbertia diffusa	Wedge Guinea Flower	~	N/A	0.3m	150mm
Lomandra longifolia	Spiky-headed Mat-rush	~	N/A	0.7m	150mm
Lomandra longifolia 'Lime Tuff'	Spiky-headed Mat-rush	~	N/A	0.8m	150mm
Lomandra longifolia 'Tanika'	Spiky-headed Mat-rush	~	N/A	0.5m	150mm
Lomandra hystrix	Spiny-headed Mat-rush	~	N/A	1m	150mm
Microlaena stipoides	Weeping Grass, Meadow Rice-grass	~	N/A	0.7m	150mm
Myoporum parvifolium 'Yareena'	Myoporum	~	N/A	0.1m	150mm
Poa labillardieri	Tussock Grass	~	N/A	0.8m	150mm
Themeda australis	Kangaroo Grass	~	N/A	0.8m	150mm
Trachelospermum jasminoides	Star Jasmine		N/A	Creeper	150mm
Wahlenbergia gracilis	Australian Bluebell	\checkmark	N/A	0.2m	150mm
Westringia fruiticosa 'Mundi"	Coastal Rosemary	✓	N/A	0.5m	150mm

BIO-RETENTION SPECIES LIST						
BOTANICAL NAME	NATIVE	EXPECTED MATURE HEIGHT	INSTALLATION SIZE	DENSITY		
Baumea articulata (Jointed Twig-rush)	✓	1-2m	150mm	4/m ²		
<i>Bolboschoenus fluviatilis</i> (Marsh Club-rush)	✓	1m	150mm	4/m ²		
<i>Carex appressa</i> (Tall Sedge)	✓	0.8m	150mm	4/m ²		
Dichondra repens (Kidney-weed, Mercury Bay Weed)	✓	0.3m	150mm	4/m ²		
Gahnia clarkei (Tall Saw-sedge)	✓	1.5m	150mm	4/m ²		
<i>Goodenia hederacea</i> (Ivy Goodenia)	✓	0.5m	150mm	4/m ²		
Imperata cylindrica (Blady grass)	✓	1.5m	150mm	4/m ²		
<i>Isolepis (Ficinia) nodosa</i> (Knobbly Club-rush)	✓	1m	150mm	4/m ²		

HYDROSEED GRASS MIX		
BOTANICAL NAME	NATIVE	EXPECTED MATURE HEIGHT
Imperata cylindrica (Blady grass)	\checkmark	1.5m
Isolepis (Ficinia) nodosa (Knobbly Club-rush)	\checkmark	1m
Lomandra hystrix (Green Mat-rush)	\checkmark	1m
Lomandra longifoilia (Spiny-headed Mat-rush)	\checkmark	1.2m
Microlaena stipoides (Weeping Grass, Meadow Rice-grass)	\checkmark	0.7m
Poa labillardieri (Common Tussock Grass)	\checkmark	1.2m
Rhynchospora corymbosa (Matamat)	\checkmark	1.2m
Themeda australis (Kangaroo grass)	✓	1.5m

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Note Verify all dimensions on site before commencing work. Report all discrepancies to Landscape Architect prior to construction. Figured dimensions to be taken in preference to scaled drawings. All work is to conform to relevant Australian standards and other codes as applicable. Location of underground services to be proven on site and protected if necessary prior to construction. Dial before you dig. Plant species and quantities shown are indicative only and are subject to change based on future project requirements.

Issue	Date	Description
А	04.06.20	Issue for Coordination
В	28.10.20	Issue for Coordination

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Project				
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Moorebar	nk Logistics Pa	irk, Moore	ebank NSW	
Scale				Rev
N/A				В



FULL SUN SEDGES AND GRASSES





Bolboschoenus fluviatilis (Club-rush)



Carex appressa (Tall Sedge)



Carex breiculmis (Short-Stem Sedge)





Schoenus apogon (Fluke Bog-rush)



PART SHADE SEDGES AND GRASSES







ra stricta (Blue Dampiera)



osum (Wooly Waterlily) Philydrum lanuu



Gahnia clarkei (Tall Saw-sedge)



Leptocarpus tenax (Slender Twine Rush)




Goodenia hederacea (Ivy Goodenia)



Lazmannia gracilis (Slender Wire Lily)



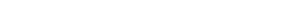



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RAIN GARDEN PLANTING PALETTE



FULL SHADE SEDGES AND GRASSES



Dichondra repens (Kidney Weed)



Juncus continuus (Rush)



olepis inundata (Water Club-rush)




Microlaena stipoides (Weeping Grass)




Lepyrodia scariosa (Scale rush)



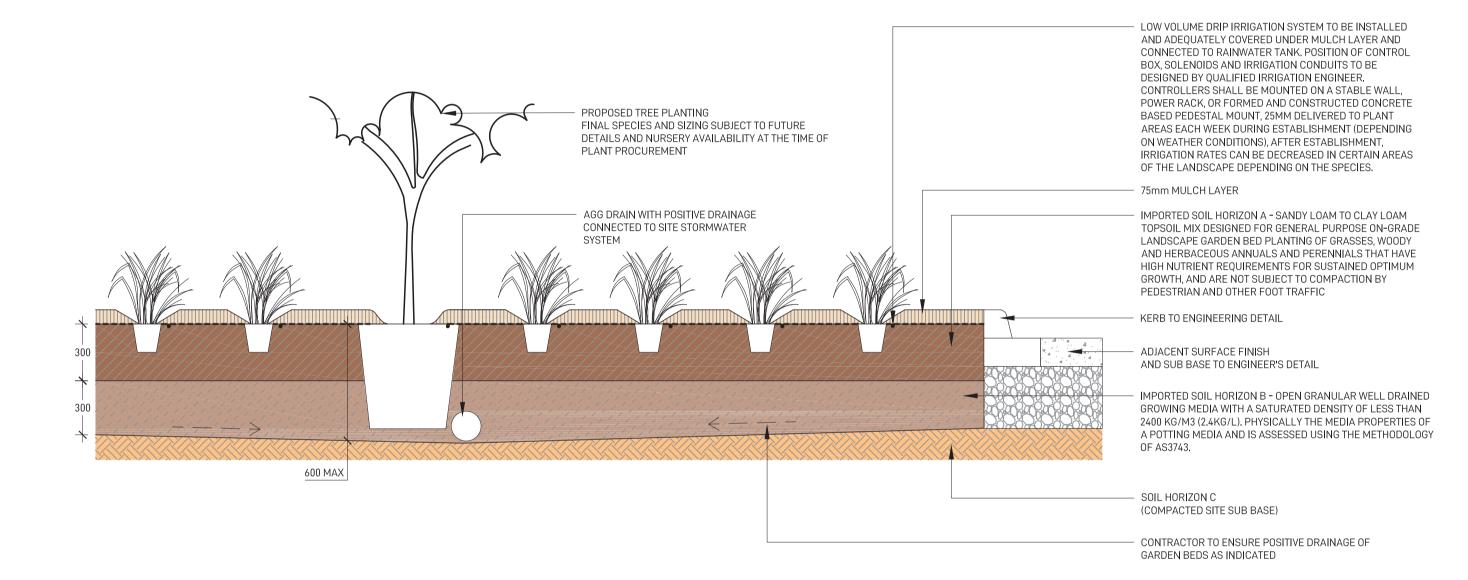




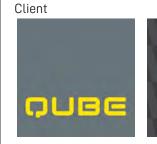





Architect

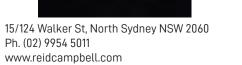

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Project Manager

Ŧ	Note Verify all dimensions on site before commencing work. Report all discrepancies to Landscape Architect prior to construction. Figured dimensions to be taken in preference to scaled drawings. All work is to conform to relevant Australian standards and other codes as applicable. Location of underground services to be proven on site and protected if necessary prior to construction. Dial before you dig. Plant species and quantities shown are indicative only and are subject to change based on future project requirements.	Date 04.06.20 28.10.20 16.12.20	Description Issue for Coordination Issue for Coordination Issue for Coordination	Drawn	Checked	PRECINO TYPI
.com.au/	Plant species and quantities shown are indicative only and are subject to change based on future project requirements.					

CT LANDSCAPE

Date 16.12.20	Job Number 20200421	Drawn KF	Checked RL	Drawing Number MPE2-GNK-LN-DWG-9000
Project				
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TYPICAL CARPARK SCREEN PLANTING



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29/88 Phillip Street, Sydney, NSW 2000 Ph. (02) 81973900 www.logosproperty.com.au

15 Blue Street, North Sydney NSW 2060 Ph. (02) 83290730 www.watsonyoung.com.au

	Note	Issue	Date	Description	Drawn	Checked	Drawing Title
		А	04.06.20	Issue for Coordination			0
	Verify all dimensions on site before commencing work. Report all discrepancies to Landscape Architect prior to construction. Figured dimensions to be taken in preference to scaled drawings.	В	28.10.20	Issue for Coordination			
	All work is to conform to relevant Australian standards and other codes as applicable.	С	28.10.20	Issue for Coordination			TYPICAL
T		D	16.12.20	Issue for Coordination			
	Location of underground services to be proven on site and protected if necessary prior to construction. Dial before you dig.	E	21.07.22	Issue for Coordination			PL
	Plant species and quantities shown are indicative only and are subject to change based on future project requirements.						
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					FOR COORDINATION			
	Date 21.07.22	Job Number 20200421	Drawn WL	Checked RL	Drawing Number MPE2-GNK-LN-DWG-7002			
	Project							
. CARPARK BAY LANTING	Moore Mooreban	V						
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Landscape Architect








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Note Verify all dimensions on site before commencing work. Report all discrepancies to Landscape Architect prior to construction. Figured dimensions to be taken in preference to scaled drawings. All work is to conform to relevant Australian standards and other codes as applicable. Location of underground services to be proven on site and protected if necessary prior to construction. Dial before you dig. Plant species and quantities shown are indicative only and are subject to change based on future project requirements.

Je	Date	Description
	04.06.20	Issue for Coordination
	28.10.20	Issue for Coordination
	28.10.20	Issue for Coordination
	16.12.20	Issue for Coordination
	21.07.22	Issue for Coordination



TYPICAL INTERNAL ROAD LANDSCAPE PERSPECTIVE

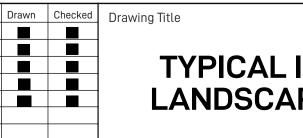FOR COORDINATION

Job Number Drawn Checked Drawing Number Date 21.07.22 20200421 WL RL MPE2-GNK-LN-DWG-8000 roiect Moorebank Precinct East Moorebank Logistics Park, Moorebank NSW NOT TO SCALE

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Moorebank Landscape Maintenance Schedule

Item	Activity			Fre	quency			Action
Item	Activity	Daily	Weekly	Fortnightly	Monthly	3 Months	6 Months	Action
1	Logbook	0		0				Complete a logbook entry everyday at site and at least every fortnightly. All actions listed below require a logbook entry. Logbook is available for inspection upon request. Submit copies of new entries in the logbook to the Contract Administrator on a monthly basis. Please note that more frequent, short, occasional inspections should result in less maintenance work when problems are observed earlier than they might otherwise have been seen.
2	Plant Replacement			0				Inspect and replace failed plants within a fortnight of observation of failure. Match species, size at installation, and location of new with old.
3	Mulch			0			0	Inspect mulch every fortnight and replenish/top up mulch every 6 months.
4	Erosion Control			0				Inspect batters fortnightly and repair ground, soil, and jute mesh immediately. Maintain erosion control device as necessary.
5	Stakes and Ties			0				Inspect fortnightly, adjust and/or replace as necessary. Remove as plants mature and are able to support themselves.
6	Weed & Rubbish Removal			0				Inspect and remove immediately upon observation. Leave no waste on site. Dispose of waste material at a designated waste disposal site.
7	Pruning							
7.1	General Pruning/Maintenance			0				Inspect fornightly and remove spent flowers and dead stalks as they become apparent.
7.2	Under pruning				0			Inspect every month and under prune as necessary to maintain clear lines of sight. Pruning to stop as plants grow above the line of sight.
7.3	Seasonal Pruning						0	Inspect every 6 months and prune as necessary to remove dead matter, improve plant shape and promote healthy and vigorous new growth.
8	Spraying			0				Inspect every fortnightly and action as necessary. Do not spray if other non-chemical methods will satisfy the need to remove insects. Spray for disease control upon observation of poor plant health.
9	Urgent Works		0					Complete within 1 week (7 days) of notification. Inspect and clear drains.
10	Top-dressing & Fertilising					0	0	Top-dress turf every 6 months. Fertilise every 3 months or other frequency in accordance with fertiliser manufacturer's directions.
11	Mowing & Edging			0	0			Mowing & edging fortnightly in growing seasons. Mowing & edging in winter monthly.
12	Watering	0						Water when and where necessary everyday at site and at least every fortnight generally. Do not allow soil to dehydrate. Allow for prolonged rain, windy, and dry periods. Water in the early morning or late afternoon to avoid excessive evaporation during the heat of the day.



Appendix 1 – Area 1 Landscape Drawings and Figures

PLANT PALETTE

BOTANICAL NAME	COMMON NAME	NATIVE	EXPECTED CANOPY SPREAD	EXPECTED MATURE HEIGHT	INSTALL SIZE	DEN
Trees	· ·			·		•
Acacia decurrens	Black Wattle	\checkmark	3-7m	10-15m	140mm-100L	5m ce
Acacia parramattensis	Parramatta Green Wattle	\checkmark	3-7m	10m	140mm-100L	5m ce
Allocasuarina littoralis	Black She-Oak	\checkmark	5-10m	10m	140mm-100L	5m ce
Angophora bakeri	Narrow Leafed Apple	\checkmark	8-13m	10m	140mm-100L	5m ce
Angophora floribunda	Rough-barked Apple	\checkmark	10-15m	20m	140mm-100L	6m ce
Corymbia ficifolia	Flowering Gum	\checkmark	3-7m	10m	140mm-100L	6m ce
Corymbia maculata	Spotted Gum	\checkmark	6-10m	30m	140mm-100L	6m ce
Callistemon salignus	White Bottlebrush, Pink-tips	\checkmark	3-7m	9m	140mm-100L	5m ce
Eucalyptus amplifolia	Cabbage Gum	\checkmark	5-10m	30m	140mm-100L	6m ce
Eucalyptus baueriana	Blue Box	\checkmark	8-13m	20m	140mm-100L	6m ce
Eucalyptus bosistoana	Coast Grey Box	\checkmark	8-13m	60m	140mm-100L	6m ce
Eucalyptus eugenioides	Thin-leaved stringybark	\checkmark	8-13m	30m	140mm-100L	6m ce
Eucalyptus crebra	Narrow-leafed Ironbark	\checkmark	3-7m	15m	140mm-100L	6m ce
Eucalyptus moluccana	Grey Box	\checkmark	13-18m	20m	140mm-100L	6m ce
Eucalyptus racemosa	Snappy Gum, Scribbly Gum	\checkmark	5-10m	15m	140mm-100L	6m ce
Eucalyptus sideroxylon	Mugga, Red Ironbark	\checkmark	3-6m	20-25m	140mm-100L	6m ce
Eucalyptus punctata	Grey Gum	\checkmark	6-9m	10-25m	140mm-100L	6m ce
Eucalyptus tereticornis	Forest Red Gum	\checkmark	3-6m	20-25m	140mm-100L	6m ce
Melaleuca decora	White Cloud Tree	\checkmark	6-10m	6-10m	140mm-100L	6m ce
Melaleuca linariifolia	Flax-leaved Paperbark	\checkmark	3-7m	10m	140mm-100L	5m ce
Pittosporum undulatum	Pittosporum	\checkmark	3-7m	10m	140mm-100L	5m ce
Shrubs						
Acacia brownii	Golden Prickly Moses	\checkmark	N/A	1m	140-200mm	2m ce
Acacia falcata	Sickle Wattle	\checkmark	N/A	4m	140-200mm	2m ce
Banksa spinulosa 'Birthday Candles'	Birthday Candles	\checkmark	N/A	0.5m	140-200mm	0.5m c
Bursaria spinosa	Sweet Bursaria	\checkmark	N/A	1.5-3m	140-200mm	2m ce
Callistemon citrinus	Scarlet Bottlebrush	\checkmark	N/A	4m	140-200mm	2m ce
Callistemon linearis	Narrow-leaved Bottlebrush	\checkmark	N/A	3m	140-200mm	2m ce
Crowea exalata	Small Crowea	\checkmark	N/A	0.5m	140-200mm	0.5m c
Crowea saligna	Willow-leaved Crowea	\checkmark	N/A	1m	140-200mm	0.5m c
Dillwynia sieberi	Prickly Parrot Pea	\checkmark	N/A	0.5-2m	140-200mm	2m ce
Eriostemon australasius	Pink Wax Flower	\checkmark	N/A	1.5m	140-200mm	1m ce
Kunzea ambigua	Tick-bush	\checkmark	N/A	2.5m	140-200mm	1m ce
Leptospermum polygalifolium	Tantoon	\checkmark	N/A	0.5-3m	140-200mm	1m ce
Melaleuca nodosa	Ball Honey-myrtle	√	N/A	4m	140-200mm	2m ce
Philotheca buxifolius	Box-leaf Waxflower	√	N/A	0.5m	140-200mm	1m ce
Grasses, Sedges and Groundcovers			·	•		J
Anigozanthos 'Bush Gold'	Kangaroo Paw	✓	N/A	1m	150mm	6/r
Arthropodium milleflorum	Pale Vanilla Lily	\checkmark	N/A	0.3-1m	150mm	6/r
Austrodanthonia fulva	Wallaby Grass	\checkmark	N/A	0.7m	150mm	6/r
Dianella caerulea	Blue Flax-lily	√	N/A	0.6m	150mm	6/r
Dianella revoluta	Blue Flax-lily, Spreading Flax-lily	√	N/A	0.8m	150mm	6/r
Dichondra repens	Kidney-weed, Mercury Bay Weed	√	N/A	0.3m	150mm	4/r
· · · · · · · · · · · · · · · · · · ·		√	N/A		150mm	
Hardenbergia violacea	False Sarsaparilla	· · · · · · · · · · · · · · · · · · ·		Creeper		3/r
Hibbertia diffusa	Wedge Guinea Flower	 ✓	N/A	0.3m	150mm	4/r
Lomandra longifolia	Spiky-headed Mat-rush	✓ ✓	N/A	0.7m	150mm	6/r
Lomandra hystrix	Spiny-headed Mat-rush		N/A	1m	150mm	6/r
Microlaena stipoides	Weeping Grass, Meadow Rice-grass	✓	N/A	0.7m	150mm	6/r
Myoporum parvifolium 'Yareena'	Myoporum	✓	N/A	0.1m	150mm	3/r
Themeda australis	Kangaroo Grass	√	N/A	0.8m	150mm	6/r
Wahlenbergia gracilis	Australian Bluebell	\checkmark	N/A	0.2m	150mm	9/r

OFFICE OPEN SPACE PLANTER PLANT PALETTE (NUMBER 4 ON PLAN)

BOTANICAL NAME	COMMON NAME	NATIVE	EXPECTED MATURE HEIGHT	EXPECTED MATURE SPREAD	INSTALL SIZE	DENS
Climbers and Groundcovers						
Banksia 'Birthday Candles'		\checkmark	0.5m	0.5-1m	150mm	6-8/
Carpobrotus glaucescens	Pigface	\checkmark	0.3	2m	150mm	4/n
Trachelospermum jasminoides	Star Jasmine		2m	2m	150mm	4/n

RAIN GARDEN PLANT PALETTE ON MPE SITE (NUMBER 13 ON PLAN)


BOTANICAL NAME COMMON NAME		NATIVE	EXPECTED MATURE HEIGHT	INSTALL SIZE	DENSITY
Climbers and Groundcovers					
Baumea articulata	Jointed Twig-rush	\checkmark	1-2m	150mm	4/m ²
Carex appressa	Tall Sedge	\checkmark	0.8m	150mm	4/m ²
Dichondra repens	Kidney-weed, Mercury Bay Weed	\checkmark	0.3	150mm	6/m ²
Goodenia hederacea	Ivy Goodenia	\checkmark	0.5m	150mm	4/m ²
Lomandra leucocephala	Woolly Mat-Rush	\checkmark	0.4m	150mm	4/m ²
Microlaena stipoides	Weeping Grass, Meadow Rice-grass	\checkmark	0.7m	150mm	4/m ²

NOTE: Hydro mulching/ Hydroseeding may be considered for some landscaping areas to achieve a rich mixture of trees, shrubs and groundcovers. This will be subject to seasonal variation at the time of plant installation and will be subject to nursery availability and pot sizes at the time of plant procurement.







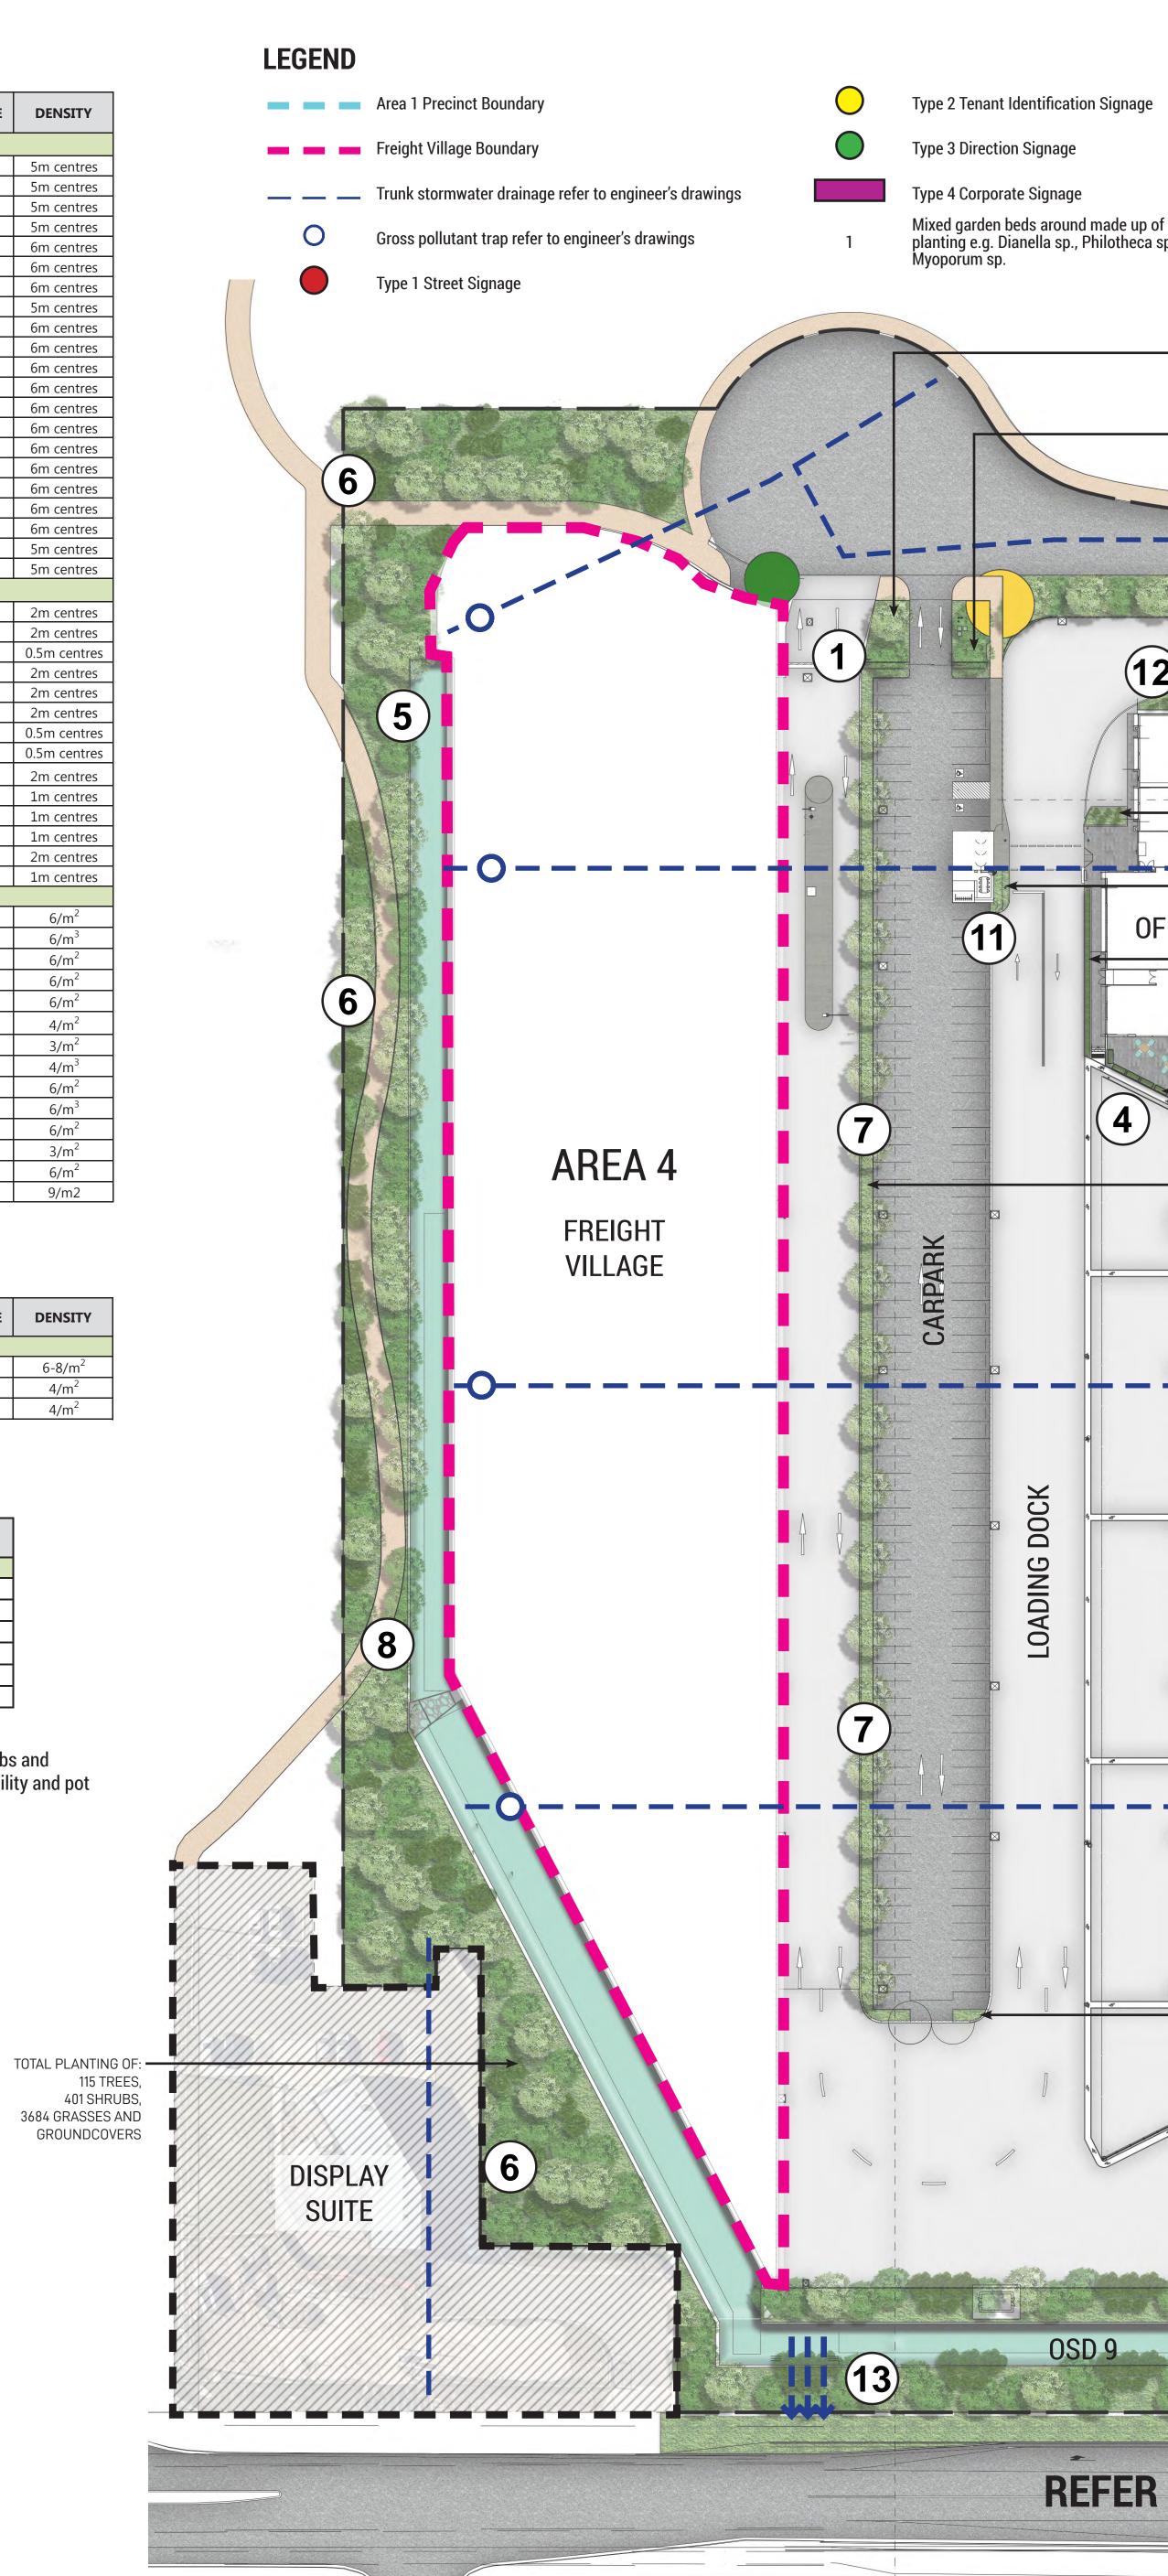



124 Walker St, North Sydney NSW 2060 Ph. (02) 8907 0700 http://www.tacticalgroup.com.au/

Note

Verify all dimensions on site before commencing work. Report all discrepancies to La Architect prior to construction. Figured dimensions to be taken in preference to scale drawings.

All work is to conform to relevant Australian standards and other codes as applicable Location of underground services to be proven on site and protected if necessary p construction. Dial before you dig. Plant species and quantities shown are indicative only and are subject to change bas future project requirements.


e o of low level native a sp. Lomandra sp. and	3 Feat Staf 4 with (Sta	opy trees Eucalyptus sideroxylon ar mixed native planting e.g. Acacia s Lomandra sp. ture garden bed adjacent to wareho if meal break area with tensile steel climbing plants e.g.Trachelosperm r Jasmine) dscape to include potential seating cent to the shared pathway providu f meal breaks	use wire support system num jasminoides	7 Tall, upright tre providing shad8 Shared path co	peds made up of canopy trees such ymbia sp., Eucalyptus sp. and Melal ative planting e.g. Callistemon sp., and Myoporum sp. e planting (Eucalyptus sideroxylon) e and amenity to carpark nnecting to Moorebank Avenue ngophora floribunda, Eucalyptus ra ted with mixed native planting e.g. <i>I</i> num sp., Lomandra sp. and Dianella) 11
TOTAL PLAN 12 SHRUBS, 230 GRASSE GROUNDCO TOTAL PLAN 12 SHRUBS, 235 GRASSE GROUNDCO	ES AND IVERS ITING OF: ES AND			TOTAL PLANTING OF: 41 TREES, 143 SHRUBS, 1998 GRASSES AND GROUNDCOVERS		
		INTERNAL R	OAD			
	TOTAL PLANTING OF:	- Dimension			<u> </u>	• 0 • 0
3	27 SHRUBS, 140 GRASSES AND GROUNDCOVERS	•	D			₿ 6
	TOTAL PLANTING OF: 15 SHRUBS, 35 GRASSES AND GROUNDCOVERS					
)FFICE	TOTAL PLANTING OF: 8 SHRUBS, 12 GRASSES AND GROUNDCOVERS	•	Ð			
	TOTAL PLANTING OF: 107 GRASSES AND GROUNDCOVERS		P		-ğ-	
	TOTAL PLANTING OF: 18 SHRUBS IN PLANTER E	BOXES	•	9		
	TOTAL PLANTING OF: 19 TREES,			*** ***		
	299 SHRUBS, 1086 GRASSES AND GROUNDCOVERS	, B		•		
		e.	AREA	1		
	•		WAREHOU	JSE 1		
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)	•	ໍ່. . ອີ່.		2	±≌ ⊱∎
		TOTAL PLANTING O	Ξ.			
	р	5 TREES, 36 SHRUBS, 1360 GRASSES AND GROUNDCOVERS	45			
	TOTAL PLANTING OF: 4 SHRUBS, 20 GRASSES AND GROUNDCOVERS				580	AL PLANTING OF: 87 TREES, 365 SHRUBS, 09 GRASSES AND GROUNDCOVERS
		WORKSHOP				
					OSD	9
R TO UDLA	-04	MOOREBAN	NK AVENUE			

	Issue	Date	Description	Drawn	Checked	Drawing Title	
Landssana	D	22.3.19	For information			5	
Landscape aled	Е	18.4.19	For information				
	F	4.6.19	For information				
ole.	G	26.819	For information				Area 1 Masterplan
prior to	Н	06.03.20	For information				Alea I Masterplan
	Ι	09.03.20	For information				
ased on	J	31.07.20	For information				
	К	16.12.20	For information				

Small trees Acacia decurrens and under planted with mixed native planting e.g. Acacia sp., Leptospermum sp., Dianella sp. and Myoporum sp. Covered bike storage area

75,000 litre underground rainwater tank

Stormwater channel to rain garden in MPW site

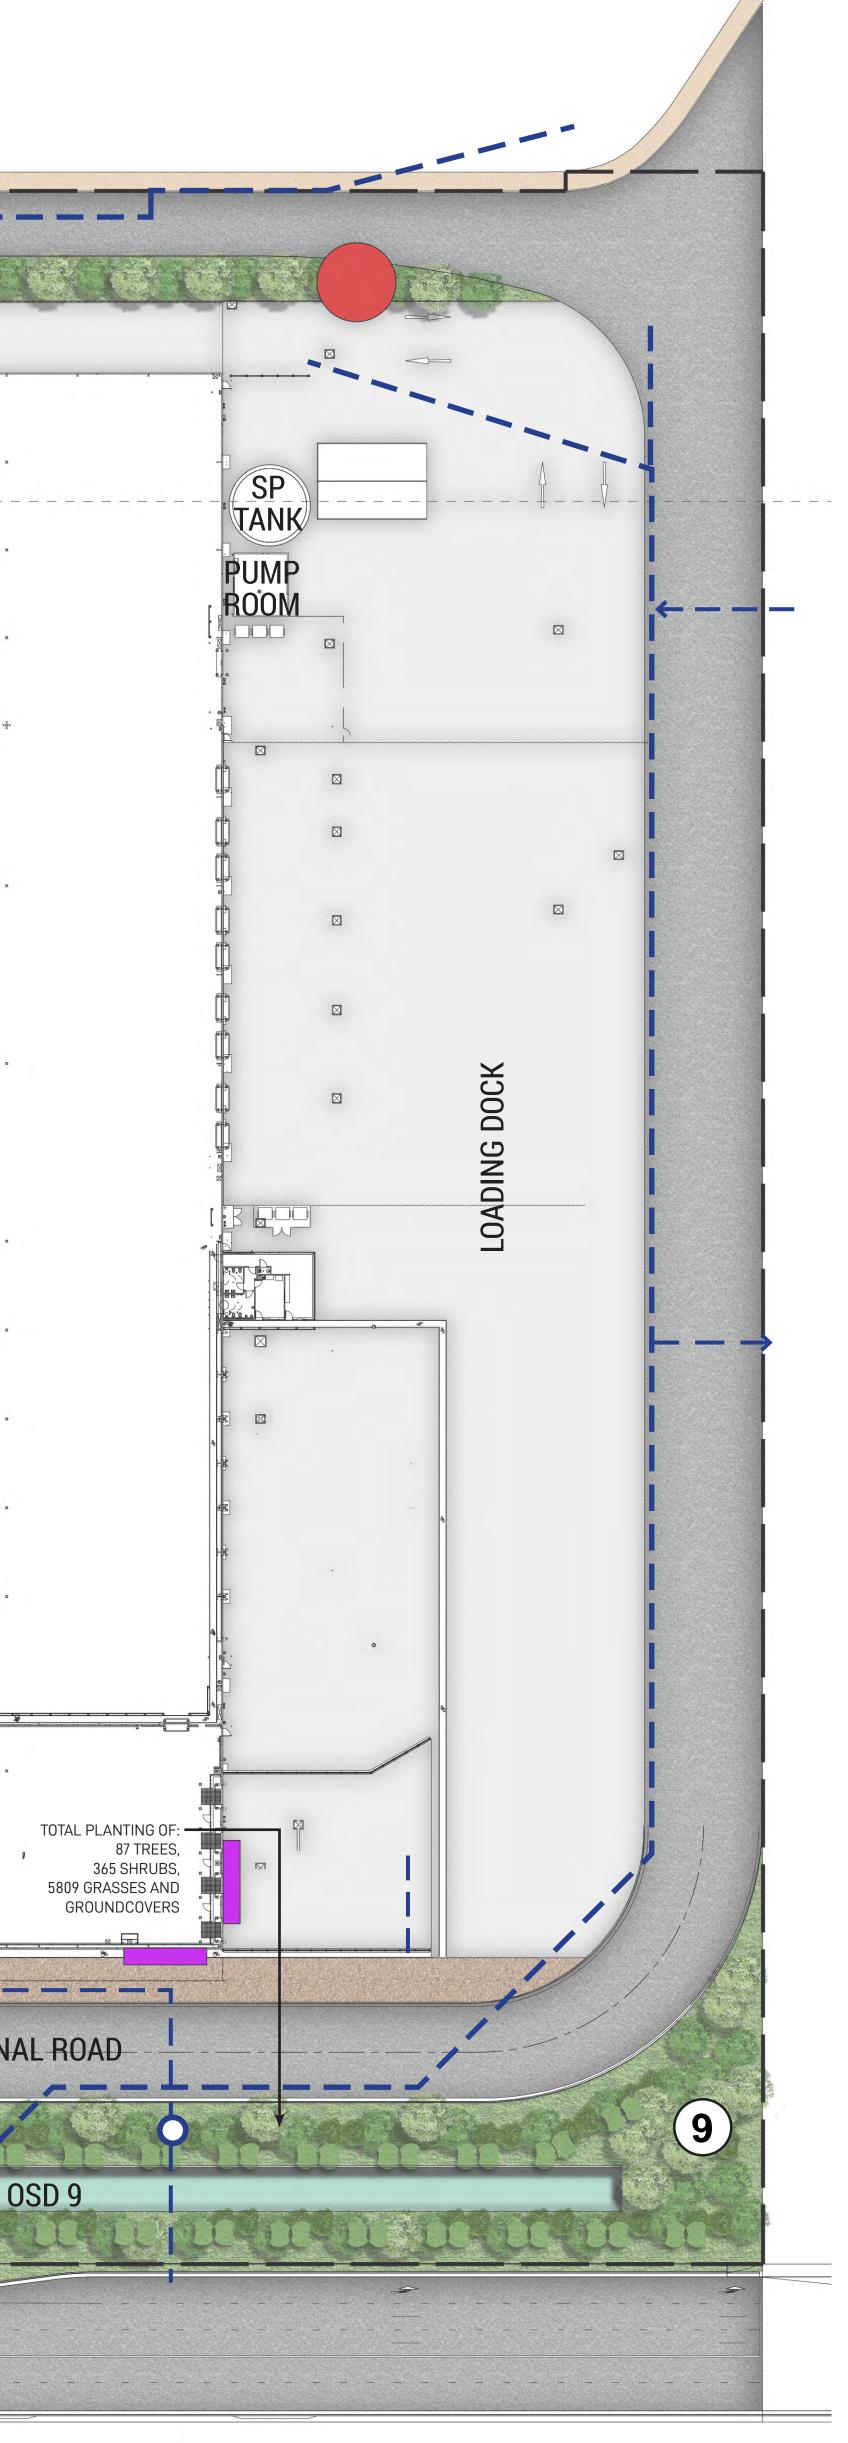



	Date 16.12.20	Drawing Number UDLA-02				
rplan	Project MPE Stag Moorebank Lo	North				
•	Scale 1:500 / A	0				Rev
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Appendix 2 – Area 2 Landscape Drawings and Figures

ON-SITE DETENTION BASIN 1 (OSD 1) LANDSCAPE MASTERPLAN





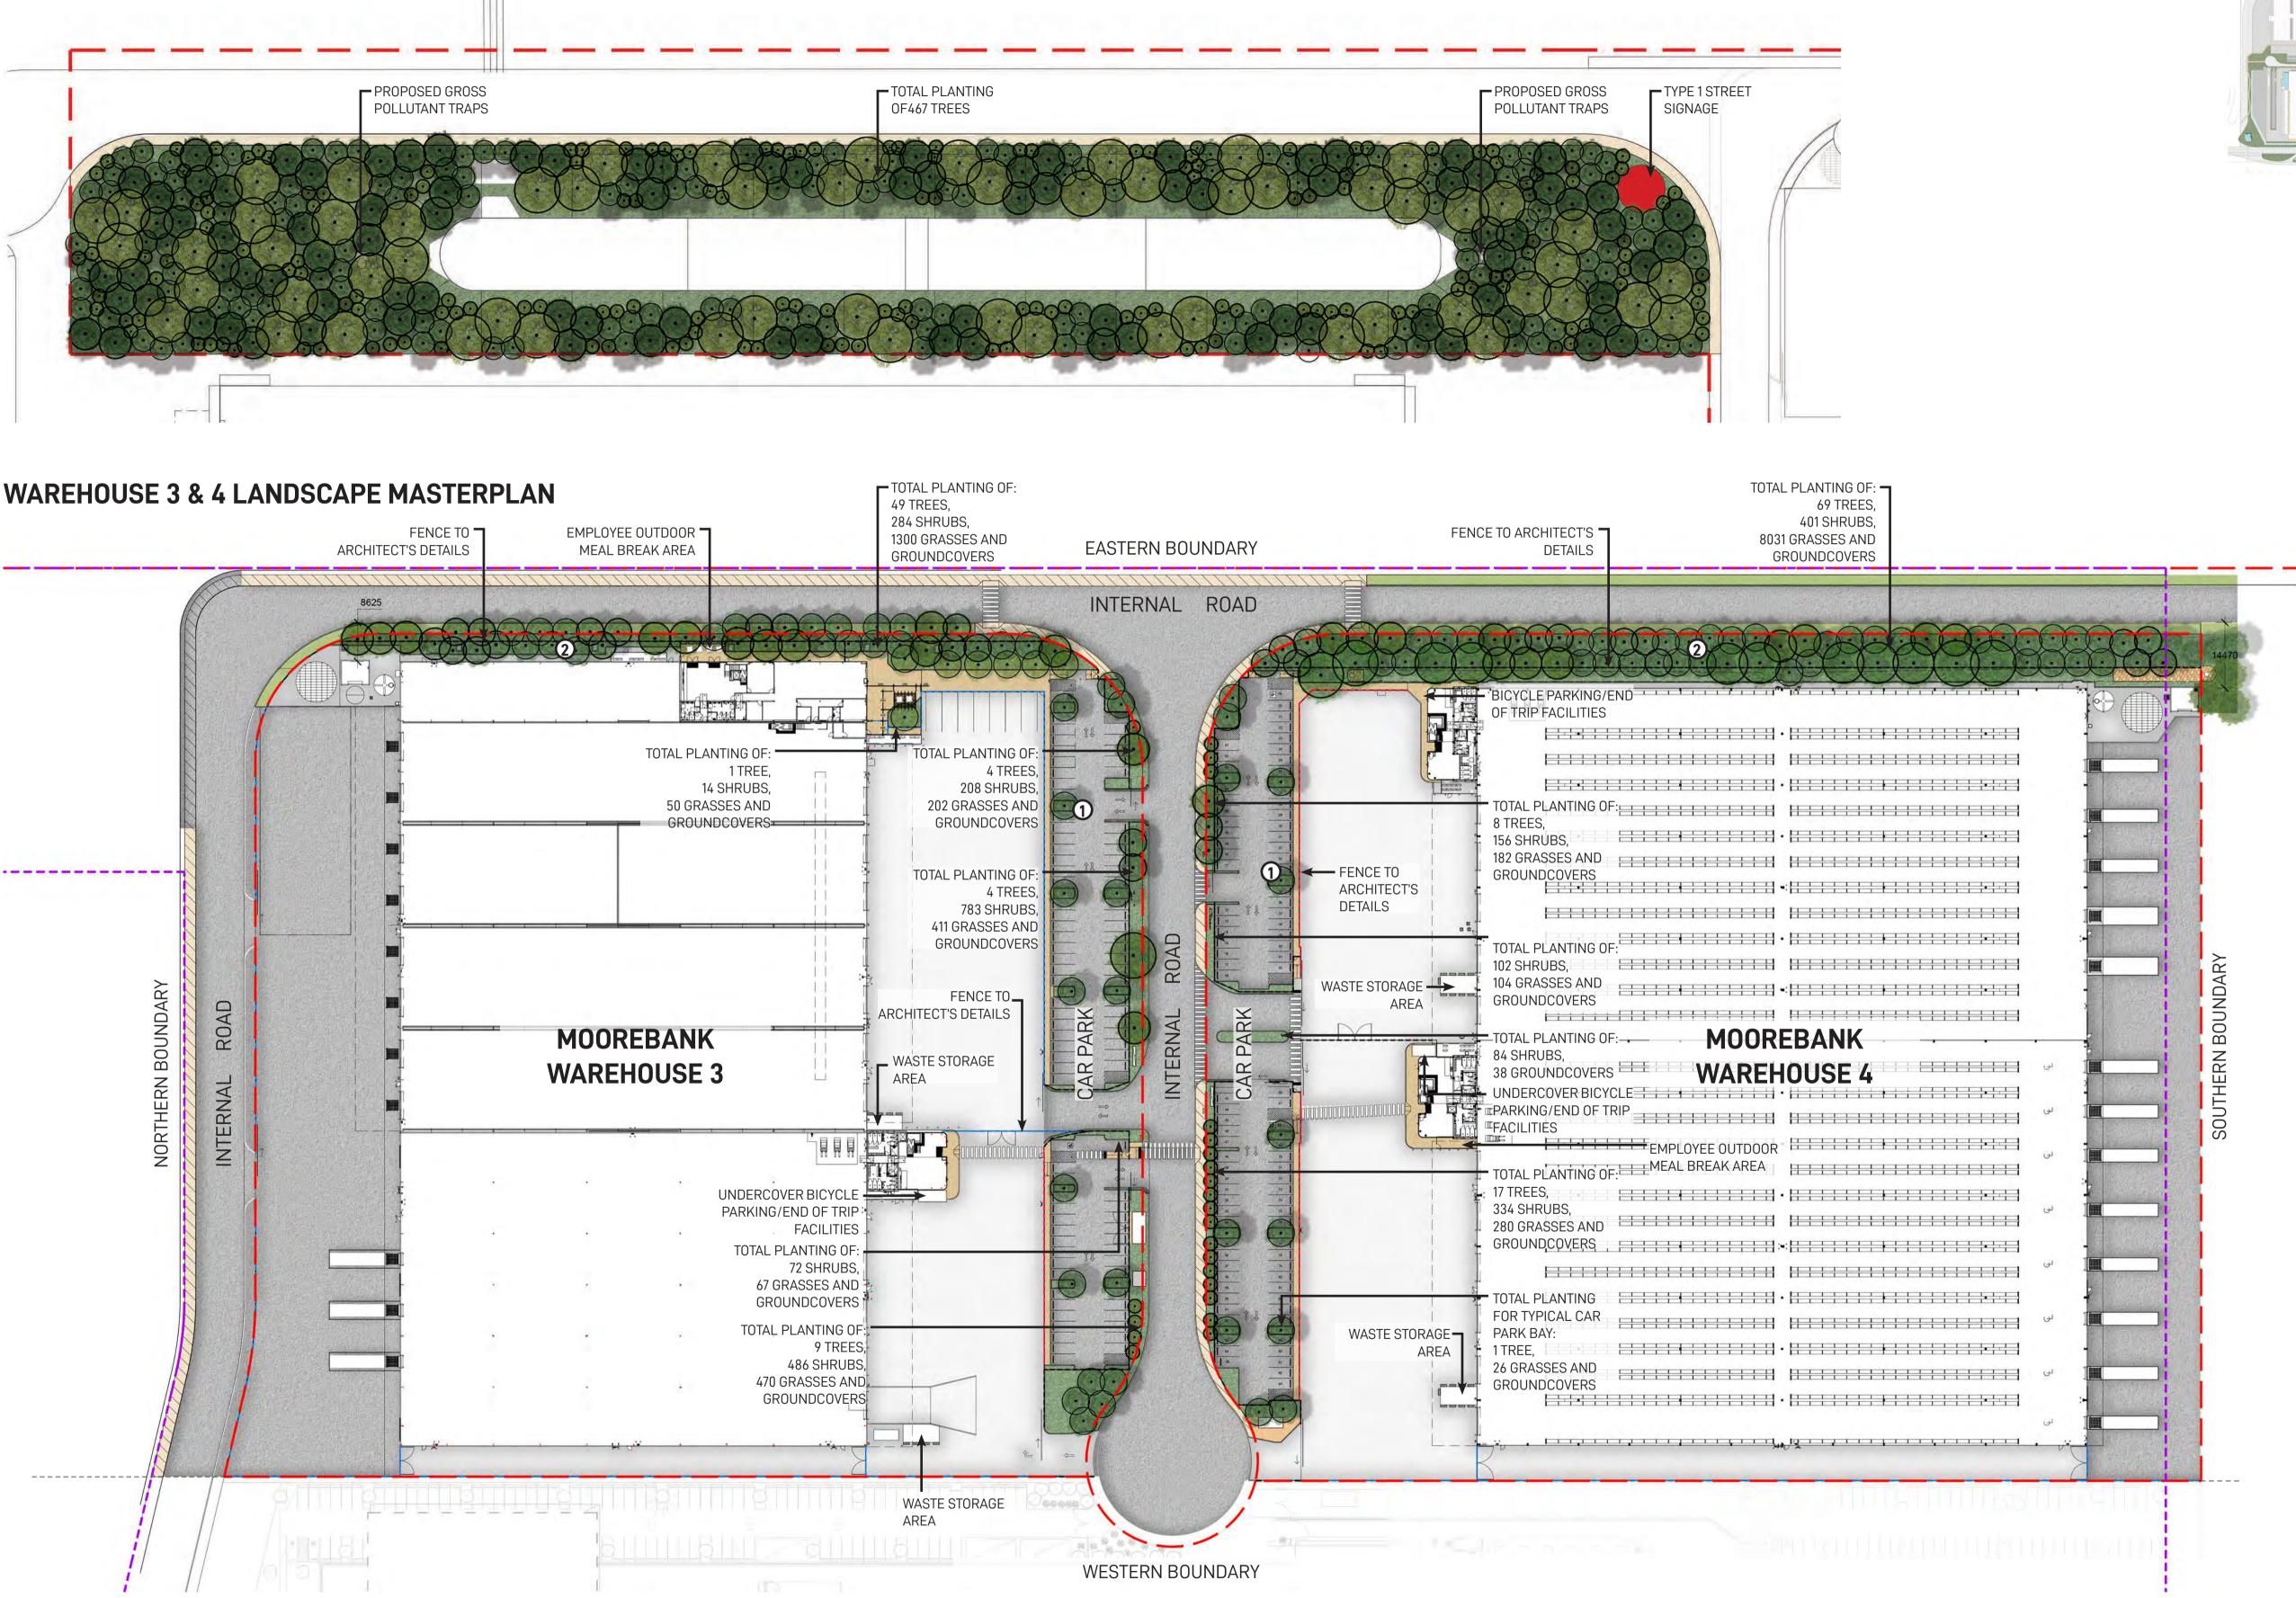


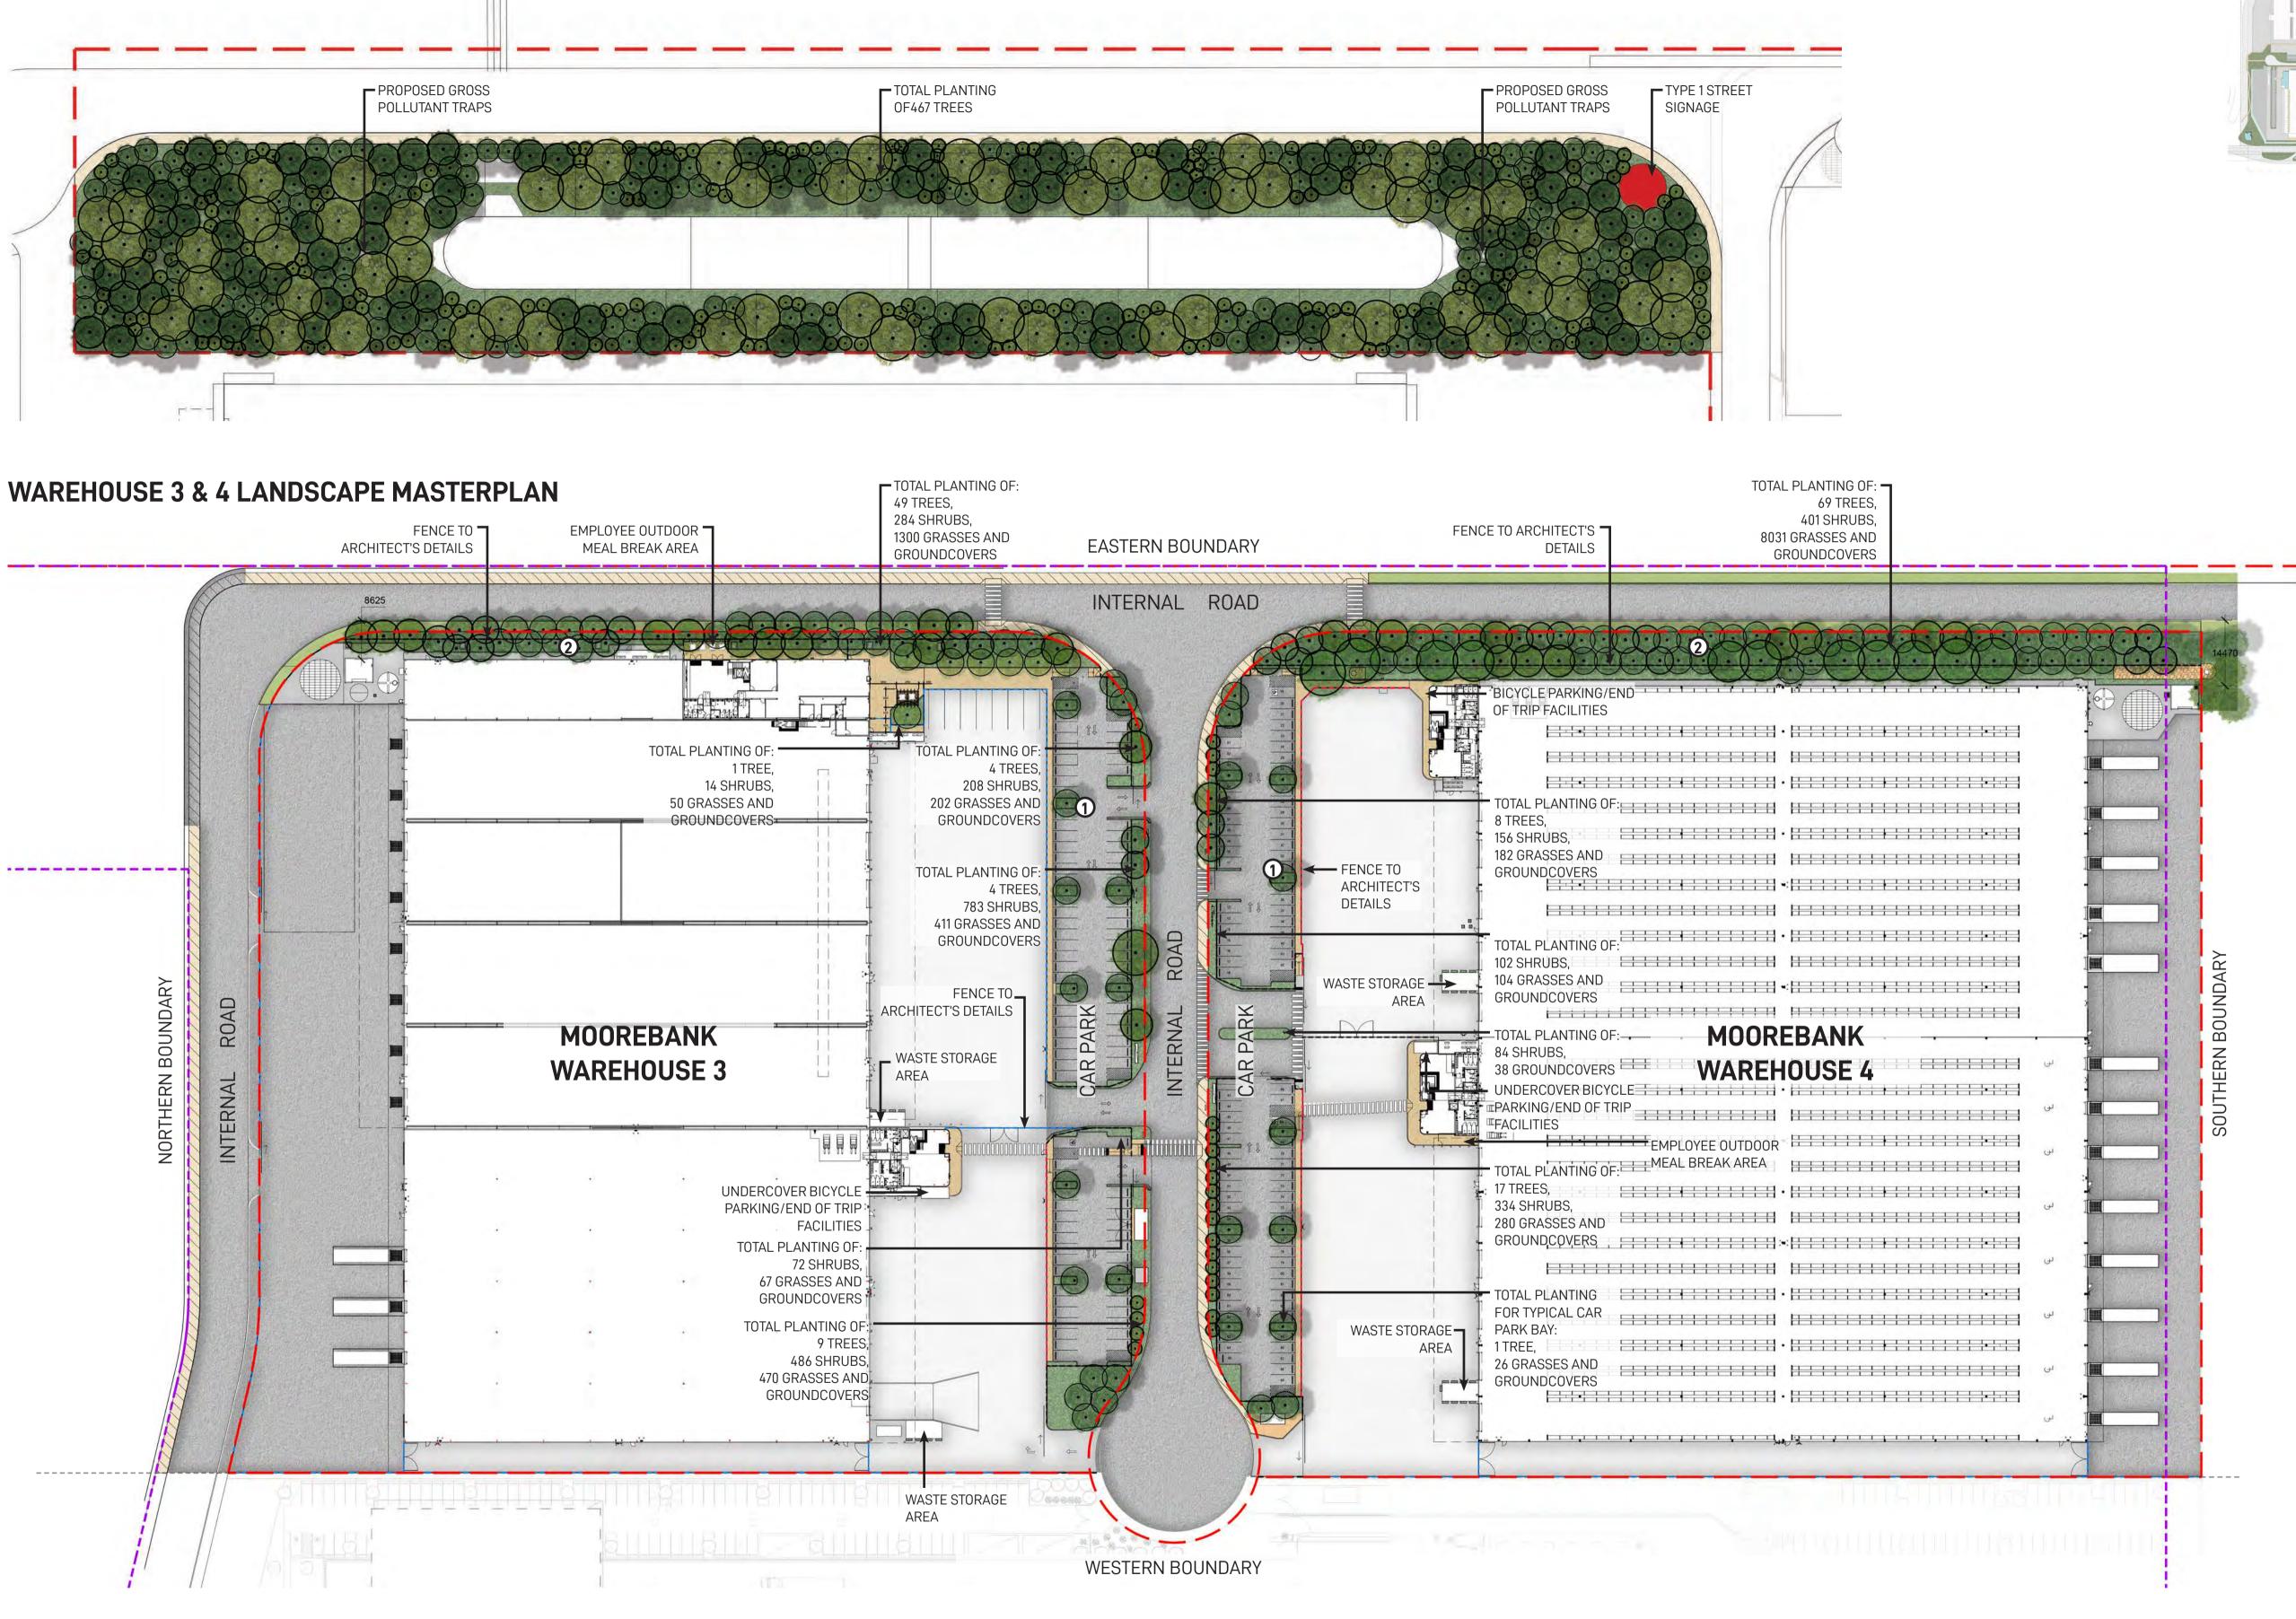


MOOREBAN

	Note	Issue	Date	Description	Drawn	Checked	Drawing Title
		6	26.11.19	Issue for coordination			
NCKEN	Verify all dimensions on site before commencing work. Report all discrepancies to Landscape Architect prior to construction. Figured dimensions to be taken in preference to scaled drawings.	7	10.12.19	Issue for coordination			
NUREN		8	14.01.20	Issue for coordination			WAREHOUSE 3 & 4 PRECINCT
CP)	All work is to conform to relevant Australian standards and other codes as applicable.	9	13.02.20	Issue for coordination			
GF)	Location of underground services to be proven on site and protected if necessary prior to construction. Dial before you dig.	10	21.02.20	Issue for coordination			LANDSCAPE MASTERPLAN
		11	28.02.20	Issue for coordination			
02) 9770 7600	Plant species and quantities shown are indicative only and are subject to change based on future project requirements.	12	05.08.20	Issue for coordination			
en.com.au/		13	16.12.20	Issue for coordination			

KEY PLAN

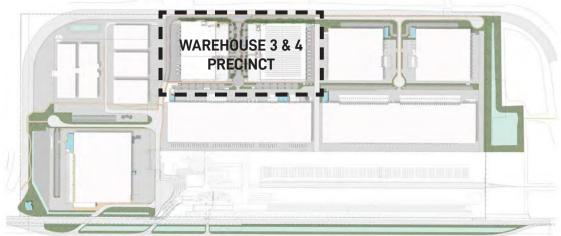

LEGEND

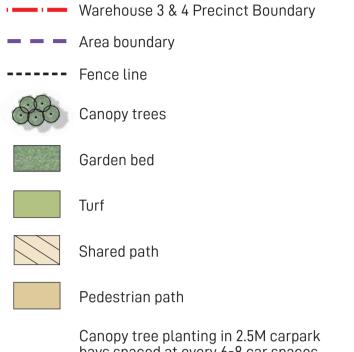


bays spaced at every 6-8 car spaces providing amenity and visual screening of warehousing in accordance with condition b140(e)(iii) & b140(e)(vi)

Mix of native canopy trees and shrubs providing visual mitigation of proposed warehouses

648 trees in 18,114 m^2 = 1 tree/27 m^2

FOR COORDINATION

Job Number Drawn Checked Drawing Number 16-12-20 20190408 KF RL W3W4-GNK-LN-DWG-2001 roiect Warehouses 3 & 4 UDLP Moorebank Logistics Park, Moorebank NSW Scale 1:750 @ A1 Rev 0 5 10 15 20m I I I I I 13

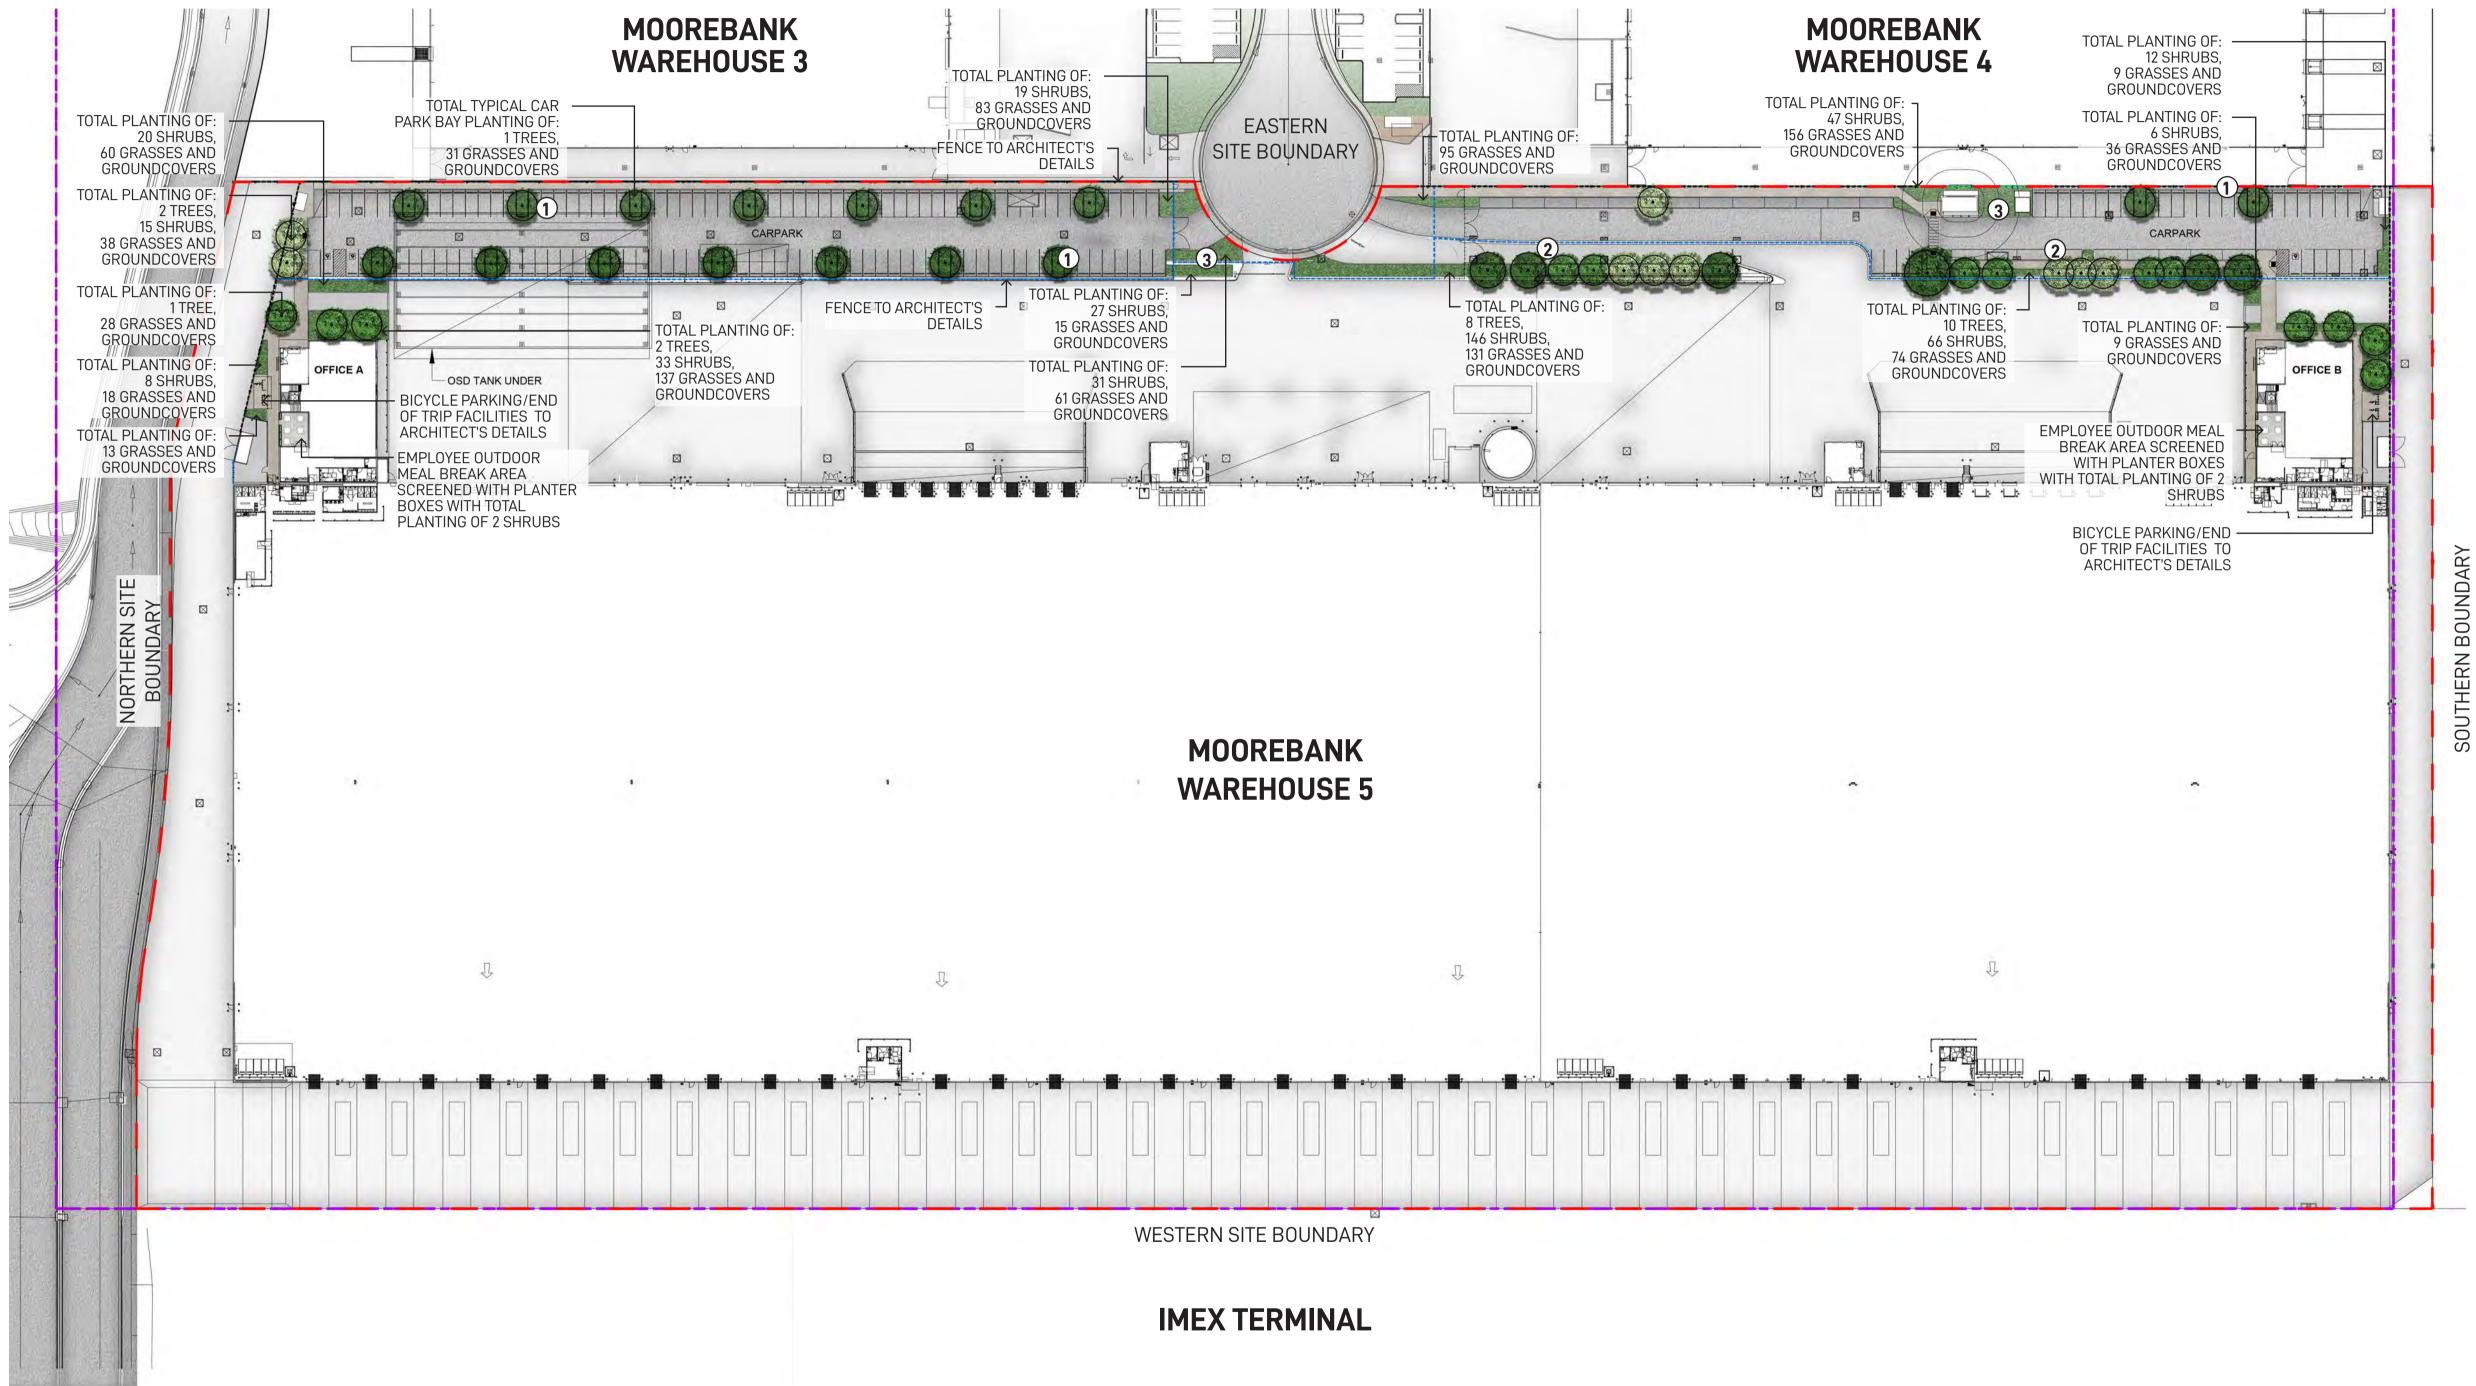





Client

Architect







	Note	Issue	Date	Description	Drawn	Checked	Drawing Title
	Verify all dimensions on site before commencing work. Report all discrepancies to Landscape Architect prior to construction. Figured dimensions to be taken in preference to scaled drawings.		15.11.19	Preliminary issue for coordination			
			26.11.19	Preliminary issue for coordination			
	All work is to conform to relevant Australian standards and other codes as applicable.	D	29.01.20	Preliminary issue for coordination			W/
	All work is to comorn to relevant Australian standards and other codes as applicable.	E	13.02.20	Preliminary issue for coordination			
	Location of underground services to be proven on site and protected if necessary prior to construction. Dial before you dig.		19.02.20	Preliminary issue for coordination			
		G	24.02.20	Preliminary issue for coordination			
	Plant species and quantities shown are indicative only and are subject to change based on future project requirements.	Н	28.02.20	Preliminary issue for coordination			
	·····	I	05.08.20	Preliminary issue for coordination			



KEY PLAN



LEGEND

---- Area boundary ----- Fence line \odot Proposed canopy trees Proposed garden bed Hard landscaping Proposed canopy tree planting in 2.5M carpark bays spaced at every 6-8 car spaces providing amenity and visual screening of 1 proposed warehousing in accordance with condition b140(e)(iii) & b140(e)(vi) Proposed mix of native canopy trees and shrubs providing visual mitigation of 2 proposed warehouses

Warehouse 5 Precinct Boundary


Proposed mix of native shrubs and groundcovers providing visual mitigation 3 and screening of proposed warehouses

48 trees in 1,018m² = 1 tree/21m²

			PREL	.IMINARY	FOR COORDINATION
	Date 05-08-20	Job Number 20190511	Drawn KF	Checked RL	Drawing Number WHP5-GNK-LN-DWG-1001
SE 5 LANDSCAPE STERPLAN		DUSES 5 UI k Logistics Pa	bank NSW	North	
	Scale 1:75	0 @ A1		Rev	
	0 5 1 I I I	0 15 20m I I			I



Appendix 3 – Area 3 Landscape Drawings and Figures

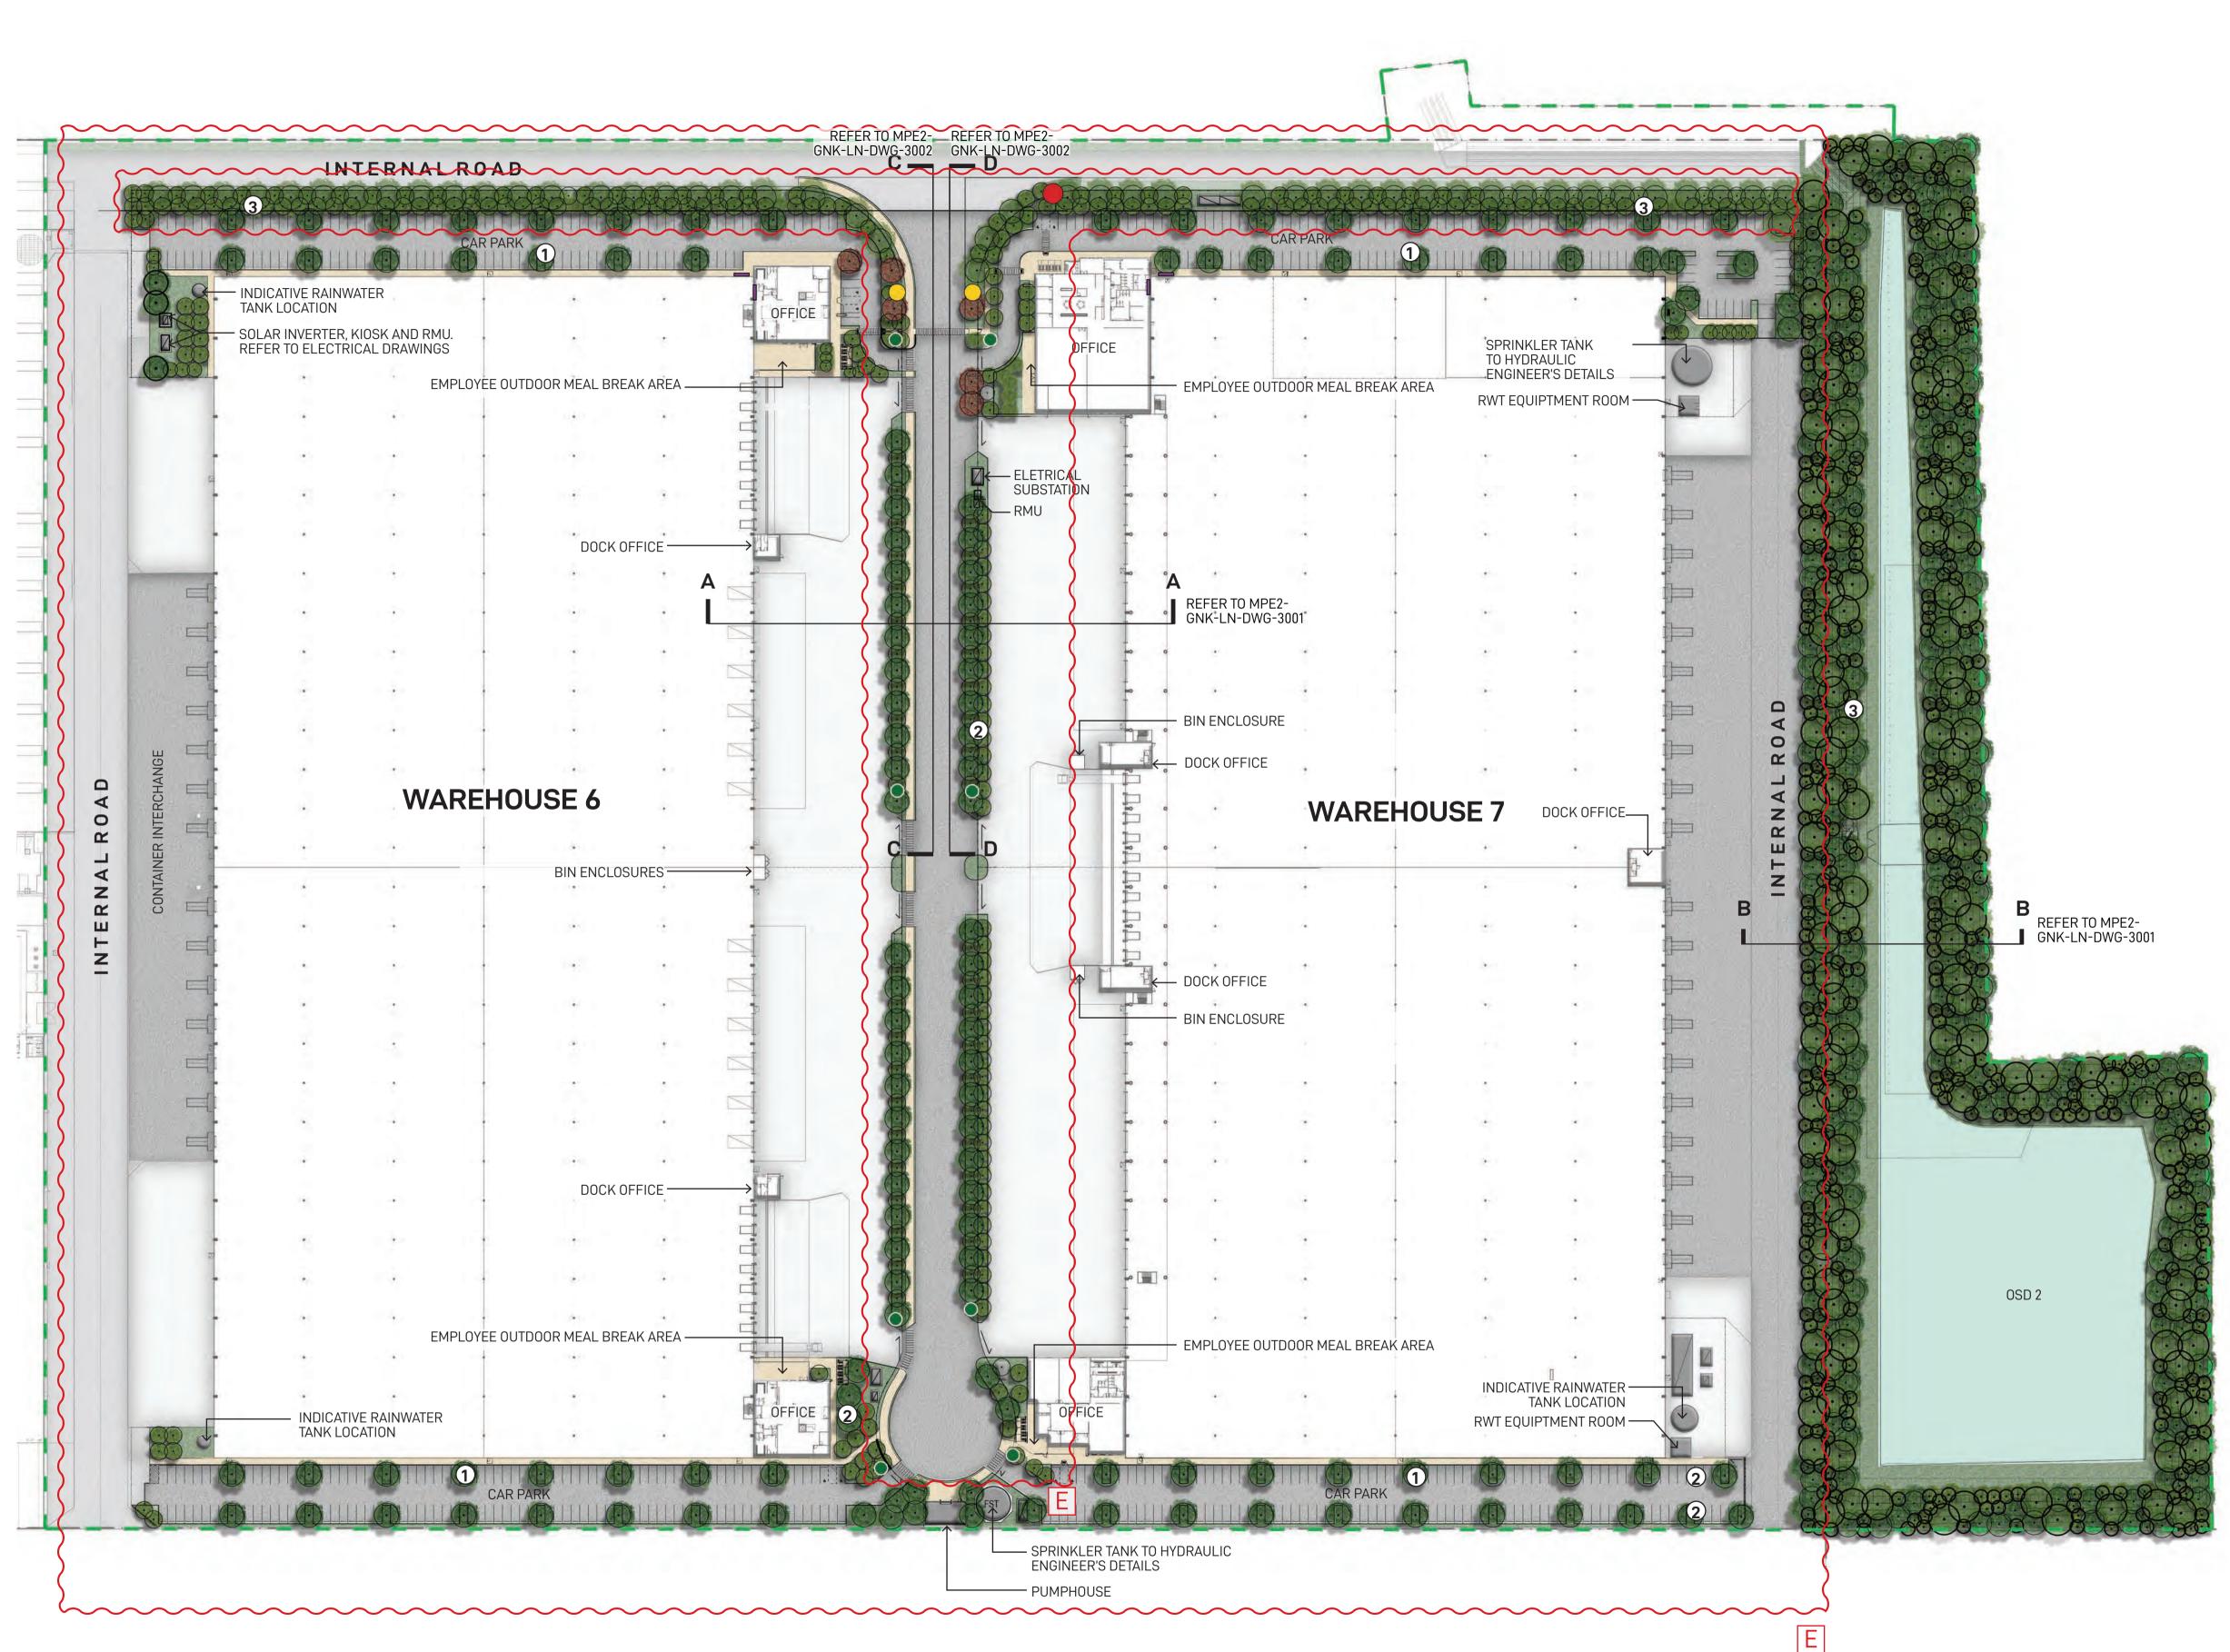



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Landscape Architect



29/88 Phillip Street, Sydney, NSW 2000

Ph. (02) 81973900

www.logosproperty.com.au



www.watsonyoung.com.au




ECT	
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Note
Verify all dimensions on site before commencing work. Report all discrepancies to Landscape Architect prior to construction. Figured dimensions to be taken in preference to scaled drawings
All work is to conform to relevant Australian standards and other codes as applicable.
Location of underground services to be proven on site and protected if necessary prior to construction. Dial before you dig.
Plant species and quantities shown are indicative only and are subject to change based on future project requirements.

Issue Date Description A04.06.20Issue for CoordinationB28.10.20Issue for Coordination C 28.10.20 Issue for Coordination D 16.12.20 Issue for Coordination E 21.07.22 Issue for Coordination



KEY PLAN

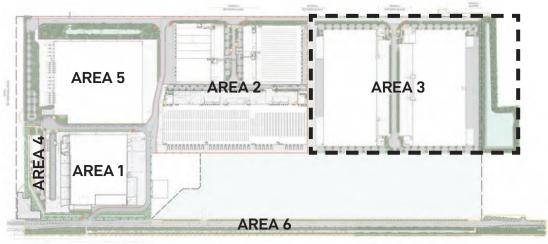

LEGEND


	Area 3 Boundary
	Hard Landscaping
	Proposed Garden Bed
	Proposed Canopy Trees
	Proposed OSD
	Type 1 Street Signage
\bigcirc	Type 2 Tenant Identification Signage
	Type 3 Direction Signage
	Type 4 Corporate Signage
1	Proposed canopy tree planting in 2.5M carpark bays spaced at every 6-8 car spaces providing amenity and visual screening of proposed warehousing in accordance with condition b140(e)(iii) & b140(e)(vi)
2	Proposed enlarged parking bays


Proposed mix of native canopy trees and shrubs providing visual mitigation of proposed warehouses

<u>NOTE</u>

Elements shown in plans are indicative and are subject to final design

INDICATIVE TREE IMAGES

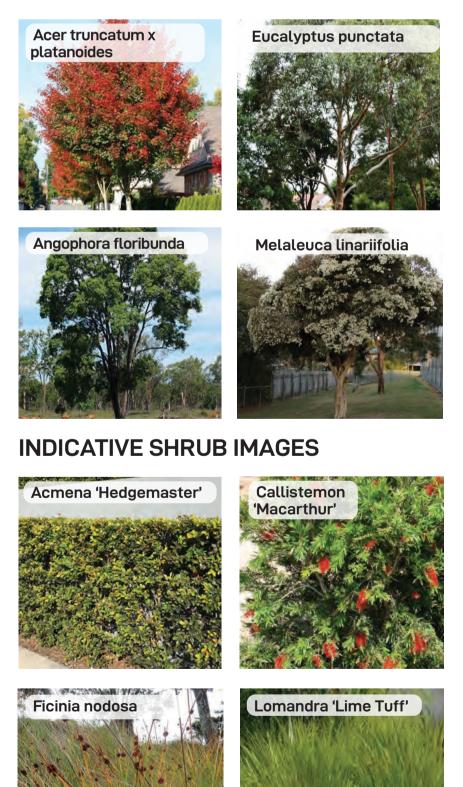

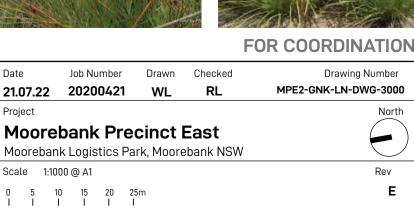


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AREA 3



Appendix 4 – Areas 4 to 6 Typical Landscape Drawings and Figures



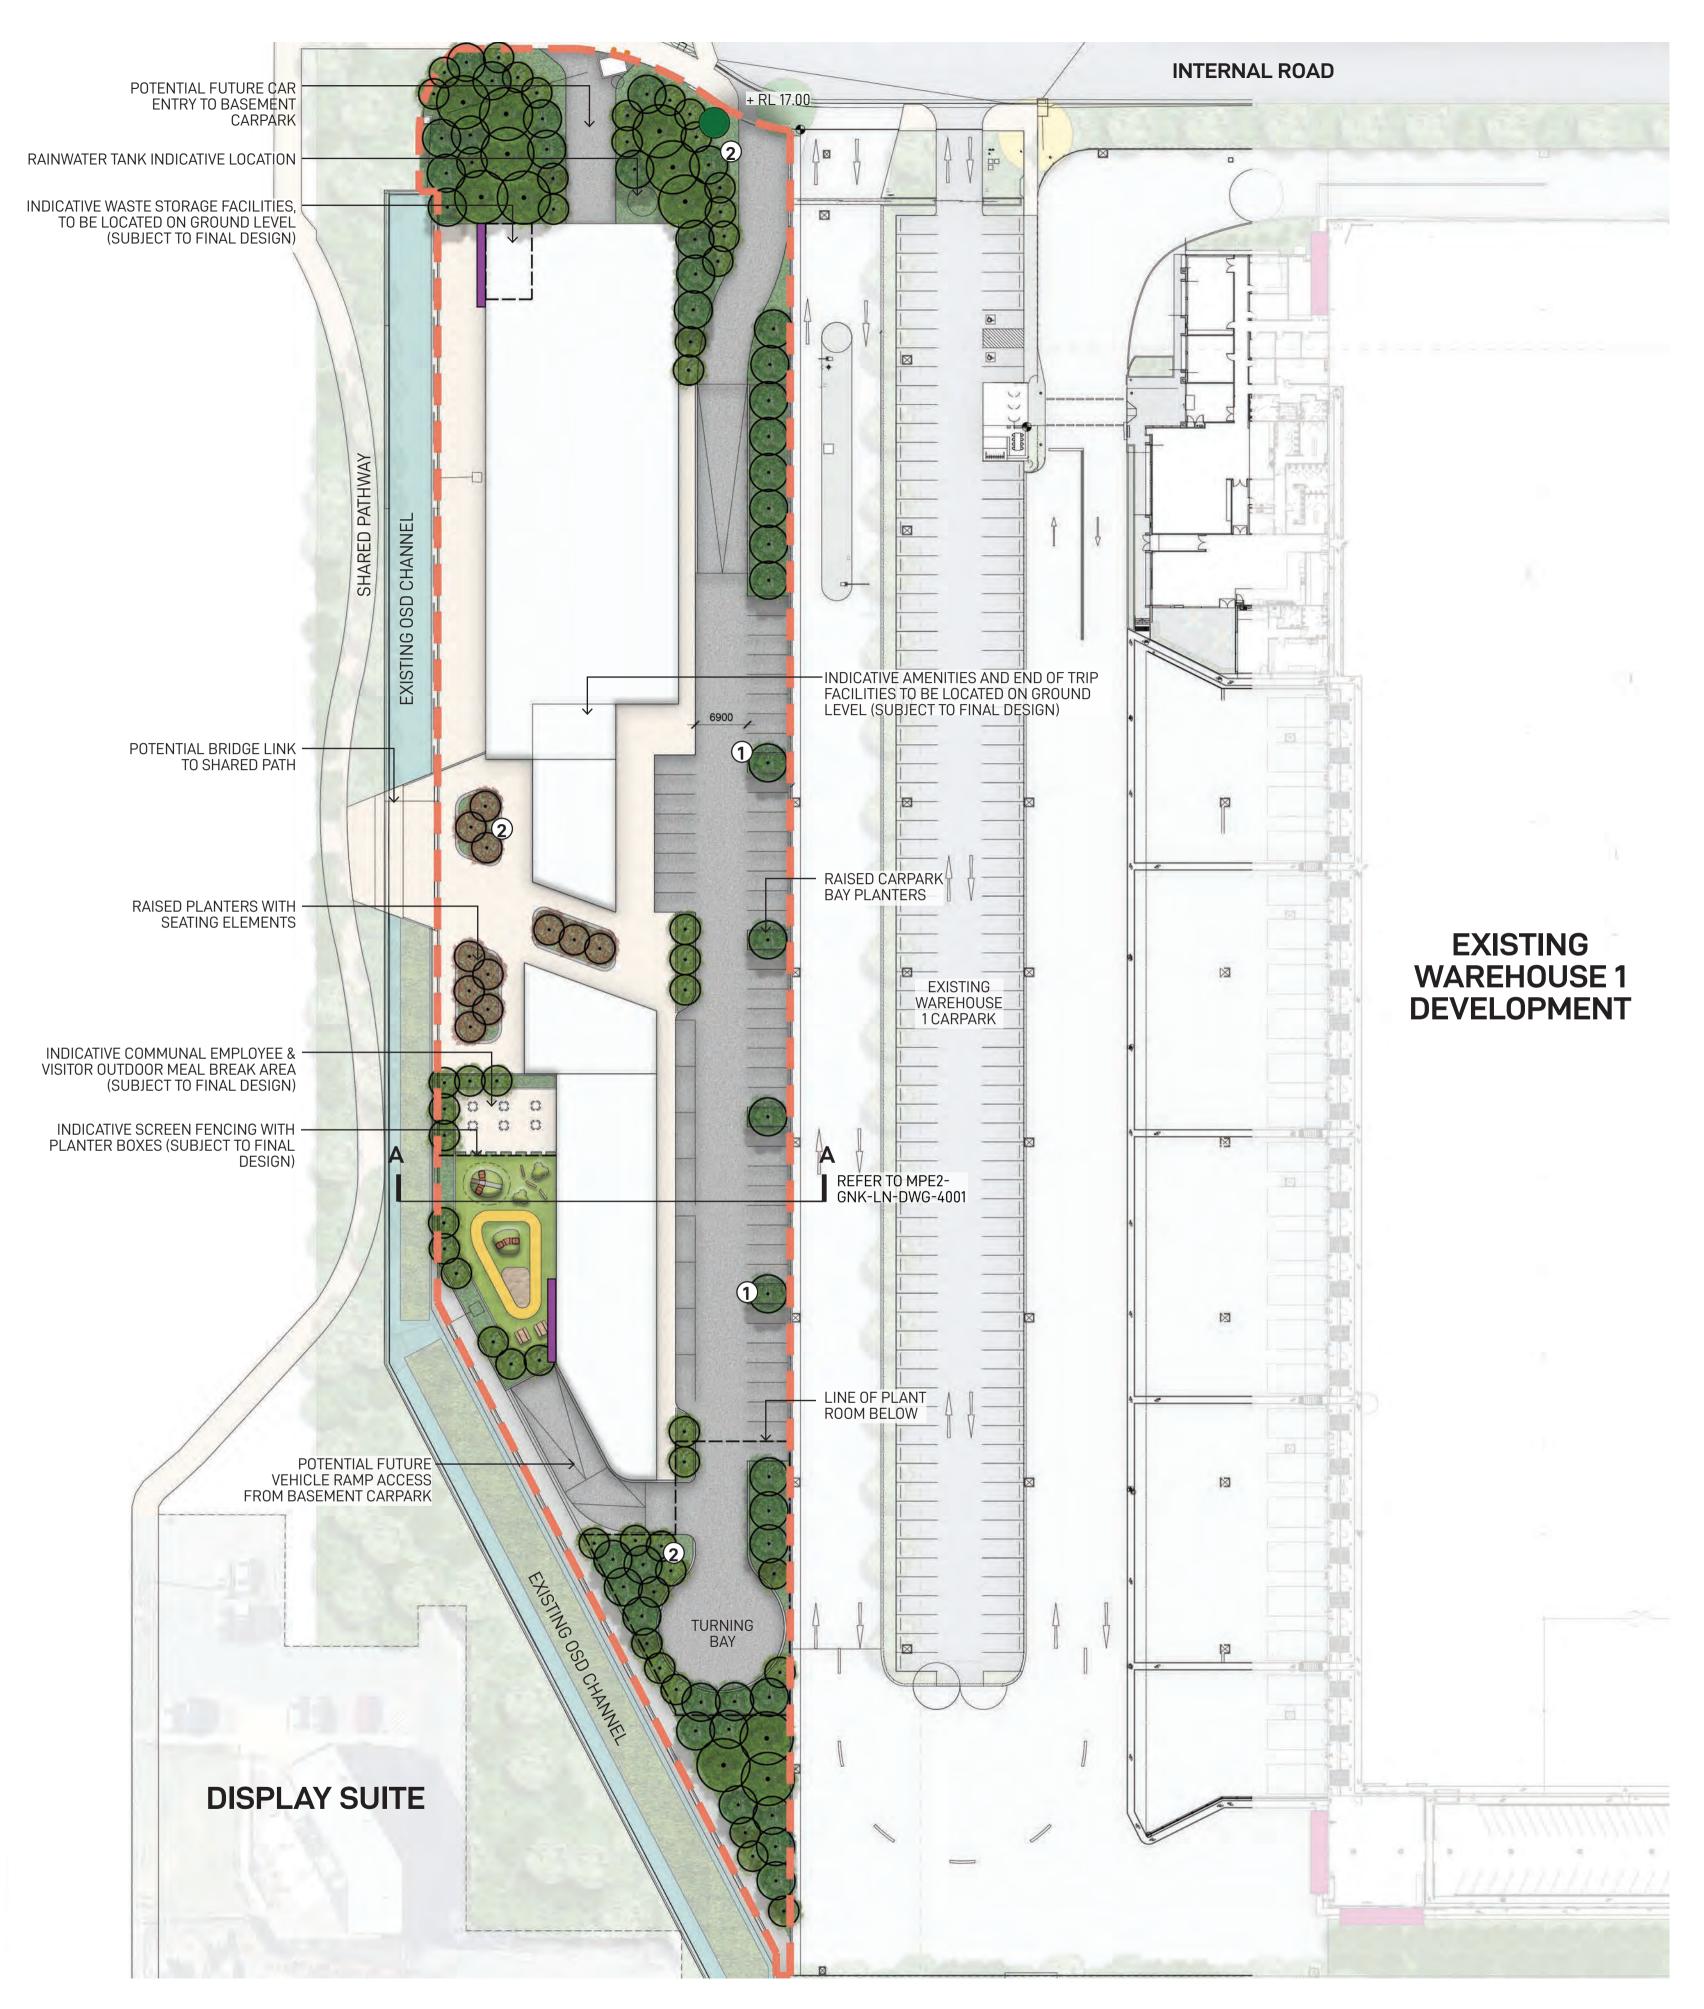

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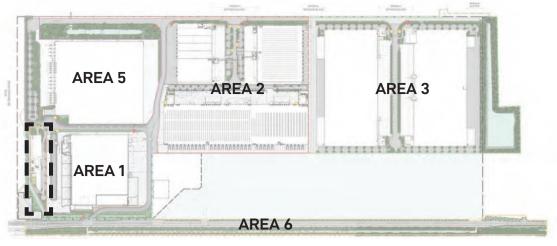
CT	
cuit 53	

Note Verify all dimensions on site before commencing work. Report all discrepancies to Landscape Architect prior to construction. Figured dimensions to be taken in preference to scaled drawings. All work is to conform to relevant Australian standards and other codes as applicable. Location of underground services to be proven on site and protected if necessary prior to construction. Dial before you dig. Plant species and quantities shown are indicative only and are subject to change based on future project requirements.

Issue Date Description A 04.06.20 Issue for Coordination B 28.10.20 Issue for Coordination C 28.10.20 Issue for Coordination D 16.12.20 Issue for Coordination E 21.07.22 Issue for Coordination

Drawn Checked Drawing Title

KEY PLAN



LEGEND



Pedestrian Path

Proposed Garden Bed



Proposed Canopy Trees

Type 3 Direction Signage

Type 4 Corporate Signage

Proposed canopy tree planting in 2.5M carpark bays spaced at every 6-8 car spaces providing amenity and visual screening of proposed warehousing in accordance with condition b140(e)(iii) & b140(e)(vi)

Proposed mix of native canopy trees and shrubs providing visual amenity

<u>NOTE</u>

- Indicative building footprints are representative of approximately 8,000m² GFA (Subject to future building design)
- Elements shown in plans are indicative and are subject to final design



Date	Job Number	Drawn	Checked	Drawing Number			
21.07.22	20200421	WL	RL	MPE2-GNK-LN-DWG-4000			
Project				North			
	Moorebank Precinct East						
Mooreban	k Logistics P	ark, Moore	ebank NSW	\smile			
Scale 1:50	10 @ A1			Rev			
0 2.5 5 I I	5 7.5 10 12 I I I	.5m I		E			





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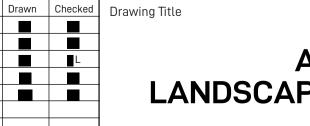





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53	

Note Verify all dimensions on site before commencing work. Report all discrepancies to Landscape Architect prior to construction. Figured dimensions to be taken in preference to scaled drawings. All work is to conform to relevant Australian standards and other codes as applicable. Location of underground services to be proven on site and protected if necessary prior to construction. Dial before you dig. Plant species and quantities shown are indicative only and are subject to change based on future project requirements.

Je	Date	Description
	04.06.20	Issue for Coordination
	28.10.20	Issue for Coordination
	28.10.20	Issue for Coordination
	16.12.20	Issue for Coordination
	21.07.22	Issue for Coordination



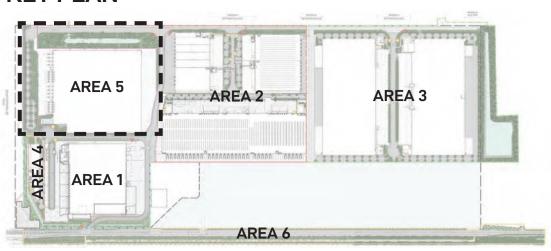


LEGEND

	Area 5 Boundary
	Hard Landscaping
	Proposed Garden Bed
	Proposed Canopy Trees
	Type 1 Street Signage
\bigcirc	Type 2 Tenant Identification Signage
	Type 3 Direction Signage
	Type 4 Corporate Signage
1	Proposed canopy tree planting in 2.5M carpark bays spaced at every 6-8 car spaces providing amenity and visual screening of proposed warehousing in accordance with condition b140(e)(iii) & b140(e)(vi)
2	Proposed mix of native canopy trees and shrubs providing visual mitigation of proposed warehouses

NOTE

Elements shown in plans are indicative and are subject to final design

INDICATIVE TREES

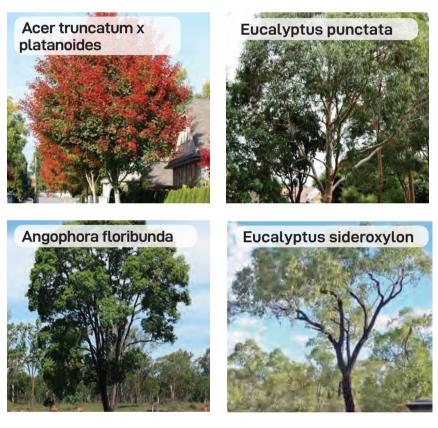


INDICATIVE SHRUB & GRASSES



AREA 5 LANDSCAPE MASTERPLAN

Date	te Job Number Drawn Checked		Drawing Nu	mber				
21.0	7.2	2 2	2020	0421	WL	RL	MPE2-GNK-LN-DWG	-5000
Proje	ct							North
Мс	Moorebank Precinct East							
Moorebank Logistics Park, Moorebank NSW						7		
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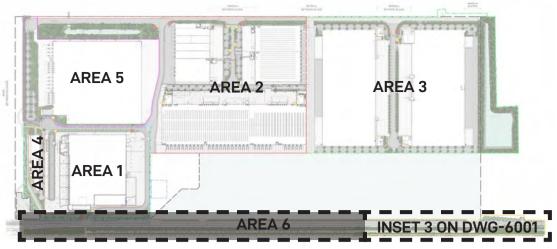




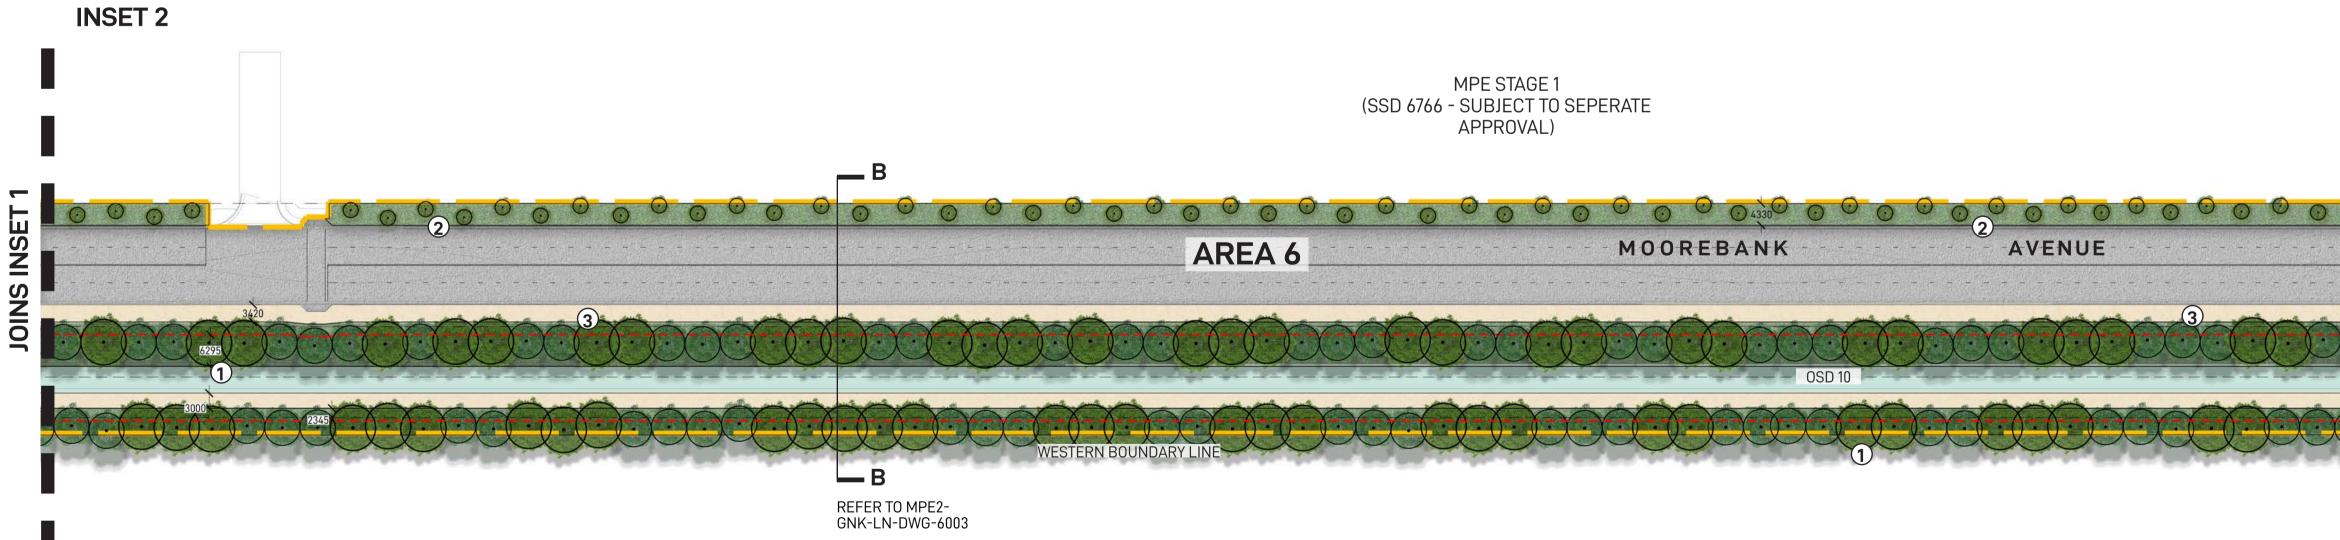

	Note	Issue	Date	Description	Drawn	Checked	Drawing Title
		Α	04.06.20	Issue for Coordination			
	Verify all dimensions on site before commencing work. Report all discrepancies to Landscape Architect prior to construction. Figured dimensions to be taken in preference to scaled drawings.	В	28.10.20	Issue for Coordination			
	All work is to conform to relevant Australian standards and other codes as applicable.	С	28.10.20	Issue for Coordination			
СТ		D	16.12.20	Issue for Coordination			, , , , , , , , , , , , , , , , , , , ,
ıit	Location of underground services to be proven on site and protected if necessary prior to construction. Dial before you dig.	E	07.07.22	Issue for Coordination			
3							
	Plant species and quantities shown are indicative only and are subject to change based on future project requirements.						
tal.com.au/							

KEY PLAN



Hard Landscaping

Proposed Garden Bed

Proposed Canopy Trees

LEGEND

Area 6 Boundary



2.5m clearance off proposed pavement ____ in accordance with guideline (ii) of R179 Landscape Planting (Ed 1/Rev 3, Jan 2019)

> Proposed canopy tree planting at 7-10m spacing in accordance with guideline (vii) of RMS Landscape Design Guidelines (Dec 2018)


Proposed clear zone with Acacia and low frangible planting in accordance with guideline (iii) of RMS Landscape Design Guidelines (Dec 2018)


Proposed mix of low level shrubs and grasses within 2.5m pavement clearance in accordance with guideline (ii) of R179 Landscape Planting (Ed 1/Rev 3, Jan 2019)

NOTE


Elements shown in plans are indicative and are subject to final design

INDICATIVE TREES

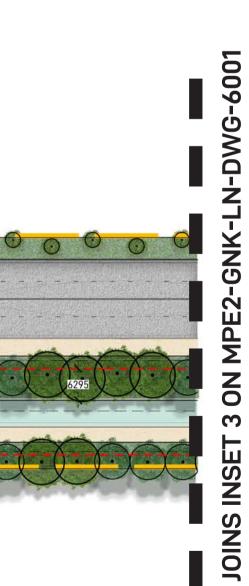


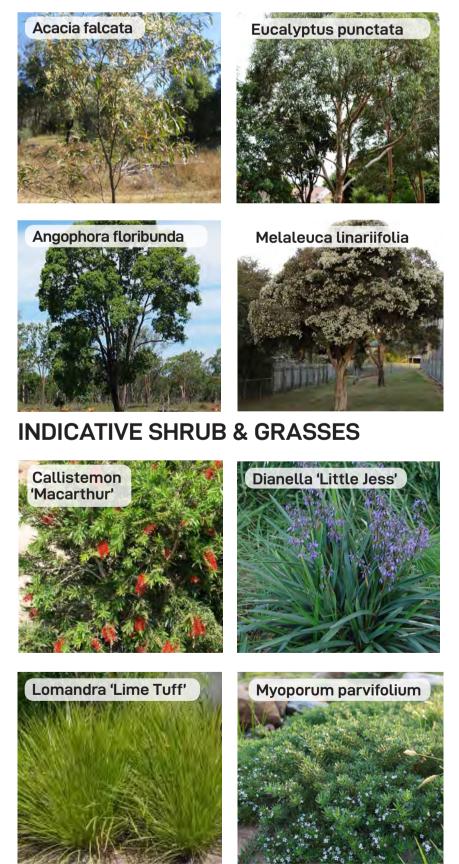

FOR COORDINATION

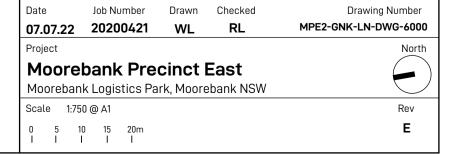

AREA 6 PE MASTERPLAN 1

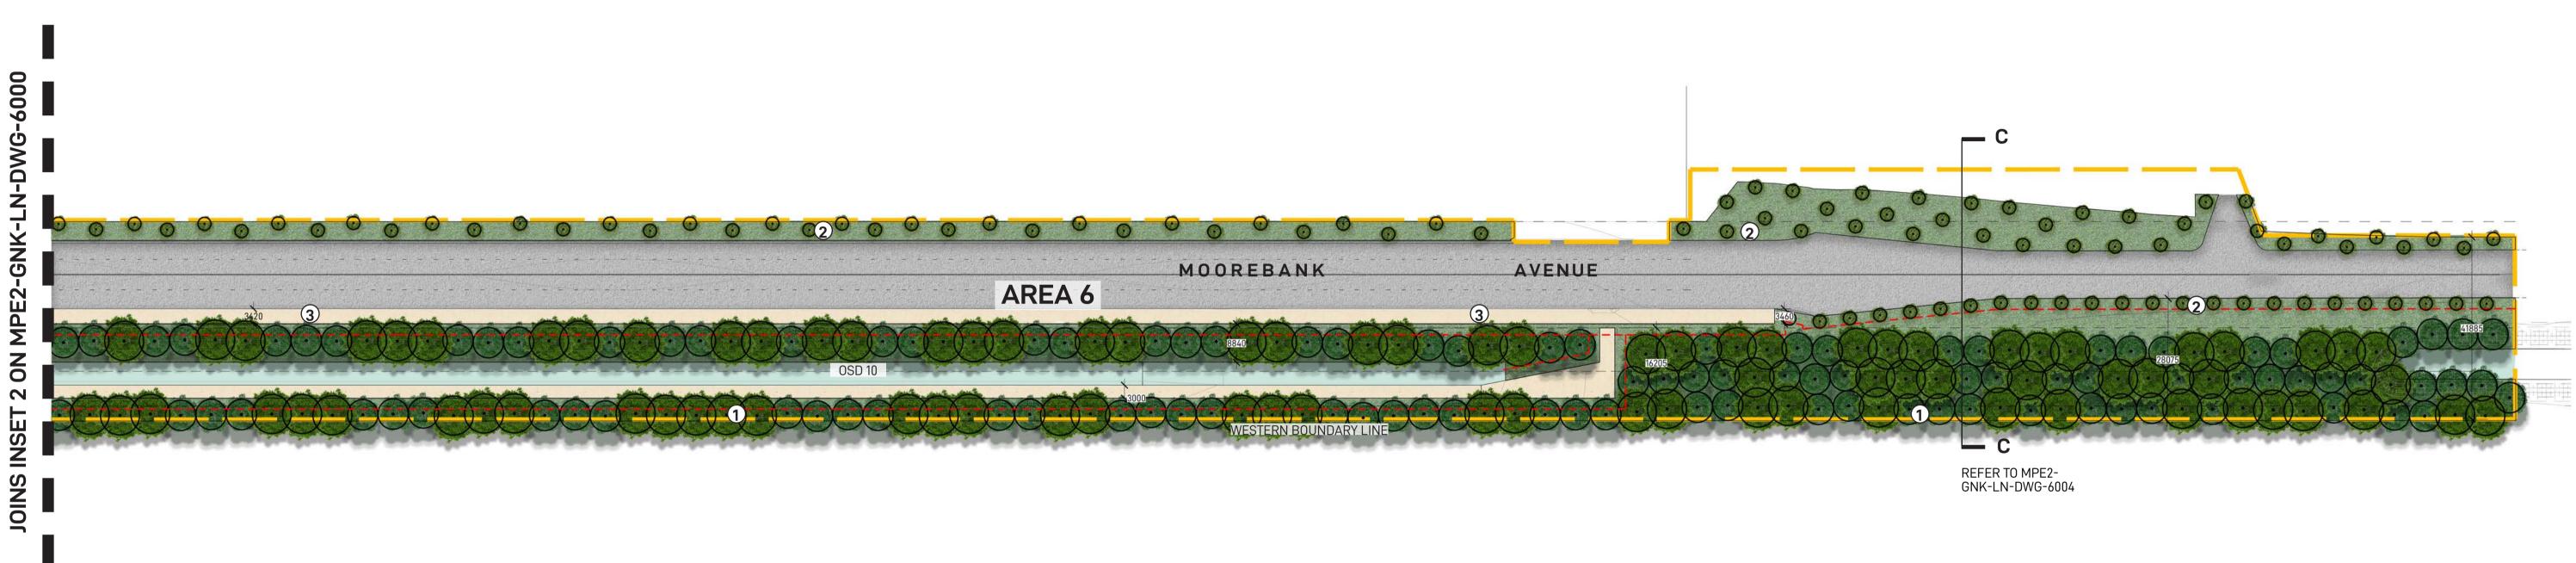

INDICATIVE TREES

INSET 3





Melaleuca linariifolia

Client


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INDICATIVE SHRUB & GRASSES









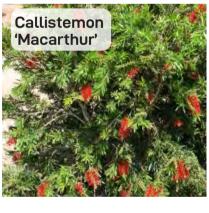


Landscape Architect








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	Note	Issue	Date	Description	Drawn	Checked	Drawing Title
		A	04.06.20	Issue for Coordination			-
	Verify all dimensions on site before commencing work. Report all discrepancies to Landscape Architect prior to construction. Figured dimensions to be taken in preference to scaled drawings.	В	28.10.20	Issue for Coordination			
	All work is to conform to relevant Australian standards and other codes as applicable.	С	28.10.20	Issue for Coordination			
		D	16.12.20	Issue for Coordination			
	Location of underground services to be proven on site and protected if necessary prior to construction. Dial before you dig.	E	07.07.22	Issue for Coordination			LANDSCAP
	Plant species and quantities shown are indicative only and are subject to change based on future						
	project requirements.						
m.au/							

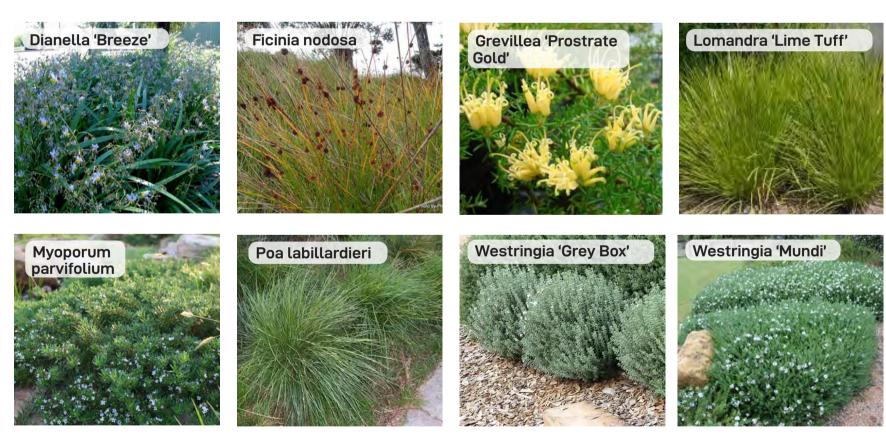KEY PLAN



LEGEND

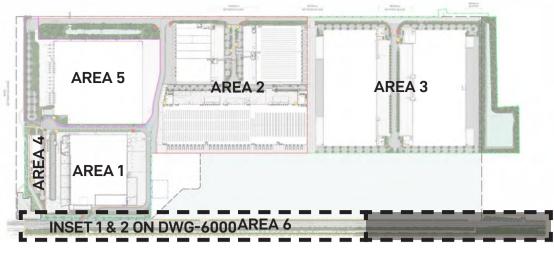Area 6 Boundary



1

2

3

Hard Landscaping

- Proposed Garden Bed
 - Proposed Canopy Trees

Proposed OSD

2.5m clearance off proposed pavement ____ in accordance with guideline (ii) of R179 Landscape Planting (Ed 1/Rev 3, Jan 2019)

> Proposed canopy tree planting at 7-10m spacing in accordance with guideline (vii) of RMS Landscape Design Guidelines (Dec 2018)

Proposed clear zone with Acacia and low frangible planting in accordance with guideline (iii) of RMS Landscape Design Guidelines (Dec 2018)

Proposed mix of low level shrubs and grasses within 2.5m pavement clearance in accordance with guideline (ii) of R179 Landscape Planting (Ed 1/Rev 3, Jan 2019)

<u>NOTE</u>

Elements shown in plans are indicative and are subject to final design

	Date 07.07.22	Job Number 20200421	Drawn WL	Checked RL	Drawing Number MPE2-GNK-LN-DWG-6001
	Project				North
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