

CYCLING AND PEDESTRIAN ACCESS AND FACILITIES SUB PLAN

Moorebank Precinct East Stage 2

13 OCTOBER 2022



SYDNEY INTERMODAL TERMINAL ALLIANCE

Cycling and Pedestrian Access and Facilities Sub Plan

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This Cycling and Pedestrian Access and Facilities Sub Plan (CPAFSP) was originally prepared by Arcadis in consultation with Reid Campbell (Architects) and nettletontribe.

This consolidated version of the CPAFSP has been prepared by Aspect Environmental.

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Cycling and Pedestrian Access and Facilities Sub Plan



Area 2 Contributor Details	Qualifications and Experiences
Consolidated Plan	
Contributor Details	Qualifications and Experiences



REVISIONS

Revision	Date	Description	Prepared by	Approved by
001	24/07/2018	Initial draft to Tactical		
002	14/08/2018	Updated for submission to Liverpool City Council (also submitted to DP&E on 09/05/2018)		
003	18/04/2019	Updated with DP&E and GANSW comments		
004	06/06/2019	Updated to reflect change in OSD 9 design layout		
005	26/02/2020	Updated to include Area 2 and any updates relating to Mod 2		
005B	14/05/2020	Updated to include LCC's consultation regarding Area 2		
005C	12/08/2020	Updated to include DPE's consultation regarding Area 2		
006	26/06/2020	Updated to include all Areas (consolidated plan)		
007	3/11/2020	Updated to include DPE/GANSW and LCC's consultation regarding the Consolidated UDLP, and to reflect updates to Area 2		
008	13/10/2022	Updated to reflect design change to Area 3		



ACRONYMS AND DEFINITIONS

Term	Meaning	
Area 1	Warehouse 1 and immediate surrounding area (not including the freight village)	
Area 2	Area incorporating Warehouses 3, 4 and 5 between IMEX terminal and eastern boundary of MPE Site.	
Area 3	Area incorporating Warehouses 6 and 7 including OSD 2, between IMEX terminal and eastern boundary of MPE Site	
Area 4	Area incorporating the freight village, within the northern portion of Area 1	
Area 5	Area incorporating Warehouse 2, in the north eastern corner of the MPE Site	
Area 6	Area incorporating Moorebank Avenue	
CBD	Central Business District	
CoCs	Conditions of Consent	
CPAFSP	Cycling and Pedestrian Access and Facilities Sub Plan	
DJLU	Defence Joint Logistics Unit	
DPE	Department of Planning and Environment (formerly Department of Planning, Industry and Environment (DPIE))	
EIS	Environmental Impact Statement	
EP&A Act	Environmental Planning and Assessment Act 1979	
FCMMs	Final Compilation of Mitigation Measures	
GANSW	Government Architect NSW	
GFA	Gross floor area	
IMT	Intermodal terminal	
LCC	Liverpool City Council	
LGA	Local Government Area	
LOGOS	LOGOS Property Group	
MPE	Moorebank Precinct East	
OSD	On-site detention basin	
PCA	Property Council of Australia	
Project (the)	The construction and operational areas identified within the MPE Stage 2 RtS (previously referred to as the Amended Proposal Site within the MPE S2 RtS) and approved under SSD 7628.	
Project Site (the)	The construction and operational areas identified within the MPE Stage 2 RtS (previously referred to as the Amended Proposal Site within the MPE S2 RtS) and approved under	



Term	Meaning
	SSD 7628. The MPE Project Site includes Areas 1 to 6, as described in the UDLP and sub plans.
RtS	Response to Submissions
SIMTA	Sydney Intermodal Terminal Alliance
SSD	State significant development
UDLP	Urban Design and Landscape Plan



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1 BACKGROUND

The Project has been assessed by the Department of Planning and Environment (DPE) (formerly Department of Planning, Industry and Environment) under Part 4, Division 4.1 (now Division 4.7 as of 1 March 2018) of the *Environmental Planning and Assessment Act* 1979 (EP&A Act) as State significant development (SSD). The Planning Assessment Commission (PAC) (now the Independent Planning Commission) granted approval to the Sydney Intermodal Terminal Alliance (SIMTA) for the Moorebank Precinct East (MPE) Stage 2 Project on 31 January 2018 subject to Conditions of Consent (CoC (SSD 7628)) which comprises the second stage of development under the MPE Concept Approval (MP10_0193). DPE subsequently approved Modification 1 (MOD 1) in March 2022, MOD 2 on 31 January 2020, MOD 3 on 8 December 2020 and MOD 4 on 19 January 2021 under Section 4.55(1) of the EP&A Act.

This Cycling and Pedestrian Access and Facilities Sub Plan (CPAFSP) has been developed to contribute to the quality and safety of the pedestrian and cyclist environment associated with Stage 2 of the MPE Project (hereafter, the Project).

This CPAFSP addresses the relevant requirements of the consolidated SSD 7628 development consent, including the Environmental Impact Statement (EIS), Response to Submissions (RtS) and CoC, and all applicable guidelines and standards specific to the management of cyclists and pedestrian access into and around the Project Site. This CPAFSP forms part of the Urban Design and Landscape Plan (UDLP).

1.1 Introduction

The MPE Site, including the Project Site, is located approximately 27 km south-west of the Sydney Central Business District (CBD) and approximately 26 km west of Port Botany and includes the former Defence National Storage and Distribution Centre site. The MPE Site is situated within the Liverpool Local Government Area (LGA), in Sydney's South-West subregion, approximately 2.5 km from the Liverpool City Centre.

The MPE Project involves the development of an intermodal facility including warehouse and distribution facilities, freight village (ancillary site and operational services), stormwater, landscaping, servicing and associated works on the eastern side of Moorebank Avenue, Moorebank.

Stage 2 of the MPE Project (the Project) involves the construction and operation of warehousing and distribution facilities on the MPE Site and upgrades to approximately 1.5 km of Moorebank Avenue from approximately 35 m south of the northern boundary of the MPE Site to approximately 185 m south of the southern MPE Site boundary. The Project has been assessed by DPE under Part 4, Division 4.1 (now Division 4.7 as of 1 March 2018) of the *Environmental Planning and Assessment Act* 1979 (EP&A Act) as State significant development (SSD).

Key components of the Project include:

- approximately 300,000 m² gross floor area (GFA) of warehousing and ancillary offices
- freight village, 8,000 m² GFA of ancillary retail, commercial and light industrial land uses
- internal road network and hardstand across the site
- ancillary supporting infrastructure within the site, including:
 - stormwater, drainage and flooding infrastructure
 - fencing, signage, lighting, remediation and landscaping
- Moorebank Avenue upgrade including:
 - raising by about 2 m and some widening
 - embankments and tie-ins to existing Moorebank Avenue road levels
 - signalling and intersection works.

1.2 Purpose and Application

This consolidated CPAFSP has been developed to address CoC B141(d) and the Final Compilation of Mitigation Measures (FCMMs) 1E. The CPAFSP has been prepared by a suitably qualified and experienced



person(s), and approved by the Secretary (DPE) prior to commencement of construction of permanent built surface works and/or landscaping.

This CPSFSP aims to assist in safe cycling and pedestrian connectivity throughout the MPE Site. The most recent, approved version of this CPSFSP must be implemented prior to occupation of the warehouses and freight village, unless otherwise agreed by the Secretary.

This CPAFSP has been prepared for the entire Project Site. Area specific information is included as per the staging detailed in Section 1.3.

1.3 Staging of this Plan

Delivery of this CPAFSP will be staged (in accordance with CoC A14 and A15) to allow for the commencement of warehouse construction. The proposed staging of the CPAFSP is shown on Figure 1-1 and detailed within Table 1-1. This CPAFSP must be implemented prior to occupation of warehouses and/or the freight village, once approved by the Secretary in consultation with the Government Architect New South Wales (GANSW). Plan staging has been undertaken as per Table 1-1.

Table 1-1: Staged submission of the CPAFSP.

Works Area	Approximate Dates Plan Submission	Operational Area	Approximate Occupation Date
Area 1	Q2 2019	Warehouse 1 including area north of freight village	Interim OC 31/01/18
Area 2	Q2 2020	Warehouse 3, 4 and 5	Warehouse 3: Interim OC 20/03/20 Warehouse 4: Interim OC 22/05/20 Warehouse 5: Q4 2020
Area 3	Q2 2022	Warehouse 6 and 7	Q2 2023
Areas 4 – 6	ТВС	Warehouse 2, the freight village, Moorebank Avenue Upgrade	TBC ¹

Note:

¹ Construction and occupational timing for Areas 4 – 6 is subject to market demand and future approvals.

1.3.1 Activities for the Stages

The activities associated with the stages include, but are not limited to:

- all ground preparation activities such as earthworks, services, on-site detention (OSD) construction across the warehouses (managed through the Construction Environmental Management Plan and sub-plans and Stormwater Management Plans)
- upgrade works to Moorebank Avenue
- construction and operation of the warehouses and freight village including:
 - construction and operation of parking facilities
 - construction and operation of internal road network and shared paths
 - installation of temporary solar lighting towers to illuminate roads and shared paths
 - landscaping
 - construction and operation of cycling and pedestrian facilities
 - installation of signage
 - construction and operation of end of trip facilities
 - construction and operation of employee outdoor meal break areas.



The activities for the stages include construction activities such as bulk earthworks, landscaping, roads, pavements and carparks, and warehouse construction and fit-out.

Approval from DPE for staging of development activities has already been granted as a separate process aside from this plan. Construction of each development stage will only commence once approval of stage has been obtained from the department.

1.3.2 Relationship of Stages

Area 1 was the first stage of this CPAFSP and included Warehouse 1 and the immediate area surrounding Warehouse 1 (excluding the freight village).

Area 2 was the second stage of this CPAFSP and included Warehouses 3, 4 and 5 and surrounds.

The final stage of the CPAFSP consolidated all areas into a final UDLP document, in order to demonstrate that the scheme and specific requirements of SSD 7628 have been achieved across the MPE Stage 2 Site. At the time of preparing the consolidated document, the detailed design and tenanting requirements for Areas 3 to 6 were not finalised. However, typical plans and drawings for these areas were developed based on what was approved for Area 1 and Area 2, and the requirements of the UDLP and this subplan (Appendix 3). They are therefore considered typical and representative of the urban design and landscape scheme that will be implemented across the site.

This CPAFSP has been delivered as followed:

- Area 1 details were prepared and approved by DPE prior to commencement of permanent built surface works and landscaping of Warehouse 1. This allowed the Project to commence construction of Warehouse 1, prior to the finalisation of the design for the remainder of the Project and did not restrict or constrain delivery of a complaint final detailed design across the remainder of the MPE Stage 2 Site.
- Area 2 was prepared and approved by DPE prior to commencement of landscaping of Warehouses 3, 4 and 5. Similarly, this allowed the Project to commence construction of warehousing in this Area, prior to the finalisation of the design for the remainder of the Project.
- The consolidated CPAFSP included details for Areas 3 to 6. It was approved by DPE on 5 February 2021, prior to the commencement of permanent built surface works and/or landscaping of Warehouses 2, 6 and 7, the freight village (Area 4) and upgrade of Moorebank Avenue (Area 6).
- The consolidated UDLP, including this CPAFSP, has been updated to reflect the amended layout for Area 3, reconfiguring Warehouses 6, 7 and 8 to two warehouses (Warehouses 6 and 7). The amended consolidated UDLP includes detailed design plans for Area 3 that are consistent with approved landscape plans for Areas 1 and 2. This updated UDLP, and including the updated CPAFSP, has been submitted to DPE for information.

1.3.3 Triggers

The trigger for submission of the future stages of this CPAFSP will be one month prior to permanent built surface works and/or landscaping of the next works area.



Urban Design and Landscape Plan



Figure 1-1 UDLP Staging



1.4 Relevant Policies, Guidelines and Plans

The relevant policies, guideline and planning instruments considered during development of this CPAFSP include:

- Liverpool City Council Development Control Plan 2008, Part 1, General Controls for All Developments
- City of Sydney Section 3 General Provisions
- Australian Standard AS 2890.3 1993 Parking Facilities Part 3: Bicycle Parking Facilities
- DIPNR (referred to currently as DPE) Planning Guidelines for Walking and Cycling 2004.

The City of Sydney Section 3 – General Provisions was considered a suitable guideline in that it specified bicycle provisions for individual land uses, similar types of development and providing a standard which is mid-range (i.e. did not over or under provide).

1.5 Compliance Matrices

The Project is being delivered under Part 4, Division 4.7 (previously Division 4.1 prior to 1 March 2018) of the EP&A Act. The CoC include requirements to be addressed in this plan and delivered during the Project. These requirements and how they are addressed is provided within Table 1-2. Note that there are no specific CoC from approved modifications relating to this plan.

In Table 1-2, Primary Conditions are specific to the development of the management plans, while Secondary Conditions are conditions which are related to the environmental aspects associated with the plan.

Table 1-2 Conditions of Consent (CoC)

CoC	Requirement	Document Reference	How Addressed
Primary C	ondition		
B140	The UDLP must be prepared by a suitably qualified and experienced person(s), in consultation with the relevant council(s). The UDLP must be approved by the Secretary, in consultation with the NSW Government Architect.	Author Details (page ii and iii) Section 1.2 Section 1.6 Appendix 0A\	This CPAFSP has been prepared by a suitably qualified professional and in consultation with LCC, DPE and GANSW, as detailed in Section 1.5 and Appendix 0A. The consolidated UDLP, including this subplan, was approved by DPE on 5 February 2021.
B141 (d)	Cycling and Pedestrian Access and Facilities Sub Plan to assist in safe cycling and pedestrian connectivity through the MPE precinct by providing dedicated linkages between the warehouses, the freight village and Moorebank Avenue that will contribute to the quality and safety of the pedestrian and cyclist environment associated with the development.	This plan	This CPAFSP has been prepared to assist in safe cycling and pedestrian connectivity by providing shared paths and footpaths throughout the Project. The CPAFSP will incorporate safe cycling and pedestrian connectivity between Areas 1 and 2 and the warehouses in Areas 3 and 5 as well as the freight village (Area 4) and Moorebank Avenue (Area 6).
	The Plan must be prepared by a suitably qualified and experienced person(s) and approved by the Secretary within twelve months of the date of this approval, unless otherwise agreed by the Secretary.	Title page Section 1.2	This CPAFSP has been prepared by a suitably experienced and qualified person, as shown on the cover page of this plan.



CoC	Requirement	Document Reference	How Addressed
			The plan was initially submitted to the Secretary on 05/09/2018 for Area 1.
	The Plan must be prepared by a suitably experienced and qualified person(s) in the design and provision of Cycling and Pedestrian Access and Facilities.	Title page	Area 1 of this CPAFSP has been prepared by who has over in traffic modelling and engineering, including active transport assessments.
			submitted to the Secretary. Area 2 of this CPAFSP has been
			A brief description of their experience and qualifications is included on the 2 nd page of this plan.
			The consolidated CPAFSP has been prepared by A brief description of their experience and qualifications is included on the 2 nd page of this plan.
	The Plan must detail the construction, timing and responsibility for the delivery of Cycling and Pedestrian Access and Facilities and take into account the following considerations:	Section 2.1	The relevant Construction Contractor will be responsible for the construction of the designed access and facilities. The design of the access was undertaken by the Principal's designers in liaison with the Principal's Representative and authors of this plan.
	(i) all relevant policies, guidelines and plans;	Section 1.4 Section 2.2	Relevant policies, guidelines and plans are identified in Section 1.4.
		has been prepared in cons with DPE, who have noted relevant policies/guidelines considered. Section 2.5 confirms CPAI been prepared in accordan	Section 2.2 confirms that this plan has been prepared in consultation with DPE, who have noted relevant policies/guidelines to be considered.
			Section 2.5 confirms CPAFSP has been prepared in accordance with the 2015 update of AS 2890.3.
	(ii) provide details for the provision of safe and efficient pedestrian and cyclist access connectivity within the development and include integration with the existing and	Section 2.2 Section 2.3	Pedestrian and cycle access is provided through the use of shared paths located throughout the site.
	future pedestrian and cycling access in the locality;		The shared paths will ultimately connect to all areas of the MPE Site as the development progresses.



CoC	Requirement	Document Reference	How Addressed
			Section 2.2 provides an overview of the cycle access and connectivity across the MPE Site, and more specific details for each Area.
			Section 2.3 provides an overview of the pedestrian access and connectivity across the MPE Site, and more specific details for each Area.
	(iii) provide details of end of trip facilities available on-site at each warehouse which are to include under cover bike storage, showers and change facilities sufficient to accommodate the needs of the forecast number of employee; and	Section 2.4	Section 2.4 provides details of the end of trip facilities include toilets, lockers, sinks and showers (male, female and ambulant) and bicycle parking facilities available in each Area.
	(iv) the layout, design and security of bicycle facilities must comply with the minimum requirements of Australian Standard AS 2890.3 – 1993 Parking Facilities Part 3:	Section 2.4 Section 2.5	Section 2.4 provides details on the amount and design of bicycle facilities at each Warehouse.
	Bicycle Parking Facilities.		Section 2.5 confirms that the design of bicycle facilities at the MLP East Precinct complies with the minimum standard requirements of <i>AS</i> 2890.3 – 1993 <i>Parking Facilities Part 3: Bicycle Parking Facilities</i> .
	The approved plan must be implemented prior to occupation of the warehouse and freight village.	Section 1.2	The approved plan will be implemented prior to occupation o the warehouses and freight village.
Seconda	ary Condition		
A14	With the approval of the Secretary, the Applicant may submit any strategy, plan or program required by this consent on a staged basis.	Section 1.3	The Secretary's approval for staging of this plan has already been obtained.
	If the submission of any strategy, plan or program is to be staged, then the relevant strategy, plan or program must clearly	Section 1.3	This CPAFSP has been completed in stages as described in Section 1.3.
A15	describe the specific stage of the development to which the strategy, plan or program applies, the relationship of the stage to any future stages and the trigger for updating the strategy, plan or program		This final consolidated version of the CPAFSP defines safe cycling and pedestrian connectivity for each Area within the MPE Site.
	,		As outlined in Section 1.3.3, this CPAFSP will be submitted to DPE one month prior to permanent bui surface works and/or landscaping of the next stage.



The Final Compilation of Mitigation Measures (FCMMs) were prepared as part of the Consolidated Assessment Clarification Responses issued to DP&E on 10 November 2017 (Arcadis 2017). A list of the FCMMs as relevant to the Project and how they have been complied with in this plan is provided in Table 1-3.

Table 1-3: Final Compilation of Mitigation Measures (FCMMs)

FCMM	Requirement	Document Reference
1E	Bicycle and end of trip facilities would be provided in accordance with the City of Sydney Section 3 – General Provisions.	Section 1.4

1.6 Consultation

This CPAFSP has been prepared in consultation with LCC, DPE and the GANSW.as outlined in Table 1-4. Supplementary information to support the consultation undertaken is included in Appendix 0A of this CPAFSP, and Appendix 0F of the UDLP document.

Table 1-4 Consultation summary

Agency	Date	Person Contacted	Comment	Status
	AREA 1			
	14/08/2018	LCC Representative	Draft UDLP and UDLP sub-plans emailed for review and comment	Closed
	14/08/2018	LCC Representative	Email requesting a meeting	Closed
	17/09/2018	LCC Representative	Email requesting a phone call	Closed
	21/09/2018	SIMTA	Email requesting a phone call regarding clarification on CoC A22, A23 and A24, as they relate to the above management plans	Closed
	02/10/2018	LCC Representative	Email requesting an update on progress of review	Closed
	03/10/2018	SIMTA	Email with reviewed plan, requesting feedback before finalisation	Closed
LCC	26/11/2018	LCC Representative	Email with updated UDLP and response to comments	Closed
	30/11/2018	SIMTA	Email confirming UDLP has been received for review	Closed
	23/01/2019	LCC Representative	Email requesting an update on progress of review	Closed
	23/01/2019	SIMTA	Email confirming review to occur within next week	Closed
	19/02/2019	SIMTA	Meeting request for 05/03/2019	Closed
	04/03/2019	LCC Representative	Meeting minutes sent via email	Closed
	06/03/2019	LCC Representative	Email with meeting minutes from 05/03/2019 meeting	Closed
	AREA 2			

Cycling and Pedestrian Access and Facilities Sub Plan



Agency	Date	Person Contacted	Comment	Status	
	7/02/2020	LCC Representative	Email (from Aspect Environmental) requesting meeting	Closed	
	13/02/2020	LCC Representative	LCC phone call requesting a meeting	Closed	
	13/02/2020	LCC Representative	LCC provided UDLP documentation, advised that a meeting may not be required	Closed	
	3/03/2020	LCC Representative	Aspect Environmental hand-delivered USB containing Area 2 UDLP documents to LCC. Phone call from LCC to confirm receipt of the USB, and to clarify request for comments in relation to Area 2	Closed	
	4/03/2020	LCC Representative	Phone call and follow up email requesting an update on progress of review	Closed	
	10/03/2020	LCC Representative	Phone call requesting an update on progress of review, meeting suggested	Closed	
	18/03/2020	LCC Representative	Phone call requesting an update on progress of review	Closed	
	25/03/2020	LCC Representative	Phone call requesting an update on progress of review	Closed	
	1/04/2020	LCC Representative	Phone call requesting an update on progress of review	Closed	
	2/04/2020	LCC Representative	Council contacted Aspect Environmental to advise that LCC were preparing a compliance matrix table to communicate their concerns or issues, and which would be provided as soon as possible	Closed	
	16/04/2020	LCC Representative	LCC provided compliance matrix table to Aspect Environmental regarding concerns and comments	Closed	
	1/05/2020	LCC Representative	Aspect Environmental provided response to LCC comments and concerns	Closed	
	13/05/2020	LCC Representative	LCC provided email confirmation that Council has assessed all conditions in relation to Area 2 and deem the UDLP to be satisfactory	Closed	
	CONSOLIDATED (including AREAS 3 to 6)				
	26/06/2020	LCC Representative	Consolidated UDLP documentation for MPE Site provided to LCC for review and comment in relation to Areas 3 to 6	Closed	
	6/07/2020	LCC Representative	LCC email confirming that Consolidated UDLP documentation received for comment	Closed	

Cycling and Pedestrian Access and Facilities Sub Plan

SIMTA =

Agency	Date	Person Contacted	Comment	Status
	7/07/2020	LCC Representative	Follow up email and phone call, to brief on Consolidated UDLP documentation	Closed
	6/08/2020	LCC Representative	Email requesting an update on progress of review	Closed
	7/08/2020	LCC Representative	Email confirmation from LCC that review is in progress	Closed
	27/08/2020	LCC Representative	Phone call and email requesting an update on progress of review	Closed
	9/09/2020	LCC Representative	Phone call and email requesting an update on progress of review	Closed
	11/09/2020	LCC Representative	Email confirmation from LCC that review is in progress	Closed
	28/09/2020	LCC Representative	LCC provided comments regarding the Consolidated UDLP	Closed
	16/10/2020	LCC Representative	Aspect provided response to Council comments	Closed
	AREA 1			
	28/08/2018	DP&E (on behalf of GANSW)	Presentation on UHIMS and UDLP at DP&E office	Closed
	05/09/2018	DP&E (on behalf of GANSW)	Draft plan emailed for review and comment	Closed
	18/10/2018	SIMTA	Email with table of review comments	Closed
	Various	Various	DP&E fortnightly meetings and emails discussing comments	Closed
	6/12/2018	DP&E (on behalf of GANSW)	Email with updated drawings and figures	Closed
GANSW	22/01/2019	DP&E (on behalf of GANSW)	Presentation on UDLP	Closed
	18/04/2019	DP&E (on behalf of GANSW)	Email updated UDLP and UDLP sub plans	Closed
	31/03/2020	DPE (on behalf of GANSW)	Updated UDLP provided to DPE as a result of amendments to the design of OSD 9 and resulting revisions to landscape design	Closed
	5/06/2020	DPE (on behalf of GANSW)	DPE – approval of updated Area 1 UDLP, excluding SSD 7628 CoC B140(e)(vi)	Closed
	20/08/2020	DPE (on behalf of GANSW)	Show Cause letter received by Qube regarding compliance with SSD 7628 CoC B140(e)(vi) for Area 1	Closed

SIMTA =

Agency	Date	Person Contacted	Comment	Status
	8/09/2020	DPE (on behalf of GANSW)	Aspect lodged SSD 7628 MOD 4 application with DPE regarding Area 1 exception to CoC B140(e)(vi) – car parking landscaping	Waiting response from DPE/GANSW
	28/10/2020	DPE (on behalf of GANSW)	Teams meeting with DPE to discuss SSD 7628 MOD 4 application	Closed
	AREA 2			
	6/08/2018	DPE (on behalf of GANSW)	Meeting with DPE, Aspect Environmental, Arcadis and Tactical Group to discuss issues to progress MPE UDLP	Closed
	27/02/2020	DPE (on behalf of GANSW)	Meeting between DPE and Aspect Environmental to update UDLP progress	Closed
	14/05/2020	DPE (on behalf of GANSW)	UDLP documentation for Area 2 provided to DPE (on behalf of GANSW)	Closed
	19/06/2020	DPE (on behalf of GANSW)	DPE sent RFI providing GANSW/DPE comments for LVMSP and LSP for Area 2.	Closed
	25/06/2020	DPE (on behalf of GANSW)	DPE sent RFI providing GANSW/DPE comments for SSP for Area 2.	Closed
	7/07/2020	DPE (on behalf of GANSW)	Email requesting an update on provision of remainder of comments; advised by DPE that comments forthcoming	Closed
	9/07/2020	DPE (on behalf of GANSW)	DPE sent RFI providing GANSW/DPE comments for UDLP, CPAFSP and EOMBASP for Area 2.	Closed
	31/07/2020	DPE (on behalf of GANSW)	UDLP documentation for Area 2 updated and/or response provided to address DPE/GANSW comments	Closed
	3/08/2020	DPE (on behalf of GANSW)	Follow up phone call to confirm receipt of updated UDLP documentation	Closed
	3/08/2020	DPE (on behalf of GANSW)	Additional access to UDLP documentation requested by DPE and provided by Aspect, for DPE staff	Closed
	12/08/2020	DPE (on behalf of GANSW)	UDLP, EOMBA and CPAFSP documentation for Area 2 updated and response provided to address DPE/GANSW comments	Closed
	4/09/2020	DPE (on behalf of GANSW)	DPE – approval of updated Area 1 and Area 2 UDLP, excluding SSD 7628 CoC B140(e)(vi) for Area 1	Closed

SIMTA =

Agency	Date	Person Contacted	Comment	Status	
	CONSOLIDATED (including AREAS 3 to 6)				
	26/06/2020	DPE (on behalf of GANSW)	Consolidated UDLP documentation for MPE Site provided DPE (on behalf of GANSW)	Waiting response from DPE/GANSW	
	30/06/2020	DPE (on behalf of GANSW)	DPE confirmed by email that Consolidated UDLP documentation received for consultation and comment	Closed	
	7/07/2020	DPE (on behalf of GANSW)	As requested by DPE, link to documentation sent to GANSW independent reviewer	Closed	
	8/07/2020	DPE (on behalf of GANSW)	Follow up phone call and briefing with GANSW independent reviewer	Closed	
	8/10/2020	DPE (on behalf of GANSW)	Phone call and email requesting an update on progress of review; DPE advised review process underway	Closed	
	21/10/2020	DPE (on behalf of GANSW)	Phone call and email requesting an update on progress of review	Closed	
	21/10/2020	DPE (on behalf of GANSW)	Comments regarding Consolidated UDLP documentation provided by DPE/GANSW	Closed	
	4/11/2020	DPE (on behalf of GANSW)	Updated Consolidated UDLP documentation provided to DPE/GANSW for assessment	Closed	
	5/02/2021	DPE (on behalf of GANSW)	Consolidated UDLP approved	Closed	
	13/10/2022 (TBC)	DPE (on behalf of GANSW)	Consolidated UDLP, amended for the revised layout of Area 3, provided to DPE (on behalf of GANSW) for information	Waiting DPE response	



2 DESIGN OF CYCLING AND PEDESTRIAN ACCESS AND FACILITIES

This CPAFSP provides details for the provision of safe and efficient pedestrian and cyclist access connectivity throughout the site. This CPAFSP also provides details of end of trip facilities available including bicycle storage, toilets, showers and change facilities sufficient to accommodate the needs of the forecast number of employees.

2.1 Construction, Timing and Responsibility

On-site facilities such as bicycle storage and end of trip facilities will be provided for each warehouse and within the freight village prior to the warehouse/freight village being considered operational, thereby ensuring that these facilitates are available upon occupation. The undercover bicycle storage and end of trip facilities will be available at the time of the issue of an occupation certificate. A warehouse would not be considered operational until shared path (cycle way and pedestrian) access have been provided.

Typical undercover bicycle storage and end of trip facilities to be provided across the MPE Site are provided in Appendix 3.

The relevant Construction Contractor will be responsible for the construction of the designed access and facilities. The design of the access was undertaken by the Principal Representative's designers in liaison with the Principal's Representative and authors of this plan.

2.2 Cycle Access and Connectivity

Despite there being no existing cycleway along Moorebank Avenue, on-street cycling is accommodated within lane-marked shoulders of 1.5 to 2.5 m width. In addition, Moorebank Avenue connects to a series of cycle routes in the surrounding area, as shown in Figure 2-1, in the form of either on-street cycle lanes, shared pedestrian-cycle paths or along local roads.

A cycle route from the Project Site to Holsworthy train station is possible, for example, via a connection of shared paths and local streets in the Wattle Grove residential area (cycling distance of approximately 5.6 km).





Cycling and Pedestrian Access and Facilities Plan

Figure 2-1 Local Public Transport and Pedestrian / Cycleway Network


A number of publications also exist that outline plans to improve the region's cycle-connectivity, including:

The NSW Bike Plan (June 2010) has identified bike routes to be constructed around Liverpool on • Moorebank Avenue, Heathcote Road and Newbridge Road.



(NSW Bike Plan, 2010).

Sydney's Cycling Future (Transport for NSW, 2013) commits to completing missing links in the existing bicycle network to the Liverpool CBD. This would include improving bicycle access to the Liverpool city centre from the south by completing the missing sections of the off-road walking and cycling corridor along Glenfield Creek, between Casula and Liverpool. This improved access would integrate with the cycling routes proposed in the Liverpool Bike Plan (Liverpool Council, 2009). Moorebank Avenue is also considered a strategic bicycle corridor (Figure 2-3).

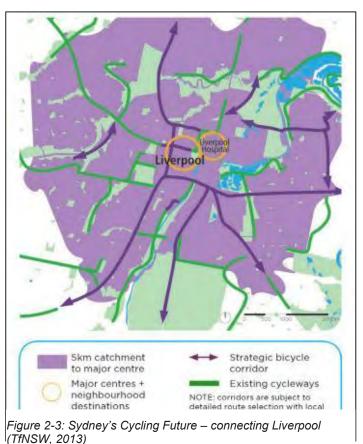



The shared path extends along the northern boundary of the MPE Site, north of the freight village and north of the carpark of Warehouse 2, then continues south along the eastern boundary of the MPE Site. This shared pathway is situated on the east side of the multi-tenant user road and extends along the internal roads between Warehouses 1 and 2, Warehouses 3 and 4, and Warehouses 6 and 7. Internal shared pathways are outlined in Appendix 0A of the UDLP.

2.2.1 Area 1

Cyclists will be able to access Warehouse 1 through the provision of shared paths from Moorebank Avenue on the northern boundary of the freight village. This shared path will provide direct access to the bicycle parking facilities located on the north-east section of Warehouse 1. This shared path runs through the garden beds consisting of canopy trees such as *Acacia sp., Corymbia sp., Eucalyptus sp. and Melaleuca sp.* with low level native planting e.g. *Callistemon sp., Crowea sp., Dianella sp. and Myoporum sp..*

Access from the eastern boundary road will be from either the shared path to the north of Area 5 (Warehouse 2), or via the internal road network to the south and west of Area 5 (Warehouse 2).

Figure 2-4 and Appendix 1 provide details on the shared paths located throughout Area 1. The shared path will provide a dedicated safe cycling route into Area 1 from the north, Moorebank Avenue and the site's eastern boundary, and will allow connectivity throughout the entire MPE Stage 2 Site. Appendix 0A of the UDLP demonstrates the shared paths for the entire MPE Stage 2 Site.



Figure 2-4: Potential cycling routes to bicycle parking facilities at Warehouse 1 (Ground Ink, 2020).



2.2.2 Area 2, Area 3, Area 4 and Area 5

Cyclists will be able to access warehouses through the provision of shared paths along the internal roads as outlined below (refer to Figure 2-5).

2.2.2.1 Warehouse 3 and Warehouse 6

To access the bicycle parking facilities for Warehouse 3 (Area 2), cyclists will be required to cross at the pedestrian crossing to Warehouse 3 where the shared path continues to the bicycle parking facilities located at Office 3B (Appendix 2).Similar to Warehouse 3, Warehouse 6 cyclists will cross at the pedestrian crossing to Warehouse 6 and bicycle parking facilities.

Typical bicycle parking facilities design is provided in Appendix 3.

2.2.2.2 Warehouse 4 and Warehouse 7

To access the bicycle parking facilities for Warehouse 4 (Area 2); cyclists will be required to cross at the pedestrian crossing to Warehouse 4 and continue west along the shared path along the internal access road between Warehouses 3 and 4 to the bicycle parking facilities located at Warehouse 4 (Appendix 2). Similar to Warehouse 4, Warehouse 7 cyclists will cross at the pedestrian crossing to Warehouse 7 and continue west along the shared path along the internal access road between Warehouse 6 and 7.

Typical bicycle parking facilities design is provided in Appendix 3.

2.2.2.3 Warehouse 5

To access the bicycle parking facilities for Warehouse 5 (Area 2), cyclists will travel west along the shared path from Warehouse 4 on the internal access road. Once within the Warehouse 5 precinct, cyclists must travel along the pedestrian pathways to access the bicycle parking facilities located adjacent to each office (Appendix 2).

2.2.2.4 Freight Village

A shared path located near the northern boundary of Area 1 will provide direct access to the indicative undercover bicycle parking facilities located within the central area of the freight village (Area 4). Details for bicycle parking and end of trip facilities for Area 4 are subject to detailed design and tenanting requirements. Facilities will be consistent with Area 1 and Area 2 and the requirements of this subplan. Typical bicycle parking and end of trip facilities are provided in Appendix 3.


2.2.2.5 Warehouse 2

To access the bicycle parking facilities for Warehouse 2 (Area 5), cyclists will utilise the shared path along the northern boundary of the MPE Site and running south between Area 1 and Area 5 (see UDLP Appendix 0A).

Details for bicycle parking and end of trip facilities for Area 5 are subject to the detailed design and tenanting requirements of Warehouse 2. Facilities will be consistent with Area 1 and Area 2 and the requirements of this subplan. Typical bicycle parking and end of trip facilities are provided in Appendix 3.

2.2.3 Area 6

No dedicated cycle access is to be provided along Moorebank Avenue. A shared pathway has been provided, as shown in the plans provided in the UDLP (Appendix 0A and Appendix 6). On-street cycling will continue to be accommodated within lane-marked shoulders of 1.5 to 2.5 m width. No dedicated bicycle parking will be provided within this Area.

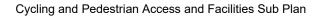

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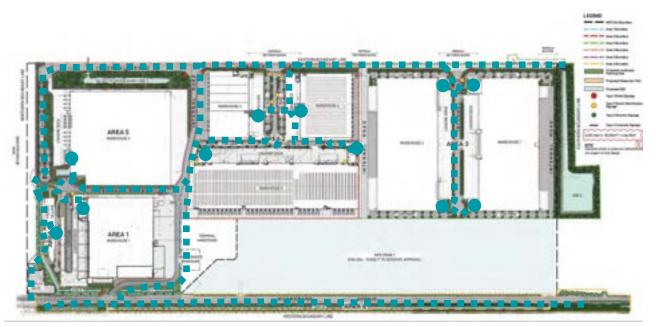


Figure 2-5: Potential cycling routes within the Precinct, and to bicycle parking facilities at Areas 2, 3, 4 and 5 (Ground Ink, 2022).

2.3 Pedestrian Access and Connectivity

As shown in Figure 2-6, the MPE Site is in close proximity to several train stations (Glenfield, Holsworthy and Casula Stations).

Although pedestrian access is available to the Site from each of these train stations, the distance to travel is not practical. It is more likely that pedestrians accessing the Site from a train station would first utilise local bus services to get closer. Direct bus services to stops along Moorebank Avenue (shown on Figure 2-6 in red) are available from Holsworthy Station via Route 901 during the AM and PM peaks. Indirect bus services via other train stations and nearby city centres (such as Glenfield and Liverpool) are also available. Pedestrian access to the MPE Site from Moorebank Avenue is then available in a number of locations, as discussed below.

Pedestrian access will be via the off-road shared path from Moorebank Avenue, adjacent to the Defence Joint Logistics Unit (DJLU) intersection. Several signalised T-intersections spaced approximately 250 m to 600 m apart featuring signalised pedestrian crossings on Moorebank Avenue provide safe crossing access to the Project Site as shown in Figure 2-7.

Sightlines along Moorebank Avenue are generally clear, providing motorists suitable opportunity to see pedestrians. Overall pedestrian connectivity is considered good for the area, given the relatively low pedestrian volumes.

Pedestrians will access the MPE Site through the shared path extending along the northern boundary of the MPE Site, north of the freight village and north of the carpark of Warehouse 2. The shared path continues south along the eastern boundary of the MPE Site. This shared pathway is situated on the east side of the multi-tenant user road and extends along the internal roads between Warehouse 1 and 2, Warehouse 3 and 4, and Warehouse 6 and 7.

Internal shared pathways are outlined in Appendix 0A of the UDLP. In addition to showing potential cycling routes within the Precinct, the nominated routes on Figure 2-5 also indicate shared paths as pedestrian access pathways within the Precinct.

SIMTA ≣



Figure 2-6: Locations of Existing Train Stations in close proximity to MPE and bus stops along Moorebank Avenue.

2.3.1 Area 1

Pedestrians will be able to access Warehouse 1 through the provision of shared paths from Moorebank Avenue. A shared path provides access to Warehouse 1 and is located on the northern boundary of the freight village. This shared path will provide direct access to the site office located on the north-east section of Warehouse 1. This shared path runs through the garden beds consisting of canopy trees such as *Acacia sp., Corymbia sp., Eucalyptus sp. and Melaleuca sp.* with low level native planting e.g. *Callistemon sp., Crowea sp., Dianella sp. and Myoporum sp.* Landscaping in this area is to include potential seating benches located adjacent to the shared path way providing opportunities for staff meal breaks. Appendix 1 (Area 1 Masterplan) demonstrates the shared path throughout Area 1.

The pedestrian crossing at Moorebank Avenue and DJLU Access provides safe and direct pedestrian access to Area 1. This crossing links to the off-road shared path located on the northern border of Area 1 which connects directly to the eastern section of Area 1 where the office is located. Appendix 1 shows the shared path location through to Area 1.

2.3.2 Area 2 and Area 3

Pedestrians will be able to access Warehouses 3 to 7 via the shared paths along the internal road network. As discussed in Section 2.2.2, from the eastern boundary, the shared path continues west along the internal road between Warehouses 3 and 4, providing direct access for pedestrians into the warehouse offices and ultimately to Warehouse 5. Pedestrian crossings are provided to enable safe crossing points for pedestrians where required. Similarly, pedestrian access to Warehouses 6 and 7 from the eastern boundary will be from the shared path along the internal road between the two warehouses.

Appendix 2 and Appendix 3 provide details on the pedestrian paths through Area 2 and Area 3 respectively. Appendix 0A of the UDLP demonstrates the shared paths and pedestrian paths for the entire MPE Site.



2.3.3 Area 4

Pedestrians will be able to access the freight village via the shared paths running north along the northern boundary of Area 1. Pedestrian crossings will be provided within Area 4 to enable safe crossing points for pedestrians where required.

Further details regarding pedestrian shared pathways for Area 4 are subject to detailed design and tenanting requirements. Shared pathway elements will be consistent with Area 1 and Area 2 and the requirements of this subplan.

Appendix 3 provides details on the pedestrian paths through Area 2. Appendix 0A of the UDLP demonstrates the shared paths and pedestrian paths for the entire MPE Site.

2.3.4 Area 5

Pedestrian access will be designed to provide access to Warehouse 2 via shared paths along the internal road network. Direct access for pedestrians will be provided into the warehouse office and ultimately to warehouses, utilising pedestrian crossings to enable safe crossing points for pedestrians where required.

Final design of shared path and pedestrian paths for Area 5 is subject to detailed design and tenanting requirements. At the development application stage, pedestrian access is to be confirmed, and designed to be consistent with the requirements of this subplan.

Appendix 5 provides details on the pedestrian paths through Area 5. Appendix 0A of the UDLP demonstrates the shared paths and pedestrian paths for the entire MPE Site.

2.3.5 Area 6

Sightlines along Moorebank Avenue are generally clear, providing motorists suitable opportunity to see pedestrians. As discussed in Section 2.3, several signalised T-intersections featuring signalised pedestrian crossings on Moorebank Avenue will provide safe crossing access to the MPE Site and Warehouses (Figure 2-7). A shared path is to be provided along Moorebank Avenue for pedestrian and cyclist access. The path will be appropriately signposted with pedestrian crossings where required.

Appendix 3 provides details on the shared paths through Area 6. Detailed design of Area 6 may be subject to a separate approval from Transport for NSW (TfNSW).



Cycling and Pedestrian Access and Facilities Plan



Figure 2-7 Locations of existing pedestrian crossing facilities on Moorebank Avenue



2.4 End of Trip Facilities

The City of Sydney Section 3 – General Provisions stipulates the following on-site bicycle parking rates for Industry or Warehouse/Distribution Centres:

- one bicycle rack per 10 staff/employees
- one personal locker for each bike parking space
- one shower and change cubicle for up to 10 bicycle parking spaces
- two showers and change cubicles for 11 to 20 or more bicycle parking spaces are provided
- two additional showers and cubicles for each additional 20 bicycle parking spaces or part thereof.

End of trip facilities across the MPW Site are to be designed in accordance with the above.

The bicycle parking facilities will be designed to satisfy the minimum standard requirements of AS 2890.3 – 1993 Parking Facilities Part 3: Bicycle Parking Facilities including quantity, functionality, convenience and security.

2.4.1 Area 1

2.4.1.1 Bicycle Facilities

Staff numbers are approximately 100 people per day over a 10 hour shift for Warehouse 1. The proposed staff numbers have been supplied by the warehouse tenant. In accordance with The City of Sydney Section 3 -General Provisions, a total of 10 bicycle parking spaces, 10 lockers and 1 shower/change cubicle will be included for the 100 staff employees at Warehouse 1.

The secure bicycle facilities are located immediately north of the smoker's designated area located north of the entrance of Warehouse 1 and are undercover as shown in Figure 2-8; design details are presented in Appendix 1.



Figure 2-8 Undercover Bicycle Facilities for Warehouse 1



2.4.1.2 End of Trip Amenities

The female and male amenities for Warehouse 1 are sufficient to accommodate the needs of the estimated 100 people per day over a 10 hour shift for Warehouse 1. In addition to the male and female facilities, an accessible toilet and shower will also be provided. The male and female amenities are located near the entrance of the Warehouse 1 office. An indicative drawing of the end of trip facilities for Warehouse 1 is shown in Appendix 1.

Warehouse 1 will provide the following female amenities:

- 5 toilets (including one ambulant)
- 20 x 3 tier lockers
- 3 sinks
- 2 showers.

Warehouse 1 will provide the following male amenities:

- 6 toilets (including one ambulant)
- 4 urinals
- 35 x 3 tier lockers
- 5 sinks
- 3 showers.

2.4.2 Area 2

2.4.2.1 Bicycle Facilities

Warehouse 3

Staff numbers are approximately 83, and this is split between the two warehouse tenants: Tenant A will have approximately 54 staff and Tenant B will have approximately 29 staff. In accordance with The City of Sydney Section 3 – General Provisions, a total of 11 bicycle parking spaces, two showers and eight lockers will be provided for the 83 employees at Warehouse 3.

The secure bicycle facilities are located adjacent to Office B and are undercover as shown in Figure 2-9.



Figure 2-9 Typical Undercover Bicycle Facilities for Warehouse 3



Warehouse 4

Staff numbers are approximately 75, and this is split between the two warehouse tenants: approximately 36 staff will be working for Tenant A and approximately 39 staff will be working for Tenant B. In accordance with The City of Sydney Section 3 – General Provisions, a total of nine bicycle parking spaces, two showers and seven lockers will be provided for the 75 employees at Warehouse 4.

The secure bicycle facilities are located adjacent to office B and are undercover as shown in Figure 2-10.



Figure 2-10 Typical Undercover Bicycle Facilities for Warehouse 4

Warehouse 5

Staff numbers are approximately 285, and this is split between the two warehouse tenants: Tenant A will have approximately 152 staff and Tenant B will have approximately 133 staff. In accordance with The City of Sydney Section 3 – General Provisions, a total of 26 bicycle parking spaces, 12 showers and 52 lockers split evenly between the two tenants will be provided for the 285 employees at Warehouse 5.

The secure bicycle facilities are located adjacent to the two site offices and are undercover as shown in Figure 2-11. Design details of the undercover bicycle parking areas are provided in Appendix 2 (Drawing No. WHP5-RCG-AR-DWG-UDLP8-B).



Figure 2-11 Typical Undercover Bicycle Facilities for Warehouse 5



2.4.2.2 End of Trip Amenities

Warehouse 3

The end of trip facilities for Warehouse 3 are sufficient to accommodate the needs of the expected bicycle users.

The male and female amenities for Warehouse 3 are sufficient to accommodate the needs of the approximate 83 staff for Warehouse 3. In addition, to the male and female toilets, two accessible toilets and one accessible shower will be provided. The male and female end of trip facilities are located within the two offices of Warehouse 3. Architectural drawings of the end of trip facilities for Warehouse 3 are shown in Appendix 2.

Warehouse 3 will provide the following female amenities:

- 9 toilets
- 12 lockers
- 9 sinks
- 4 showers.

Warehouse 3 will provide the following male amenities

- 8 toilets
- 7 urinals
- 12 lockers
- 8 sinks
- 4 showers.

Warehouse 4

The male and female amenities for Warehouse 4 are sufficient to accommodate the needs of the approximate 75 staff for Warehouse 4. In addition, to the male and female toilets, two accessible toilets and one accessible shower will be provided. The male and female end of trip facilities are located within the two offices of Warehouse 4. An indicative architectural drawing of the end of trip facilities for Warehouse 4 is shown in Appendix 2.

Warehouse 4 will provide the following female amenities:

- 10 toilets
- 12 lockers
- 8 sinks
- 6 showers.

Warehouse 4 will provide the following male amenities

- 8 toilets
- 6 urinals
- 11 lockers
- 8 sinks
- 6 showers.



Warehouse 5

The male and female amenities for Warehouse 5 are sufficient to accommodate the needs of the approximate 285 staff for Warehouse 5. In addition to the male and female facilities, 10 accessible toilets will be provided. The male and female amenities are located near the two offices of Warehouse 5. Architectural drawings for the end of trip facilities of Warehouse 5 are shown in Appendix 2.

Warehouse 5 will provide the following female amenities:

- 12 toilets
- 26 lockers
- 12 sinks
- 6 showers.

Warehouse 5 will provide the following male amenities:

- 14 toilets
- 14 urinals
- 26 lockers
- 16 sinks
- 6 showers.

2.4.3 Area 3

2.4.3.1 Bicycle Facilities

Bicycle parking spaces have been provided for Warehouses 6 and 7 based on anticipated staff numbers (to be confirmed) and the City of Sydney Section 3 – General Provisions. A total of 28 bicycle parking spaces have been provided for each warehouse. The secure undercover bicycle facilities, as shown in Figure 2-12, will be located adjacent to both of the office areas, for each warehouse. Detailed designs are provided in Appendix 3.



Figure 2-12: Typical bicycle parking facilities for Warehouses 6 and 7 (Watson Young, 2022)

2.4.3.2 End of Trip Amenities

The end of trip amenities for Warehouses 6 and 7 are sufficient to accommodate the needs of the estimated staff numbers. The male and female amenities are located near each of the office and dock areas of Warehouse 6 and of Warehouse 7. Sixteen accessible toilets and 2 accessible showers will be provided within Warehouse 6 and 12 accessible toilets and 2 accessible showers within Warehouse 7. Architectural drawings for the office layout and end of trip facilities for Warehouses 6 and 7 are provided in Appendix 3.

Warehouse 6 will provide the following female amenities:

16 toilets

Cycling and Pedestrian Access and Facilities Sub Plan



- 58 lockers
- 10 sinks
- 4 showers.

Warehouse 6 will provide the following male amenities:

- 10 toilets
- 10 urinals
- 58 lockers
- 10 sinks
- 4 showers.

Warehouse 7 will provide the following female amenities:

- 13 toilets
- 40 lockers
- 8 sinks
- 4 showers.

Warehouse 7 will provide the following male amenities:

- 11 toilets
- 8 urinals
- 64 lockers
- 11 sinks
- 6 showers.

2.4.4 Area 4 and Area 5

2.4.4.1 Bicycle Facilities

Staff numbers are currently not confirmed for these Areas of the MPE Site. Nevertheless, and consistent with Section 2.4.1 and 2.4.2, bicycle parking spaces, shower facilities and lockers shall be provided based on anticipated staff numbers and in accordance with The City of Sydney Section 3 – General Provisions. This shall be confirmed at the development application stage for each Area.

Secure bicycle facilities shall be located adjacent to warehouse offices within Area 5. They shall be undercover and will be designed to be consistent with those in Area 1 and Area 2 (see Figure 2.8 - 2.11 and Appendix OC) and the requirements of this subplan. Indicative undercover bicycle facilities are located near the central forecourt area of the freight village.

Typical bicycle facilities design for the MPE Site is provided in Appendix 0C.

2.4.4.2 Male and Female Amenities

The end of trip facilities for Areas 4 and 5 shall be sufficient to accommodate the needs of the expected bicycle users, once these details become available.

The male and female amenities shall be sufficient to accommodate the needs of the anticipated staff and visitor population. In addition to the male and female toilets, accessible toilets and accessible shower facilities will be provided.

The male and female end of trip facilities will be located within the warehouse offices in Area 5, and indicative amenities are located near the central forecourt area of the freight village. Typical drawings of end of trip facilities in Areas 4 and 5 are provided in Appendix 0C.

Cycling and Pedestrian Access and Facilities Sub Plan



2.4.5 Area 6

End of trip facilities and amenities are not required for Area 6.



2.5 Compliance with AS 2890.3 – 1993

The layout, design and security of bicycle facilities across the MPE Site will align with the minimum requirements of *Australian Standard AS 20890.3-1997 Parking Facilities Part 3: Bicycle Parking Facilities.* The bicycle parking facilities will meet the following minimum requirements:

- Safety the bicycle parking will allow a bicycle frame and wheels to be locked using cyclists own locking device
- Space per bicycle a minimum "bicycle spacing envelope" of 1800 mm x 1200 mm x 500 mm will be provided
- Aisle access a minimum of 1500 mm passageway free of obstacles will be provided
- Sturdy construction the bicycle parking will have sufficient support, be resistant to cutting, bending and breaking and include tamper resistant fixings.

AS 20890.3-1997 was updated in 2015 and the end of trip facilities have been designed to meet the relevant updated standard. Separate certificates have been provided to the Property Council of Australia (PCA) for the construction certificate for Warehouse 1 (Area 1) and for Warehouses 3, 4 and 5 (Area 2).

Similarly, required certificates will be provided to the PCA for Areas 3 to 5 prior construction of warehouses in these areas. This is not required for Area 6.



Appendix 0A – Evidence Of Consultation



Qube Property Development Management Services Level 27, 45 Clarence Street Sydney NSW 2000

05/02/2021

Dear

Moorebank Precinct East Stage 2 (SSD 7628) Urban Design and Landscape Plan

I refer to your submission dated 4 November 2020 requesting approval of the consolidated Urban Design and Landscape Plan (UDLP), Revision 12, dated 18 December 2020, and associated Sub Plans required under condition B140 of SSI 7628. This plan has been staged with the approval of the Planning Secretary under condition A14 and A15 SSD 7628.

I acknowledge your response to the Department's review comments and requests for additional information. I note that these plans:

- have been reviewed by SMITA and no issues have been raised;
- have been prepared in consultation with Liverpool City Council; and
- have been reviewed by the Government Architect NSW.

I understand that the drawings accompanying the consolidated UDLP for the stages known as Areas 3 to 6 are indicative only and are subject to final detailed design. The consolidated UDLP and drawings for Areas 1 and 2 reflect the approved permanent built surface works and landscaping for these areas only.

I note that Liverpool City Council, and Government Architect NSW have been consulted on the indicative designs for Areas 3 to 6, and have provided comment, noting that these plans will need to be updated as the development of the site progresses. Further, I note your commitments to update the UDLP drawings and Sub Plans following detailed design.

Further, the consolidated UDLP and Sub Plans have satisfactorily demonstrated how Ecological Sustainable Development and Stormwater Management requirements have been incorporated into the overall design for MPE Stage 2, meeting the requirements for condition B140 (I) and (n).

I note that the UDLP has detailed how recommendations from the Heritage Interpretation Plan, required under condition B101, will be incorporated into the detailed design of the stage known as Area 4.

As nominee of the Planning Secretary, I approve the following documents under Condition B140 of SSD 7628 subject to you updating and resubmitting the UDLP and Sub-Plans for information with the detailed design for each future stage (Areas 3, 4, 5 and 6):

Document	Revision and date
Consolidated Urban Design and Landscape Plan	Rev 12, dated 18 December 2020
Cycling and Pedestrian Access and Facilities Sub Plan	Rev 7, dated 3 November 2020
Landscape Vegetation Management Sub Plan	Rev 8, dated 3 November 2020
Lighting Sub Plan	Rev 8, dated 3 November 2020
Employee Outdoor Meal Break Area Sub Plan	Rev 7, dated 3 November 2020
Signage Sub Plan	Rev 7, dated 3 November 2020

You must resubmit the updated UDLP and Sub-Plans, reflecting detailed design for each future stage, prior to commencement of permanent built surface works and/or landscaping for each stage, or as otherwise agreed by the Planning Secretary. The Department may request that you seek the Planning Secretary's approval of the UDLP and relevant sub-plans following detailed design for each stage if the 'for information' submission does not meet the requirements of the conditions of consent.

Further, I refer to the Planning Secretary nominee's letters dated 24 April 2020 and 4 September 2020 regarding the conditional approval for the MPE Stage 1 UDLP. These letters refer to the requirement for additional compensatory landscaping on MPE Stage 2. I note that the consolidated UDLP for MPE Stage 2 commits to delivering a minimum 14.2% of soft landscaping on the MPE Stage 2 site. When you have confirmed this following detailed design then the conditional approval of the UDLP for MPE Stage 1 will be resolved.

Please note, if there are any inconsistencies between the approved documents and the conditions of consent, then the requirements of the conditions of consent prevail.


Please ensure that the approved plans and drawing are placed on the project website at the earliest convenience.

further,

please

contact

matter

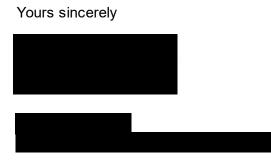

discuss

the

If you wish to

As nominee of the Planning Secretary



Qube Property Development Management Services Level 27, 45 Clarence Street Sydney NSW 2000

04/09/2020

Dear

Moorebank Precinct East – Stage 2 (condition B140, SSI 7628) Urban Design and Landscape Plan

I refer to your submission dated 14 May 2020 requesting approval of the Urban Design and Landscape Plan (UDLP), Rev 9B dated 12 August 2020, and Sub Plans for Area 1 and Area 2 only in accordance with condition B140 of SSI 7628. I also acknowledge your response to the Department's review comments and requests for additional information. I note that these plans have been staged under condition A14 of SSD 7628.

The UDLP for Area 1 and Area 2 and associated Sub Plans have been reviewed and I note that these plans:

- have been reviewed by SIMTA and no issues have been raised
- have been prepared in consultation with Liverpool City Council
- have been reviewed by the Government Architect of NSW.

As nominee of the Planning Secretary, I approve the following documents under condition B140 and B141 for Area 1 and Area 2 only:

Document	Revision
Urban Design and Landscape Plan	Rev 9C, dated 12 August 2020
Landscape and Vegetation Management Sub Plan	Rev 6C, dated 31 July 2020
Lighting Sub Plan	Rev 6C, dated 31 July 2020
Cycling and Pedestrian Access and Facilities Sub Plan	Rev 5C, dated 12 August 2020
Employee Outdoor Meal Break Area Sub Plan	Rev 5C, dated 12 August 2020
Signage Sub Plan	Rev 5C, dated 31 July 2020

Please note that this approval does not extend to condition B140 (e)(vi) for Area 1, as this matter is still outstanding and has been referred to DPIE Compliance for review. I note that Area 2 meets the requirements of condition B140 (e)(vi).

I also note that the approved development layout plan has been amended (Reference: SSS2-RCG-AR-SKC-159, dated 11-08-2020). I approve the amended development layout under condition A22. I remind you that you must seek approval for any future changes made to the development layout of the site under condition A22.

You are also reminded that in my letter dated 24 April 2020, I approved the UDLP for MPE Stage 1 subject to you providing additional compensatory landscaping on MPE Stage 2. You must detail how this will be achieved in future stages of the MPE Stage 2 UDLP.

Further, in the subsequent consolidated UDLP and Sub Plans for the MPE Stage 2 site, you must satisfy all the requirements of condition B140 for the site overall, and must demonstrate that requirements not achieved in Areas 1 and 2 have been achieved overall. A copy of the review table containing outstanding matters will be provided to you for your reference.

Please note, if there are any inconsistencies between the approved documents and the conditions of consent, then the requirements of the conditions of consent prevail.

Please ensure that the approved plan is placed on the project website at the earliest convenience. If you wish to discuss the matter further, please contact

Yours sincerely





As nominee of the Planning Secretary

From:	
Subject: Date: Attachments:	RE: Thursday, 13 August 2020 12:08:00 PM

Hi

Thank you for confirming. Please let me know if you need any further information.

Kind regards,





Suite 117, 25 Solent Circuit Baulkham Hills NSW 2153

www.aspectenvironmental.com.au

in

From:

Sent: Thursday, 13 August 2020 12:06 PM

To: Subject:

Hi

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Planning and Assessment | Department of Planning, Industry and Environment **T** 02 8275 1168 | 4 Parramatta Square, 12 Darcy Street, Parramatta NSW 2150

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From:		
Sent:	Wednesday, 12 August 2020 7:	42
To		

Subject:

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Report to Dropbox

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DPE review comments - Condition B141 (d) UDLP Cycling and Pedestrian Access and Facilities Sub Plan (CPAFSP)

ROW	Condition No.	Section	DPE Comment Rev 2 dated 8/8/18	Proponent Response DPE comment (Rev 3, dated 18/04/2019)	DPIE Comment Rev 5B dated 08/05/20	Proponent Response 11/08/20
1	A14 With the approval of the Secretary, the Applicant may submit any strategy, plan or program required by this consent on a staged basis.	Section 1.3	The Cycling and Pedestrian Access and Facility (CPASFSB) Warehouse 1 Precinct (W1P) has been submitted on a staged basis (excluding the built surface works for the freight village). Satisfactory, noting comments listed under A15.	 This plan has been updated in Section 1.3 to include the different stages associated with this plan. The stages of this plan include: Area 1 – Warehouse 1 including area north of freight village Area 2 – Warehouse 3, 4 and 5 Area 3 – Warehouse 6, 7 and 8 Area 4 – Freight village Area 5 – Warehouse 2 Area 6 – Moorebank Avenue Works Section 1.3.2 outlines the following: "Area 1 is the first stage of this EOMBASP and includes Warehouse 1 and the immediate area surrounding Warehouse 1 (excluding the freight village). The detailed plans for future stages, i.e. Areas 2 - 6, of this EOMASP are anticipated to be provided in multiple submissions as described in Table 1. Each future staged submission will be incremental and present the detailed present the cycling and pedestrian connectivity requirements for that stage." Reference to W1P has also been removed throughout the entire document.	Section 1.3 states that this CPAFSP will be staged (in accordance with CoC A14 and A15) to allow for the commencement of warehouse construction, is shown on Figure 1-1 and detailed within Table 1. Table 1 states operational dates as follows: Area 1 (WH1 including area north of the freight village)– Q2 2019 Area 2 (WH3, WH4 & WH5) – Q2 2020 Areas 3-6 (WH2, WH6, WH7, WH8, freight village & upgrade Moorebank Ave) – TBC ROW 1 DPIE: Please update Table 1 to include the following columns; area/warehouses, stage submission date, targeted occupancy date and perhaps build duration. This will enable applicant/DPIE to anticipate when the stages of plan will be submitted and when construction will need to commence.	 Table 1 has been updated to be consistent with other subplan updates and provide: Area Approx date of plan submission Operational area (warehouses) Approximate occupation date (where known) Build duration cannot be forecasted and is dependent on market demands, tenant needs and other approvals. The CPAFSP does require, however that submission of the subplan is required prior to permanent built surface works and/or landscaping of the next area. Implementation is required prior to occupation.

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				As outlined in Section 1.3.3, the trigger for updating this plan will be submitted one month prior to permanent built surface works and/or landscaping of the next stage. Satisfactory.		
2	A15 If the submission of any strategy, plan or program is to be staged, then the relevant strategy, plan or program must clearly describe the specific stage of the development to which the strategy, plan or program applies, the relationship of the stage to any future stages and the trigger for updating the strategy, plan or program	Section 1.3	The specific stage of the plan is the Warehouse 1 and the area inside W1P (excluding the freight village). The trigger for updating the CPAFSB is prior to the installation of cycling and pedestrian facilities and access arrangements for the freight village. The trigger for submission of the second stage (CPAFSP – Remainder of Site) will be prior to the commencement of permanent built surface works for the remainder of site. Works will only progress beyond bulk earthworks for the remainder of the site upon approval of the CPAFSP – Remainder of Site. Further action required. 1. Please ensure that the trigger for updating the CPAFSB is	 Section 1.3 has been updated to include the different stages applicable to this plan, as described above. Figure 1-1 has been included in this plan and includes the different stages in relation to the whole of site. Satisfactory. 	ROW 2 Comment: Please refer to ROW 1 comments. Please also update the triggers in section 1.3.1 to reflect the following; The staging strategy is shown in Table 1. Future stages of the CPAFSP will be submitted to the department with adequate time for assessment and approval. Construction of each stage will only commence once approval of stage has been obtained from the department. Triggers for updating the strategy will occur if delivery program significantly changes. 2	Noted – updates made to Table 1 Triggers are detailed in Section 1.3.3 This Section has been updated to reflect this comment. The CPAFSP has been clarified to reflect that approval from DPIE for staging of development activities has already been granted as a separate process aside from this plan. Construction of each development stage will only commence once approval of stage has been obtained from the department. The trigger for submission of the future stages of this CPAFSP will be one month prior to permanent built surface works and / or landscaping of the next area.

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			consistent with the overarching UDLP i.e. prior to the commencement of built surface works for the freight village.			
3	B140 The UDLP must be prepared by a suitably qualified and experienced person(s), in consultation with the relevant council(s). The UDLP must be approved by the Secretary, in consultation with the NSW Government Architect.		The UDLP Appendix A states that the plan was submitted to Liverpool City Council on 14/8/2018, with comments received back on 3 October 2018. The Sub-plan was submitted (along with the overarching UDLP) to the Department for the Government Architect's consultation on 31/08/2018, prior to Liverpool City Council's comments being received. Consultation with the Government Architect concluded on 22/1/2019, with DPE commencing review of the Plan on 22/1/2019. GA comments on the plan were gathered during the consultation process. LCC did not provide specific direction on the sub- plan regarding cycling and pedestrian access but did review the UDLP against the conditions of consent. These	2. Section 1.5 and Appendix A1 has been updated with the consultation from GANSW and LCC. The UDLP sub-plans were submitted along with the UDLP on 03/10/2018.	 The Compliance Table (Section 1.5, Table 2) does not references this condition. However, Section 1.2 states that the plan (CPAFSP) has been prepared by a suitably qualified and experienced person(s) who requires approval by the Secretary within twelve months of the date of Development Consent It is noted that this plan requires approval as opposed to the approval of the person preparing the plan. Consultation Section 1.6 and Table 3 provides a summary of consultation on Areas 1 and 2 for consultation with LCC and GANSW and states that consultation evidence is included in Appendix A1 and Appendix A1 of the UDLP. It is noted that consultation for Area 2: LCC provided a compliance matrix on concerns and comments on 16/04/20 and the Proponent provided a response on 01/05/20 and consultation is noted as closed. UDLP documentation for Area 2 provided to DPIE (on behalf of GANSW) on 11/05/20 and consultation is noted as waiting on a response. ROW 3 DPIE Comment: Please update the following sections - Update Table 2 Section 1.5 (compliance matrix) to include this condition and the means to comply with this requirement in the and where it can be found in the plan. Update Appendix B1 to include Area 2 consultation. 	Table 2 has been updated to include Condition B140 and relevant references to where this is addressed in the document. Appendix B1 has been updated to include this most recent consultation. LCC provided confirmation deeming the UDLP for Area 2 as satisfactory.

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			comments were received by the Proponent on 3/10/2018. Further action required 2. Update the revision table to include the correct date of when the sub-plan was submitted to LCC consistent with the evidence of engagement in Appendix A of the UDLP.			
4	B141(d) Cycling and Pedestrian Access and Facilities Sub Plan to assist in the safe cycling and pedestrian connectivity and through the MPE precinct by providing dedicated linkages between the warehouses, the freight village and Moorebank Avenue that will contribute to the quality and safety of the pedestrian and cyclist environment associated with the development. The Plan must	This plan	The UDLP Cycling and Pedestrian Access Plan was submitted to the Department for the Government Architect's consultation on 31/08/2018. This consultation was finalised on 22/01/2019, with DPE review period commencing on 22/1/2019. As the plan is staged for W1P (excluding built surface works for the freight village), the safe cycling and pedestrian connectivity through the MPE precinct is limited to the W1P precinct. An update to the plan will be provided for the freight village prior to built surface works for the freight village. The next stage of the plan is the Remainder of the MPE	3. Figure 1-1 has been included in this plan and includes the different stages in relation to the whole of site. This plan does not include details on the freight village (Area 4), and will be updated at a later stage (refer to Section 1.3 for staging).	 Please refer ROWs 5 & 8 DPIE Comments as effectively these are equivalent condition requirements as 141(b) (ii) and paragraph 2 of 141(d) (qualifications and experience of designer/s) It is noted that the quality/amenity of the share path, bordering the MPE site to the north and east, is enhanced by landscaping (garden beds with canopy trees such as Acacia sp., Corymbia sp., Eucalyptus sp. and Melaleuca sp. with low level native planting e.g. Callistemon sp., Crowea sp., Dianella sp. and Myoporum sp. Landscaping in this area is to include potential seating benches located adjacent to the shared pathway providing opportunities for staff meal breaks. Appendix A2 (UDLA-02 Area 1 Masterplan) demonstrates the shared path throughout Area 1. It is noted that landscaping for Area 2 is shown in UDLP Appendix B. ROW 4 DPIE Comment: Please refer UDLP comments for Area 2 noting advice from Council and GANSW. 	Please refer to responses Rows 5 and 8. Noted – UDLP document has also been updated to incorporate GANSW comments

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			Rev 2 dated 8/8/18	DPE comment (Rev 3, dated 18/04/2019)	Rev 5B dated 08/05/20	11/08/20
	be prepared by a		site. Due to the extended			
	suitably qualified		consultation process			
	and experienced		with the GA, DPE has			
	person(s) and		asked the Proponent to			
	approved by the		request an extension to			
	Secretary within		the timeframe to the			
	twelve months of		submission of the plan,			
	the date of this		as the 12 months from			
	approval, unless		the date of the approval			
	otherwise agreed		timeframe has lapsed.			
	by the Secretary.		DPE notes that due to			
			the staging of the plan,			
			the WIP contains limited			
			connectivity to the			
			remaining site, with these aspects to be			
			addressed in			
			subsequent stages of			
			the plan. DPE also notes			
			that changes to the			
			share-path designs			
			along with other material			
			changes to the UDLP			
			have been made during			
			the consultation with the			
			GA.			
			Further action			
			required.			
			3.Please update the			
			plan to include the up-			
			to-date design			
			drawings (at			
			appropriate scale),			
			demonstrating the			
			relationship to the			
			future stages, and the			
			MPE precinct overall.			
			The updated drawings			
			should also contain			
			the correct			
			construction			

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			boundaries and should contain a boundary denoting construction (bulk- earthworks) activities for the freight village.			
5	The Plan must be prepared by a suitably experienced and qualified person(s) in the design and provision of Cycling and Pedestrian Access and Facilities.	Title page Section 1.2	The plan has been prepared by Arcadis in consultation with Reid Campbell (Architects)), and Ground Ink (Landscape Architects). The authors of the Plan are Arcadis consultants). Further action required. 4. Please update the plan to demonstrate that the architect and landscape architect have suitable experience in the design and provision of Cycling and Pedestrian Access and Facilities.	 4. This plan has been prepared by who has experience in the traffic engineering and modelling fields. Further detail on Further detail on This plan has not been prepared in consultation with Reid Campbell and Ground Ink. 	Pages ii, iii and the compliance Table (Table 2) detail the experience and qualifications of the main authors as follows: Area Author Name Qualification Experience 1 Image: Author Name Qualification Experience 2 Image: Author Name Image: Author Name Image: Author Name 2 Image: Author Name Image: Author Name Image: Author Name 2 Image: Author Name Image: Author Name Image: Author Name 2 Image: Author Name Image: Author Name Image: Author Name 2 Image: Author Name Image: Author Name Image: Author Name 2 Image: Author Name Image: Author Name Image: Author Name 2 Image: Author Name Image: Author Name Image: Author Name 2 Image: Author Name Image: Author Name Image: Author Name 2 Image: Author Name Image: Author Name Image: Author Name 2 Image: Author Name Image: Author Name Image: Author Name 2 Image: Author Name Image: Author Name Image: Author Name 2 Image: Author Name Image: Aut	

ROV	Condition No.	Section	DPE Comment Rev 2 dated 8/8/18	Proponent Response DPE comment (Rev 3, dated 18/04/2019)	DPIE Comment Rev 5B dated 08/05/20	Proponent Response 11/08/20
6	The Plan must detail the construction, timing and responsibility for the delivery of Cycling and Pedestrian Access and Facilities and take into account the following considerations:	Section 2.1	The plan commits to providing on-site facilities such as bicycle storage and end of trip facilities that will be provided for each warehouse prior to the warehouse being considered operational. Warehouses would be considered operational until cycle way/pedestrian access have been provided. Construction of cycling and pedestrian access for W1P is expected to occur between Quarter 3 and Quarter 1 of 2019. DPE notes that this schedule is likely to have changed due to	5. The undercover bicycle storage and end of trip facilities will be available for the time of occupation certificate of Warehouse 1, likewise with other warehouses. Refer to Section 2.1 for further detail.	Note: Other co-authors are also detailed on pages i & iii. While it is noted that designers of Area 2 are qualified registered architects with a range of experience across a range of large scale developments, including master planning, and across various jurisdictions there is no specific statement addressing direct experience in the design and provision of Cycling and Pedestrian Access and Facilities. ROW 5 DPIE Comment: Please update pages ii & iii to confirm that have specific experience in the design and provision of Cycling and Pedestrian Access and Facilities. The Compliance Table (Section 1.5, Table 2) references Section 2.1 and states that the relevant Construction Contractor will be responsible for the construction of the designed access and facilities. It also states that the access design of the access was a collaboration between the Principal's designers and Representatives and the plan's authors. Section 2.1 states that on-site facilities (bicycle storage and end of trip facilities, cycle way and pedestrian access) will be provided for each warehouse prior to the warehouse being considered operational and occupation and available at the time of the issue of an occupation certificate. Responsibility for construction Contractor. CLOSED. OS#5 – CLOSED.	Pages ii and iii have been updated to reflect relevant cycling and pedestrian access and facilities experience for

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			the consultation with the GA. Further action required 5. Please update the plan with the current construction timing for the cycling, and pedestrian, and end- of trip facilities etc.			
7	(i) all relevant policies, guidelines and plans	Section 1.5 Section 2.2.1	The relevant policies, guidelines and plans considered during the development of the plan are: Liverpool City Council Development Control Plan 2008, Part 1, General Controls for All Developments City of Sydney Section 3 – General Provisions Australian Standard AS 2890.3 – 1993 Parking Facilities Part 3: Bicycle Parking Facilities Planning Guidelines for Walking and Cycling (DIPNR) 2004 The plan also considers the: NSW Bike Plan (June 2010); and Sydney's Cycling Future (Transport for NSW, 2013)	Noted.	 The Compliance Table (Section 1.5, Table 2) references Section 1.4. Section 1.4 reiterates the policies and guideline contained in previous DPIE comments. Section 2.2 reiterates consideration of previous DPIE comments and Section 2.5 notes that it has been designed in accordance with the 2015 update of <i>AS 20890.3-1997 Parking Facilities Part 3: Bicycle Parking Facilities.</i> It is suggested that the compliance table (Table 2) is updated to also reference Sections 2.2 and 2.5. ROW 7 DPIE Comment: Please clarify if the Guide to Road Design Part 6A: Pedestrian and Cyclist Paths (AUSTROADS, 2009) has been considered in the design and if not please explain why. 	Referencing updates to Table 2 completed as suggested. Requirement to reference the 2009 Austroads guideline has not been previously raised by DPIE, LCC or GANSW. Similarly, the Conditions of Consent do not require the CPAFSP be prepared in consideration of these guidelines. The 2015 version of AS 2890.3 – 1993 has been considered during preparation of this subplan (as per previous DPIE comments and as required by the Consent) and this is referenced within the subplan (Section 1.4 and 2.5). The most recent version of this Australian Standard outdates the

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						Austroads guide and so has been used preferentially.
8	(ii) provide details for the provision of safe and efficient pedestrian and cyclist access connectivity within the development and include integration with the existing and future pedestrian and cycling access in the locality;	Section 2.2 Section 2.3	Section 2.2.1 details the external cycle connectivity for the site. Moorebank avenue does not have a dedicated cycleway, however on-street cycling is accommodated within lane-marked shoulder of 1.5 to 2.5 m width. Figure 2.1 demonstrates the cycle routes in the surrounding area. The <i>NSW Bike Plan</i> and <i>Sydney's Cycling</i> <i>Future</i> has identified bike routes to be constructed around Liverpool on Moorebank Avenue, and designated Moorebank avenue as a strategic bicycle corridor. Section 2.2.2 details the W1P Cycle Connectivity. Access is via an off-road share- path facility on the northern border of W1P, providing access to the bicycle parking facilities located in the car park area. DPE notes that this shared path has been updated during UDLP consultation.	6. The shared path for Warehouse 1 is shown in Appendix A2 which includes the meandering path located north of the freight village. The shared path for the entire site is shown in Appendix G. The drawings in Appendix A2 and Appendix G are also included in the UDLP, and have been developed in consultation with GANSW.	The Compliance Table (Section 1.5, Table 2) references Sections 2.2, 2.2.1, 2.2.2, 2.3, 2.3.1, 2.3.2 and states that pedestrian and cycle access is provided via shared paths throughout the site that connect Areas 1 and 2 and will progressively connect all areas with details in updates to this CPAFSP. Cycle access and connectivity across the site is provided in Section 2.2 (overview) and Sections 2.2.1 and 2.2.2.(details for Areas 1 & 2) which reiterates details provided in previous DPIE comments. Pedestrian access and connectivity across the site is provided in Section 2.3 (overview) and Sections 2.3.1 and 2.3.2.(details for Areas 1 & 2) CYCLING ACCESS & CONNECTIVITY Section 2.2 advises that: External to MPE site - no existing cycleway along Moorebank Ave, although there are lane-marked shoulders (1.5 to 2.5 m width). - Moorebank Avenue connects to a series of cycle routes in the surrounding area, as shown in Figure 2-1, in the form of either on-street cycle lanes or along local roads. An example is a cycle route from the site to Holsworthy train station is possible via a connection of shared paths and local streets in the Wattle Grove residential area (cycling distance of approximately 5.6 km) however this is not shown on Figure 1-1. - cycleway improvements are outlined in: * The <i>NSW Bike Plan</i> (June 2010) – identifies bike routes to be constructed around Liverpool on Moorebank Avenue, Heathcote Road and Newbridge Road, and * <i>Sydney's Cycling Future</i> (Transport for NSW, 2013) - commits to completing missing links in the existing network to the Liverpool CBD. This would include improving bicycle access to the Liverpool City Centre from the south by completing the missing sections of the	Holsworthy train station is now identified on Figure 2-1, along with local cycleway networks including a route from the site to Holsworthy train station through the Wattle Grove residential area.

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			Pedestrian access to W1P will be via the share path. Several intersections along Moorebank Avenue provide safe crossings. Pedestrian access to the Office is via the off- road share path located on the northern border of W1P. Further action required. 6. Please update the plan with the most up- to-date drawings developed during the consultation with the GA. Specifically, the meandering share- path should be the same as the one depicted during consultation.		off-road walking and cycling corridor along Glenfield Creek, between Casula and Liverpool. This improved access would integrate with the cycling routes proposed in the Liverpool Bike Plan (Liverpool Council, 2009). Moorebank Avenue is also considered a strategic bicycle corridor. Internal to MPE site – Overview of Areas 1 & 2 - the shared path extends along the northern boundary of the MPE Site, north of the freight village and north of the WH2 carpark, then continues south along the eastern boundary of the MPE Site. This shared pathway is situated on the east side of the multi- tenant user road and extends along the internal roads between WH1 and WH2, WH3 and WH4, and WH6 and WH7. Internal shared pathways are outlined in Appendix G of the UDLP. Area 1 - Overview Section 2.2.1 states that cyclist access to WH1 is via the shared paths from Moorebank Avenue, along the northern landscaped boundary of the freight village with direct access to the bicycle parking facilities (north-east section of WH1). This shared path is referenced as shown in Appendix A2 for Area 1 only and Appendix G of the UDLP for the entire site. Area 2 - Overview Section 2.2.2 states that cyclist access to WH3, WH4 and WH5 is also via the shared path, extends south along the internal road between Warehouses 1 and 2, then continues east between 'Warehouse' and Area 2 on the northern side of the internal road. WH3 Cyclists need to cross the pedestrian crossing to WH3 where the shared path continues to the bicycle parking facilities located at Office 3B, (Appendix B2 – Dwg # W3W4-NTT-AR-DWG-0101).	

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					Cyclists need to cross the pedestrian crossing to WH4, then continue west along the internal road shared path between WH3 and W4 to the bicycle parking facilities located at Warehouse 4 (Appendix B2 drawing no. W3W4-NTT-AR-DWG-0105).	
					WH5 Cyclists need to travel west on the shared path from WH4 on the internal access road to WH 5, then along the pedestrian pathways to access the bicycle parking facilities located adjacent to Office 5A or Office 5B (Appendix B2 drawing no. WHP5-RCG-AR-DWG- UDLP1-C and WHP5-RCG-AR-DWGUDLP2-C).	
					PEDESTRIAN ACCESS & CONNECTIVITY Section 2.3 advises that: External to MPE site Pedestrian access will be via the shared path from Moorebank Avenue, adjacent to the Defence Joint Logistics Unit (DJLU) intersection. Pedestrian safety and connectivity to MPE is considered good due to several signalised pedestrian crossings (spaced 250m-600m apart), clear motorist sightlines and relatively low pedestrians volumes.	
					Internal to MPE site Pedestrians will access through the shared path extending along the northern boundary of the MPE Site, north of the freight village and north of the carpark of Warehouse 2. The shared path continues south along the eastern boundary of the MPE Site. This shared pathway is situated on the east side of the multi-tenant user road and	
					As previously noted, the shared path is sited along the northern and eastern MPE site boundaries and extends along the internal roads between Warehouse 1 and 2, Warehouse 3 and 4, and Warehouse 6 and 7. (Refer UDLP Appendix G). Areas 1 and 2 are connected via a	

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					 north-south shared path between WH1 and WH2 which continues east along the internal road between WH2 and Area 2. Sections 2.3.1 and 2.3.2 provide area specific pedestrian access details to warehouses in Areas 1 and 2. ROW 8 DPIE Comment: Please update plan to: Update figure 2.2 to show existing pedestrian paths from key transport nodes that provide pedestrian access to the site such as local bus stops, Glenfield, Holsworthy and Casula train stations. clarify cycling routes to bicycle parking facilities at each warehouse by providing figures at the base of each paragraph from the shared pathway along the eastern boundary of the site (via extracts from the Appendices). identify on Figure 2-1 cycling route between the site and Holsworthy train station and potential linking cyclepaths per <i>NSW Bike Plan</i> (June 2010) and <i>Sydney's Cycling Future</i> (Transport for NSW, 2013). Please demonstrate how feedback obtained from Council and GANSW has been incorporated into this plan. 	A new figure has been included in Section 2.3 (Figure 2-6) to show the site location in relation to local train stations, and provide further information regarding existing pedestrian paths from key transport nodes including local bus stops, and Glenfield, Holsworthy and Casula train stations. As outlined in the report, although pedestrian access is available from each of these stations to the MPE Site, the distance to travel (between 3.5 and 10.5 km) would make this impractical. The report therefore provides details on the connectivity of these stations to local bus services that travel to Moorebank Avenue. Pedestrian access from these bus stops to the MPE Site is then available and more easily accessible. Figures showing the cycling routes to bicycle parking facilities in Area 1 and Area 2 via the eastern shared pathway are now included as requested in Section 2.2.

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						paths as outlined in the NSW Bike Plan (2020) and Sydney's Cycling Future (2013) have been provided in Section 2.2.
						Council has deemed UDLP documentation for Area 2 as satisfactory and has provided no further feedback in relation to pedestrian movement throughout the site and surrounding areas, with regards to Area 2 (refer to Appendix B1). DPIE/GANSW comments and advice have been incorporated into the UDLP and subplans; please refer to responses to comments in relation to the UDLP and subplans, including this subplan, for relevant updates to the UDLP documentation.
9	(iii) provide details of end of trip facilities available on-site at each warehouse which are to include under cover bike storage, showers and change facilities sufficient to accommodate the needs of the forecast number of employee; and	Section 2.4	The plan contains detail of the end of trip facilities, such as amenities, showers and lockers, based on the needs of an estimated 100 people per day over a 10-hour shift for Warehouse 1. 7. The UDLP and Cycling and Pedestrian Access Management Plan drawings should both clearly contain the location of the undercover bike storage. Please note, the condition requires that an under-cover	 7. The location of the undercover bicycle parking spaces is shown in Appendix A2. Figure 2-3 has been added to Section 2.4.1 and shows the details of the undercover bicycle facilities. 8. The amenity block containing the showers, toilets and lockers in relation to Warehouse 1 is shown in Appendix A2. The male and female amenities are, 2.4.2 located near the entrance of the Warehouse 1 office. 	 The Compliance Table (Section 1.5, Table 2) references Sections 2.4.1, 2.4.2 and states that the end of trip facilities include toilets, lockers, sinks and showers (male, female and ambulant) and bicycle parking facilities available at WH1, WH3, WH4 and WH5. Section 2.4 states that the end of trip facilities for warehouses in Areas 1 & 2 have been designed to align with <i>City of Sydney Section 3 – General Provisions</i> (for Industry or Warehouse/Distribution Centres). Facility quantams for each warehouse are itemised in Sections 2.4.1, 2.4.2. The plan states, in Section 2.5, that all the end of trip cycling facilities for Areas 1 & 2 warehouses are aligned with the latest version of <i>AS 2890.3 – 1993 Parking Facilities Part 3: Bicycle Parking Facilities</i> with design meeting standard design requirements (quantity, functionality, convenience, security) with these facilities 	

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			parking space be provided, and it is unclear in the plan as to whether this has been included. Update plan. 8. It is unclear in the plan exactly where the amenity block containing the showers/toilet/lockers will be located. Please update the drawing in the plan to demonstrate where this is in relation to the W1P / share path / Office and include this in the updated UDLP drawings.		 covered and adjoining offices. Renders of the bike parking facilities (refer Figures 2-3-2-6) and certificates provided to the Property Council of Australia (PCA) for all warehouses in Areas 1 & 2. 1. The plan also states that end of trip facilities cater for the quantum of staff members per warehouse – which are consistent with the EOMBASP. Previous DPIE comments apply re Areas 1 WH1 as provided in Section 2.4.1. End of trip facilities design details are shown in the following Appendices and drawings: Bike parking WH 1- Appendix A2 WH3 – not referenced WH4 – not referenced WH4 – not referenced WH3 – in Appendix B2 (Drawing No.WHP5-RCG-AR-DWG-UDLP8-B). Amenity facilities WH 1- Appendix A2 WH3 – Appendix B2 (Drawing No. WHP3-NTT-AR-DWG-0501 and WHP3-NTT-AR-DWG-0503). WH4 – in Appendix B2 (Drawing No. WHP4-NTT-AR-DWG-0501, WHP4-NTT-AR-DWG-0502 and WHP4-NTT-AR-DWG-0503). WH5 – Appendix B2 (Drawing No. WHP4-NTT-AR-DWG-0501, WHP4-NTT-AR-DWG-0502 and WHP4-NTT-AR-DWG-0503). WH5 – Appendix B2 (Drawing No. WHP4-NTT-AR-DWG-0501, WHP4-NTT-AR-DWG-0502 and WHP4-NTT-AR-DWG-0503). ROW 9 DPIE Comment: Drawings to be updated as follows; Title blocks and identification labels to be included Show floor plan and design details of end of trip and bike parking facilities for each individual warehouse on site plans. 	Due to scale and sizing, a single masterplan for Area 2 was considered impractical, and so landscape masterplans for WH3 & 4 (W3W4-GNK-LN-DWG-2001) and WH5 (WHP5-GNK-LN-DWG- 1001) have been prepared to provide further details regarding locations of bicycle parking and

ROW	Condition No.	Section	DPE Comment Rev 2 dated 8/8/18	Proponent Response DPE comment (Rev 3, dated 18/04/2019)	DPIE Comment Rev 5B dated 08/05/20	Proponent Response 11/08/20
						end of trip facilities, as well as EOMBAs.
						Undercover bicycle parking locations, floor plans and perspective views for Warehouses 3 and 4 are provided in Appendix B2 on drawings W3W4-GNK-LN-DWG- 2001, W3W4-NTT-AR-DWG- 0101, W3W4-NTT-AR-DWG- 0105, W3W4-NTT-AR-DWG- 0122 and W3W4-NTT-AR-DWG- 0126.
						Undercover bicycle parking locations, floor plans and perspective views for Warehouse 5 are provided in Appendix B2 on drawings WHP5-GNK-LN-DWG- 1001 and WHP5-RCG-AR-DWG- UDLP8.
						Plans for bicycle parking and amenity facilities are provided in Appendices A2 and B2 as noted in DPIE/GANSW comments for Warehouses 1, 3, 4 and 5 in Areas 1 and 2.
						SBA Architects drawing 17189 GA201-AA has been included in Appendix A2 to provide context to the Arcadis inset drawings for Area 1. The Arcadis drawings are consistent with the design information provided in UDLA-02 for Area 1. We note that while design detail requirements as per SSD 7628 CoC have been

ROW	Condition No.	Section	DPE Comment Rev 2 dated 8/8/18	Proponent Response DPE comment (Rev 3, dated 18/04/2019)	DPIE Comment Rev 5B dated 08/05/20	Proponent Response 11/08/20
						included in the UDLP documentation, there is no specific CoC which requires title blocks on all plans/drawings.
10	(iv) the layout, design and security of bicycle facilities must comply with the minimum requirements of <i>Australian</i> <i>Standards AS</i> 2890.3 – 1993 <i>Parking Facilities</i> <i>Part 3: Bicycle</i> <i>Parking</i> <i>Facilities.</i>	Section 2.5	DPE notes that AS 2890.3 1993 was updated in 2015, and that compliance with the Standard can help the project achieve the desired Green Star rating. DPE notes that the layout, design and security of bicycle facilities aligns with the minimum requirements of AS 20890.3 1993 and 2015. 9. Please correct the date in Section 2.5 to demonstrate compliance with 1993, noting that the Standard has been updated in 2015, and that safety, space-per bicycle, aisle access and sturdy construction are compliant with the Standards. Update this section after reviewing the 2015 update and include any material changes relating to the design concepts within the Standard.	9. Section 2.5 has been updated to include the following: "AS 2890.3 has been updated in 2015 and the end of trip facilities have been designed to meet the relevant AS. A certificate has been provided to the Property Council of Australia (PCA) for the construction certificate."	CLOSED. Please note ROW 9 DPIE Comments above.	

ROW	Condition No.	Section	DPE Comment Rev 2 dated 8/8/18	Proponent Response DPE comment (Rev 3, dated 18/04/2019)	DPIE Comment Rev 5B dated 08/05/20	Proponent Response 11/08/20
11	The approved plan must be implemented prior to occupation of the warehouse and freight village.	Section 1.2	The approved plan will be implemented prior to occupation of Warehouse 1. DPE notes that an updated plan will be submitted prior to permanent built service works for the freight village and will be implemented prior to the occupation of the freight village (once this plan is approved). Satisfactory.	Noted.	CLOSED. Please refer ROW 1 DPIE Comments.	
12	FCCM 1E Bicycle and end of trip facilities would be provided in accordance with the City of Sydney Section 3 – General Provisions.	Section 1.5	The plan states that End of Trip facilities are to be provided in accordance with The City of Sydney Section 3 – General Provisions. Satisfactory.	Noted.	CLOSED. Please refer ROWs 7 & 8 DPIE Comments.	





05/06/2020

Dear

Approval of Urban Design and Landscape Plan – Moorebank Logistics Park East (SSD 7628)

I refer to your correspondence requesting the Planning Secretary's approval for the staged Urban Design and Landscape Plan (UDLP) for Area 1 only under condition B140 of SSD 7628. This plan has been staged with the approval of the Planning Secretary in accordance with the requirements of conditions A14 and A15.

The UDLP for Area 1 has been carefully reviewed and I note that the plan:

- has been reviewed by SIMTA and no issues have been raised
- has been prepared in consultation with Liverpool City Council
- has been reviewed by the Government Architect of NSW.

As nominee of the Planning Secretary, I approve the UDLP for Area 1 (Revision 8, dated 11 March 2020) only pursuant to condition B140, <u>excluding condition B140 (e)(vi)</u>.

I also approve the amended development layout plan (Reference: SSS2-RCG-AR-SKC-161A), including the amended layout of OSD 9 pursuant to condition A22 of SSD 7628.

I note that the landscaping for the as-constructed car park within Area 1 does not satisfy the requirements of condition B140(e)(iv) and has therefore not been approved. This matter has been referred to the Department's Compliance team for review.

I note that Area 1 does not achieve all the minimum landscaping requirements of condition B140. However, I note your commitment that future stages will achieve the minimum landscaping requirements of condition B140 for the MPE Stage 2 overall. You are also reminded that in my letter dated 24 April 2020, I approved the changes to the UDLP for MPE Stage 1 subject to you providing additional compensatory landscaping on MPE Stage 2. You must detail how this will be achieved in future stages of the MPE Stage 2 UDLP.

You are reminded that If there is any inconsistency between the approved documents and the conditions of consent, then the requirements of the conditions of consent will prevail.

If you require any further information please contact

Yours sincerely



As nominee of the Planning Secretary

DPE review comments - Condition B141 (d) UDLP Cycling and Pedestrian Access and Facilities Sub Plan, Rev 2 dated 8/8/18

Condition No.	Section	DPE Comment	Proponent Response
A14 With the approval of the Secretary, the Applicant may submit any strategy, plan or program required by this consent on a staged basis.	Section 1.3	The Cycling and Pedestrian Access and Facility (CPASFSB) Warehouse 1 Precinct (W1P) has been submitted on a staged basis (excluding the built surface works for the freight village). Satisfactory, noting comments listed under A15.	 This plan has been updated in Section 1.3 to include the different stages associated with this plan. The stages of this plan include: Area 1 – Warehouse 1 including area north of freight village Area 2 – Warehouse 3, 4 and 5 Area 3 – Warehouse 6, 7 and 8 Area 4 – Freight village Area 5 – Warehouse 2 Area 6 – Moorebank Avenue Works Section 1.3.2.outlines the following: "Area 1 is the first stage of this EOMBASP and includes Warehouse 1 and the immediate area surrounding Warehouse 1 (excluding the freight village). The detailed plans for future stages, i.e. Areas 2 - 6, of this EOMASP are anticipated to be provided in multiple submissions as described in Table 1. Each future staged submission will be incremental and present the detailed present the cycling and pedestrian connectivity requirements for that stage." Reference to W1P has also been removed throughout the entire document. As outlined in Section 1.3.3, the trigger for updating this plan will be submitted one month prior to permanent built surface works and/or landscaping of the next stage.
A15 If the submission of any strategy, plan or program is to be staged, then the relevant strategy, plan or program must clearly describe the specific stage of the development to which the strategy, plan or program applies, the relationship of the stage to any future stages and the trigger for updating the strategy, plan or program	Section 1.3	 The specific stage of the plan is the Warehouse 1 and the area inside W1P (excluding the freight village). The trigger for updating the CPAFSB is prior to the installation of cycling and pedestrian facilities and access arrangements for the freight village. The trigger for submission of the second stage (CPAFSP – Remainder of Site) will be prior to the commencement of permanent built surface works for the remainder of site. Works will only progress beyond bulk earthworks for the remainder of the site upon approval of the CPAFSP – Remainder of Site. Further action required. Please ensure that the trigger for updating the CPASFSB is consistent with the overarching UDLP i.e. prior to the commencement of built surface works for the freight village. 	 Section 1.3 has been updated to include the different stages applicable to this plan, as described above. Figure 1-1 has been included in this plan and includes the different stages in relation to the whole of site.

Condition No.	Section	DPE Comment	Proponent Response
B140 The UDLP must be prepared by a suitably qualified and experienced person(s), in consultation with the relevant council(s). The UDLP must be approved by the Secretary, in consultation with the NSW Government Architect.		 The UDLP Appendix A states that the plan was submitted to Liverpool City Council on 14/8/2018, with comments received back on 3 October 2018. The Sub-plan was submitted (along with the overarching UDLP) to the Department for the Government Architect's consultation on 31/08/2018, prior to Liverpool City Council's comments being received. Consultation with the Government Architect concluded on 22/1/2019, with DPE commencing review of the Plan on 22/1/2019. GA comments on the plan were gathered during the consultation process. LCC did not provide specific direction on the sub-plan regarding cycling and pedestrian access but did review the UDLP against the conditions of consent. These comments were received by the Proponent on 3/10/2018. Further action required 2. Update the revision table to include the correct date of when the sub-plan was submitted to LCC consistent with the evidence of engagement in Appendix A of the UDLP. 	2. Section 1.5 and Appendix A1 has been updated with the consultation from GANSW and LCC. The UDLP sub-plans were submitted along with the UDLP on 03/10/2018.
B141(d) Cycling and Pedestrian Access and Facilities Sub Plan to assist in the safe cycling and pedestrian connectivity and through the MPE precinct by providing dedicated linkages between the warehouses, the freight village and Moorebank Avenue that will contribute to the quality and safety of the pedestrian and cyclist environment associated with the development. The Plan must be prepared by a suitably qualified and experienced person(s) and approved by the Secretary within twelve months of the date of this approval, unless otherwise agreed by the Secretary.	This plan	The UDLP Cycling and Pedestrian Access Plan was submitted to the Department for the Government Architect's consultation on 31/08/2018. This consultation was finalised on 22/01/2019, with DPE review period commencing on 22/1/2019. As the plan is staged for W1P (excluding built surface works for the freight village), the safe cycling and pedestrian connectivity through the MPE precinct is limited to the W1P precinct. An update to the plan will be provided for the freight village prior to built surface works for the freight village. The next stage of the plan is the Remainder of the MPE site. Due to the extended consultation process with the GA, DPE has asked the Proponent to request an extension to the timeframe to the submission of the plan, as the 12 months from the date of the approval timeframe has lapsed. DPE notes that due to the staging of the plan, the WIP contains limited connectivity to the remaining site, with these aspects to be addressed in subsequent stages of the plan. DPE also notes that changes to the share-path designs along with other material changes to the UDLP have been made during the consultation with the GA. Further action required.	3. Figure 1-1 has been included in this plan and includes the different stages in relation to the whole of site. This plan does not include details on the freight village (Area 4), and will be updated at a later stage (refer to Section 1.3 for staging).

Condition No.	Section	DPE Comment	Proponent Response
		3. Please update the plan to include the up-to-date design drawings (at appropriate scale), demonstrating the relationship to the future stages, and the MPE precinct overall. The updated drawings should also contain the correct construction boundaries and should contain a boundary denoting construction (bulk-earthworks) activities for the freight village.	
The Plan must be prepared by a suitably experienced and qualified person(s) in the design and provision of Cycling and Pedestrian Access and Facilities.	Title page Section 1.2	 The plan has been prepared by Arcadis in consultation with Reid Campbell (Architects) (), and Ground Ink (Landscape Architects). The authors of the Plan are Arcadis consultants (). Further action required. Please update the plan to demonstrate that the architect and landscape architect have suitable experience in the design and provision of Cycling and Pedestrian Access and Facilities. 	 4. This plan has been prepared by who has experience in the traffic engineering and modelling fields. Further detail on This plan has not been prepared in consultation with Reid Campbell and Ground Ink.
The Plan must detail the construction, timing and responsibility for the delivery of Cycling and Pedestrian Access and Facilities and take into account the following considerations:	Section 2.1	 The plan commits to providing on-site facilities such as bicycle storage and end of trip facilities that will be provided for each warehouse prior to the warehouse being considered operational. Warehouses would be considered operational until cycle way/pedestrian access have been provided. Construction of cycling and pedestrian access for W1P is expected to occur between Quarter 3 and Quarter 1 of 2019. DPE notes that this schedule is likely to have changed due to the consultation with the GA. Further action required 5. Please update the plan with the current construction timing for the cycling, and pedestrian, and end-of trip facilities etc. 	5. The undercover bicycle storage and end of trip facilities will be available for the time of occupation certificate of Warehouse 1, likewise with other warehouses. Refer to Section 2.1 for further detail.
(i) all relevant policies, guidelines and plans	Section 1.5 Section 2.2.1	 The relevant policies, guidelines and plans considered during the development of the plan are: Liverpool City Council Development Control Plan 2008, Part 1, General Controls for All Developments City of Sydney Section 3 – General Provisions Australian Standard AS 2890.3 – 1993 Parking Facilities Part 3: Bicycle Parking Facilities 	Noted.

Condi	tion No.	Section	DPE Comment	Proponent Response
			 Planning Guidelines for Walking and Cycling (DIPNR) 2004 The plan also considers the: NSW Bike Plan (June 2010); and Sydney's Cycling Future (Transport for NSW, 2013) 	
(ii)	provide details for the provision of safe and efficient pedestrian and cyclist access connectivity within the development and include integration with the existing and future pedestrian and cycling access in the locality;	Section 2.2 Section 2.3	 Section 2.2.1 details the external cycle connectivity for the site. Moorebank avenue does not have a dedicated cycleway, however on-street cycling is accommodated within lane-marked shoulder of 1.5 to 2.5 m width. Figure 2.1 demonstrates the cycle routes in the surrounding area. The <i>NSW Bike Plan</i> and <i>Sydney's Cycling Future</i> has identified bike routes to be constructed around Liverpool on Moorebank Avenue, and designated Moorebank avenue as a strategic bicycle corridor. Section 2.2.2 details the W1P Cycle Connectivity. Access is via an off-road share-path facility on the northern border of W1P, providing access to the bicycle parking facilities located in the car park area. DPE notes that this shared path has been updated during UDLP consultation. Pedestrian access to W1P will be via the share path. Several intersections along Moorebank Avenue provide safe crossings. Pedestrian access to the Office is via the off-road share path located on the northern border of W1P. Further action required. Please update the plan with the most up-to-date drawings developed during the consultation with the GA. Specifically, the meandering share-path should be the same as the one depicted during consultation. 	6. The shared path for Warehouse 1 is shown in Appendix A2 which includes the meandering path located north of the freight village. The shared path for the entire site is shown in Appendix G. The drawings in Appendix A2 and Appendix G are also included in the UDLP, and have been developed in consultation with GANSW.
(iii)	provide details of end of trip facilities available on-site at each warehouse which are to include under cover bike storage, showers and change facilities sufficient to accommodate the needs of the forecast number of employee; and	Section 2.4	 The plan contains detail of the end of trip facilities, such as amenities, showers and lockers, based on the needs of an estimated 100 people per day over a 10-hour shift for Warehouse 1. 7. The UDLP and Cycling and Pedestrian Access Management Plan drawings should both clearly contain the location of the undercover bike storage. Please note, the condition requires that an under-cover parking space be provided, and it is unclear in the plan as to whether this has been included. Update plan. 8. It is unclear in the plan exactly where the amenity block containing the showers/toilet/lockers will be located. Please update the drawing in the plan to demonstrate 	 7. The location of the undercover bicycle parking spaces is shown in Appendix A2. Figure 2-3 has been added to Section 2.4.1 and shows the details of the undercover bicycle facilities. 8. The amenity block containing the showers, toilets and lockers in relation to Warehouse 1 is shown in Appendix A2. The male and female amenities are located near the entrance of the Warehouse 1 office.

Condition No.	Section	DPE Comment	Proponent Response
		where this is in relation to the W1P / share path / Office and include this in the updated UDLP drawings.	
 (iv) the layout, design and security of bicycle facilities must comply with the minimum requirements of Australian Standards AS 2890.3 – 1993 Parking Facilities Part 3: Bicycle Parking Facilities. 	Section 2.5	 DPE notes that AS 2890.3 1993 was updated in 2015, and that compliance with the Standard can help the project achieve the desired Green Star rating. DPE notes that the layout, design and security of bicycle facilities aligns with the minimum requirements of AS 20890.3 1993 and 2015. 9. Please correct the date in Section 2.5 to demonstrate compliance with 1993, noting that the Standard has been updated in 2015, and that safety, space-per bicycle, aisle access and sturdy construction are compliant with the Standards. Update this section after reviewing the 2015 update and include any material changes relating to the design concepts within the Standard. 	9. Section 2.5 has been updated to include the following: "AS 2890.3 has been updated in 2015 and the end of trip facilities have been designed to meet the relevant AS. A certificate has been provided to the Property Council of Australia (PCA) for the construction certificate."
The approved plan must be implemented prior to occupation of the warehouse and freight village.	Section 1.2	The approved plan will be implemented prior to occupation of Warehouse 1. DPE notes that an updated plan will be submitted prior to permanent built service works for the freight village and will be implemented prior to the occupation of the freight village (once this plan is approved). Satisfactory.	Noted.
FCCM 1E Bicycle and end of trip facilities would be provided in accordance with the City of Sydney Section 3 – General Provisions.	Section 1.5	The plan states that End of Trip facilities are to be provided in accordance with The City of Sydney Section 3 – General Provisions. Satisfactory.	Noted.



Appendix 1 – Area 1 Cycle and Pedestrian Access and Facilities Drawings and Figures

PROPOSED PLANT PALETTE

BOTANICAL NAME	COMMON NAME	NATIVE	EXPECTED CANOPY SPREAD	EXPECTED MATURE HEIGHT	INSTALL SIZE	DEN
Trees						•
Acacia decurrens	Black Wattle	\checkmark	3-7m	10-15m	140mm-100L	5m ce
Acacia parramattensis	Parramatta Green Wattle	\checkmark	3-7m	10m	140mm-100L	5m ce
Allocasuarina littoralis	Black She-Oak	\checkmark	5-10m	10m	140mm-100L	5m ce
Angophora bakeri	Narrow Leafed Apple	\checkmark	8-13m	10m	140mm-100L	5m ce
Angophora floribunda	Rough-barked Apple	\checkmark	10-15m	20m	140mm-100L	6m ce
Corymbia ficifolia	Flowering Gum	\checkmark	3-7m	10m	140mm-100L	6m ce
Corymbia maculata	Spotted Gum	\checkmark	6-10m	30m	140mm-100L	6m ce
Callistemon salignus	White Bottlebrush, Pink-tips	\checkmark	3-7m	9m	140mm-100L	5m ce
Eucalyptus amplifolia	Cabbage Gum	\checkmark	5-10m	30m	140mm-100L	6m ce
Eucalyptus baueriana	Blue Box	\checkmark	8-13m	20m	140mm-100L	6m ce
Eucalyptus bosistoana	Coast Grey Box	\checkmark	8-13m	60m	140mm-100L	6m ce
Eucalyptus eugenioides	Thin-leaved stringybark	\checkmark	8-13m	30m	140mm-100L	6m ce
Eucalyptus crebra	Narrow-leafed Ironbark	\checkmark	3-7m	15m	140mm-100L	6m ce
Eucalyptus moluccana	Grey Box	\checkmark	13-18m	20m	140mm-100L	6m ce
Eucalyptus racemosa	Snappy Gum, Scribbly Gum	\checkmark	5-10m	15m	140mm-100L	6m ce
Eucalyptus sideroxylon	Mugga, Red Ironbark	\checkmark	3-6m	20-25m	140mm-100L	6m ce
Eucalyptus punctata	Grey Gum	\checkmark	6-9m	10-25m	140mm-100L	6m ce
Eucalyptus tereticornis	Forest Red Gum	\checkmark	3-6m	20-25m	140mm-100L	6m ce
Melaleuca decora	White Cloud Tree	\checkmark	6-10m	6-10m	140mm-100L	6m ce
Melaleuca linariifolia	Flax-leaved Paperbark	\checkmark	3-7m	10m	140mm-100L	5m ce
Pittosporum undulatum	Pittosporum	\checkmark	3-7m	10m	140mm-100L	5m ce
Shrubs						
Acacia brownii	Golden Prickly Moses	\checkmark	N/A	1m	140-200mm	2m ce
Acacia falcata	Sickle Wattle	\checkmark	N/A	4m	140-200mm	2m ce
Banksa spinulosa 'Birthday Candles'	Birthday Candles	\checkmark	N/A	0.5m	140-200mm	0.5m c
Bursaria spinosa	Sweet Bursaria	\checkmark	N/A	1.5-3m	140-200mm	2m ce
Callistemon citrinus	Scarlet Bottlebrush	\checkmark	N/A	4m	140-200mm	2m ce
Callistemon linearis	Narrow-leaved Bottlebrush	\checkmark	N/A	3m	140-200mm	2m ce
Crowea exalata	Small Crowea	\checkmark	N/A	0.5m	140-200mm	0.5m c
Crowea saligna	Willow-leaved Crowea	\checkmark	N/A	1m	140-200mm	0.5m c
Dillwynia sieberi	Prickly Parrot Pea	\checkmark	N/A	0.5-2m	140-200mm	2m ce
Eriostemon australasius	Pink Wax Flower	\checkmark	N/A	1.5m	140-200mm	1m ce
Kunzea ambigua	Tick-bush	\checkmark	N/A	2.5m	140-200mm	1m ce
Leptospermum polygalifolium	Tantoon	\checkmark	N/A	0.5-3m	140-200mm	1m ce
Melaleuca nodosa	Ball Honey-myrtle	\checkmark	N/A	4m	140-200mm	2m ce
Philotheca buxifolius	Box-leaf Waxflower	\checkmark	N/A	0.5m	140-200mm	1m ce
Grasses, Sedges and Groundcovers						
Anigozanthos 'Bush Gold'	Kangaroo Paw	\checkmark	N/A	1m	150mm	6/r
Arthropodium milleflorum	Pale Vanilla Lily	\checkmark	N/A	0.3-1m	150mm	6/r
Austrodanthonia fulva	Wallaby Grass	\checkmark	N/A	0.7m	150mm	6/r
Dianella caerulea	Blue Flax-lily	\checkmark	N/A	0.6m	150mm	6/r
Dianella revoluta	Blue Flax-lily, Spreading Flax-lily	\checkmark	N/A	0.8m	150mm	6/r
Dichondra repens	Kidney-weed, Mercury Bay Weed	\checkmark	N/A	0.3m	150mm	4/r
, Hardenbergia violacea	False Sarsaparilla	\checkmark	N/A	Creeper	150mm	3/r
Hibbertia diffusa	Wedge Guinea Flower	\checkmark	N/A	0.3m	150mm	4/r
Lomandra longifolia	Spiky-headed Mat-rush	√	N/A	0.7m	150mm	6/r
Lomandra hystrix	Spiny-headed Mat-rush	√	N/A	1m	150mm	6/r
Microlaena stipoides	Weeping Grass, Meadow Rice-grass		N/A N/A	0.7m	150mm	6/r
Myoporum parvifolium 'Yareena'		 ✓	N/A	0.1m	150mm	3/r
Themeda australis	Myoporum Kangaroo Grass	 ✓	N/A N/A	0.1m	150mm	5/1 6/1
Wahlenbergia gracilis	Australian Bluebell	 ✓	N/A N/A	0.8m	150mm	9/r
wannenbergia gracilis		Ť	IN/A	0.2111		9/1

OFFICE OPEN SPACE PLANTER PLANT PALETTE (NUMBER 6 ON PLAN)

OTANICAL NAME COMMON NAME		NATIVE	EXPECTED MATURE HEIGHT	EXPECTED MATURE SPREAD	INSTALL SIZE	DENS
Climbers and Groundcovers						
Banksia 'Birthday Candles'		\checkmark	0.5m	0.5-1m	150mm	6-8/
Carpobrotus glaucescens	Pigface	\checkmark	0.3	2m	150mm	4/n
Trachelospermum jasminoides	Star Jasmine		2m	2m	150mm	4/n

RAIN GARDEN PLANT PALETTE ON MPE SITE (NUMBER 13 ON PLAN)

BOTANICAL NAME	COMMON NAME	NATIVE	EXPECTED MATURE HEIGHT	INSTALL SIZE	DENSITY
Climbers and Groundcovers					
Baumea articulata	Jointed Twig-rush	\checkmark	1-2m	150mm	4/m ²
Carex appressa	Tall Sedge	\checkmark	0.8m	150mm	4/m ²
Dichondra repens	Kidney-weed, Mercury Bay Weed	\checkmark	0.3	150mm	6/m ²
Goodenia hederacea	Ivy Goodenia	\checkmark	0.5m	150mm	4/m ²
Lomandra leucocephala	Woolly Mat-Rush	\checkmark	0.4m	150mm	4/m ²
Microlaena stipoides	Weeping Grass, Meadow Rice-grass	\checkmark	0.7m	150mm	4/m ²

NOTE: Hydro mulching/ Hydroseeding may be considered for some landscaping areas to achieve a rich mixture of trees, shrubs and groundcovers. This will be subject to seasonal variation at the time of plant installation and will be subject to nursery availability and pot sizes at the time of plant procurement.

Landscape Architect




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Client



124 Walker St, North Sydney NSW 2060 Ph. (02) 8907 0700 http://www.tacticalgroup.com.au/



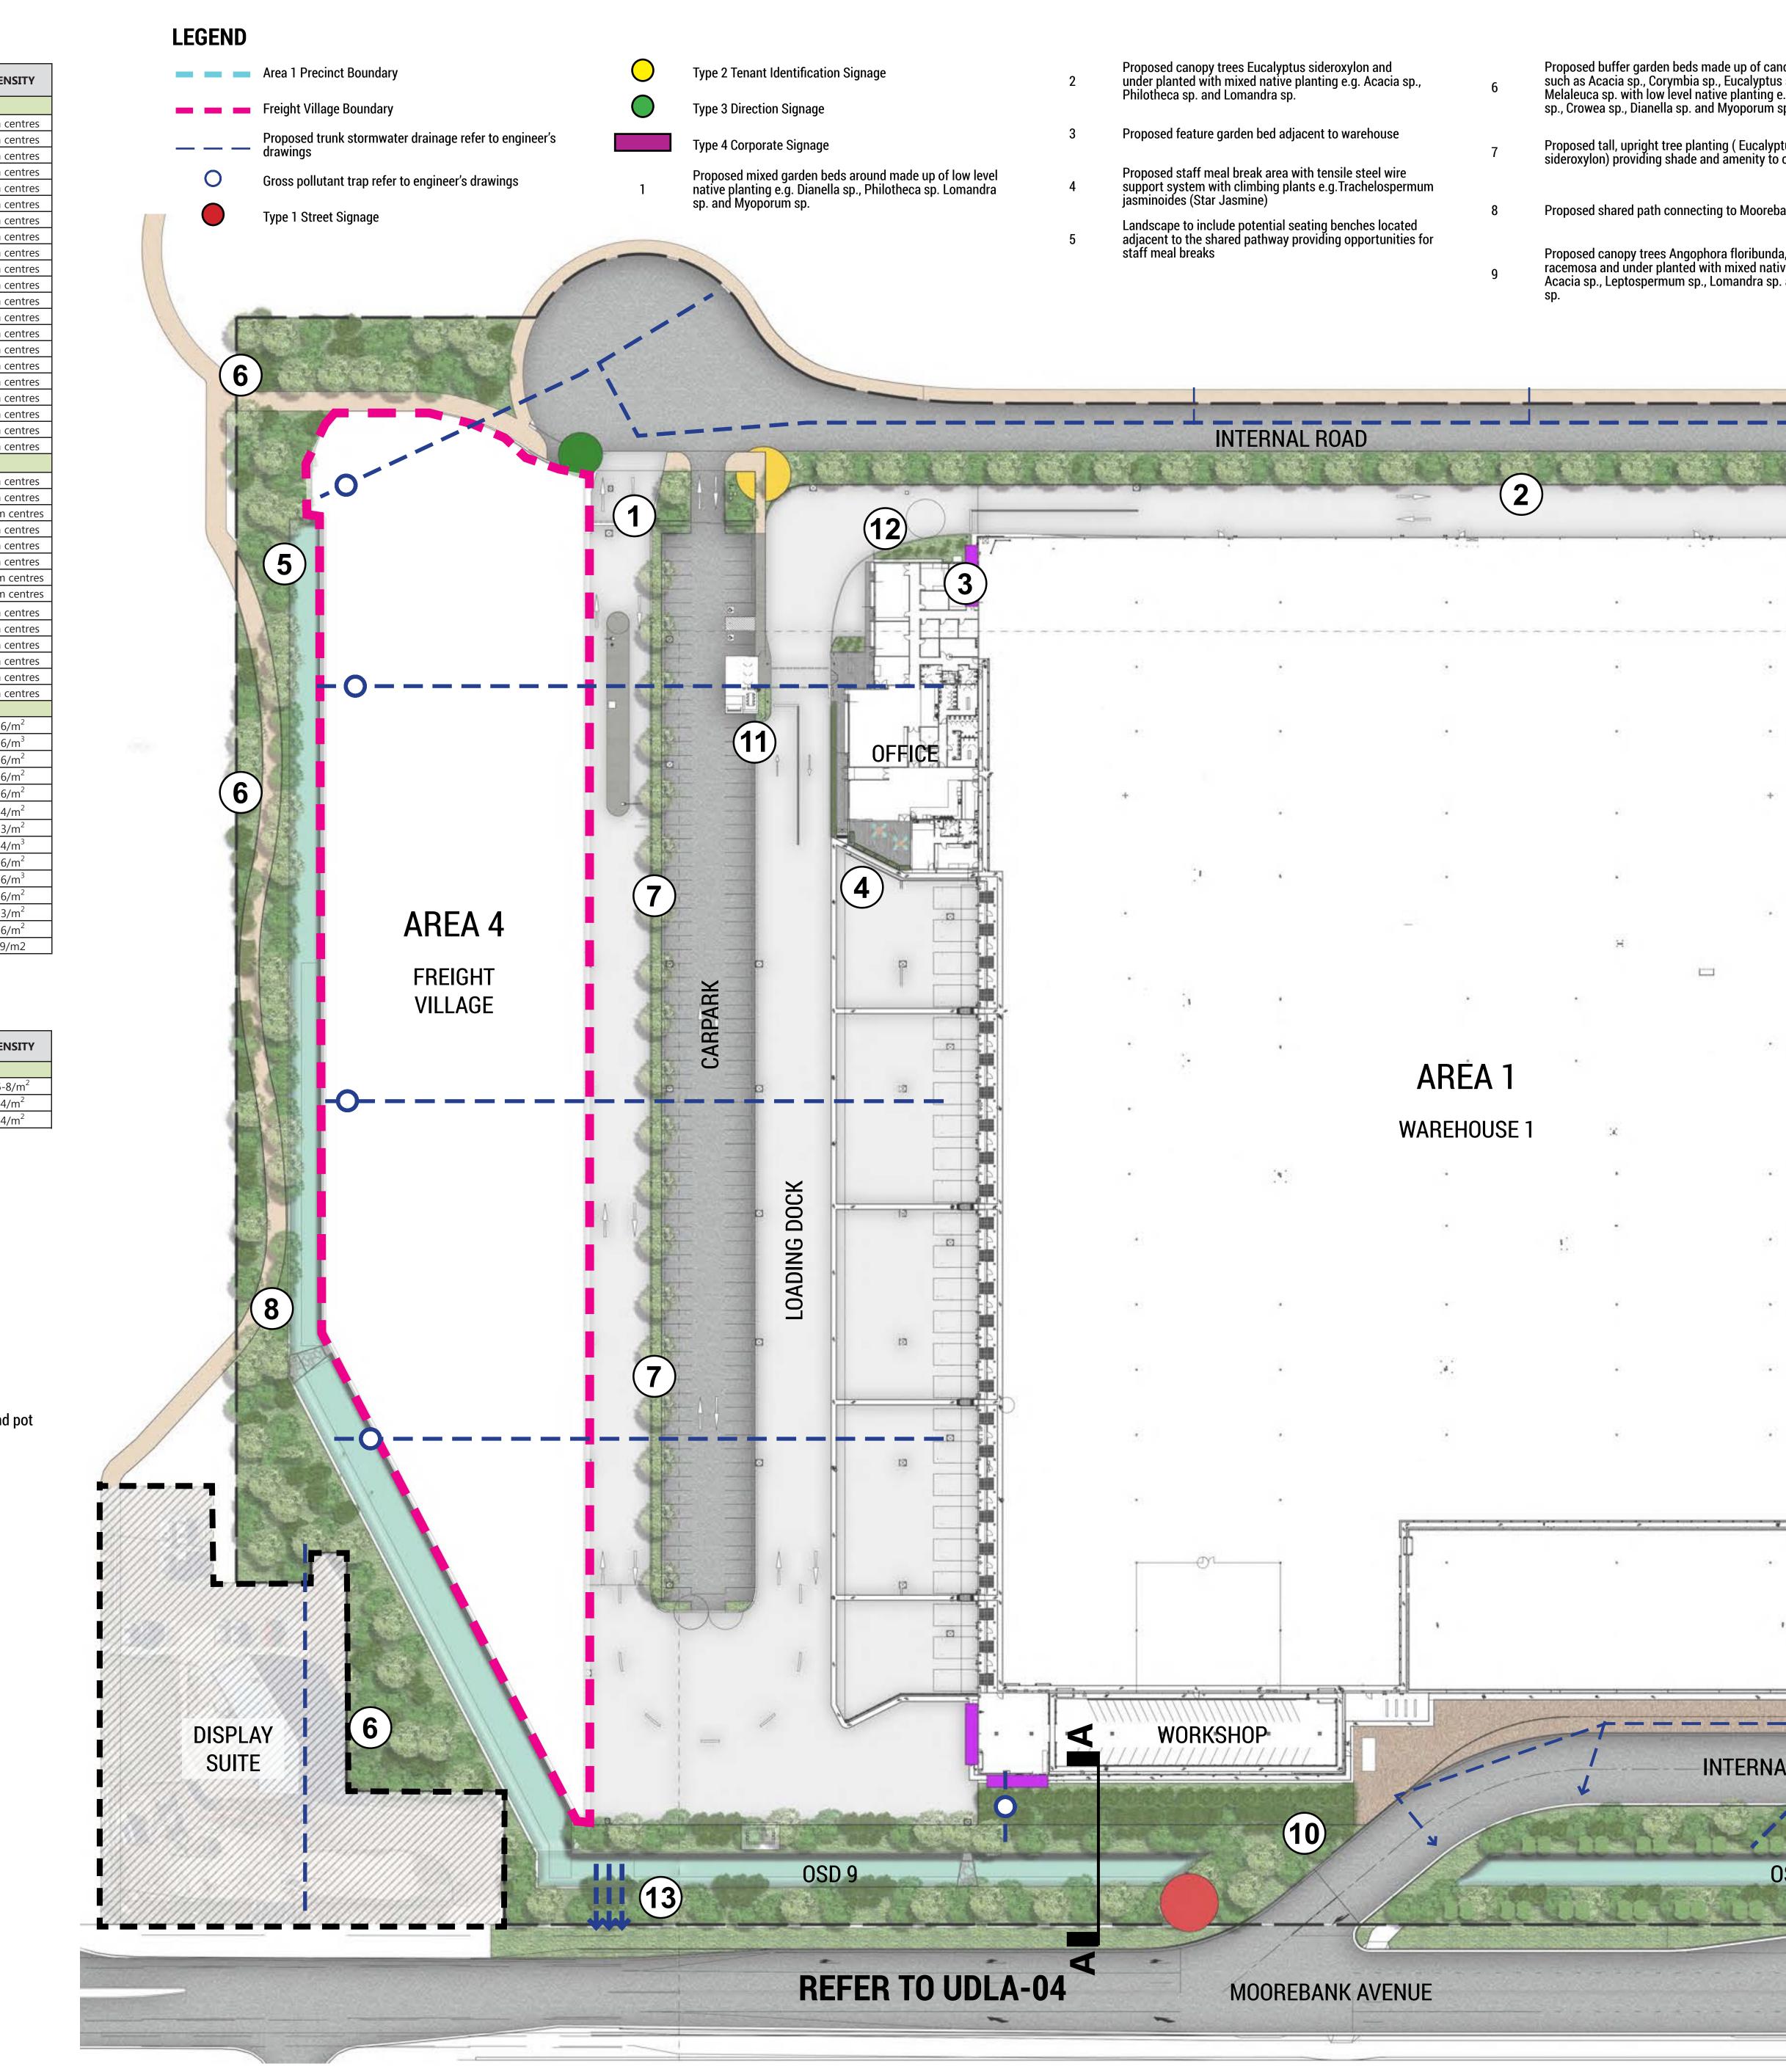

Note

Verify all dimensions on site before commencing work. Report all discrepancies to Land Architect prior to construction. Figured dimensions to be taken in preference to scaled drawings.


All work is to conform to relevant Australian standards and other codes as applicable. Location of underground services to be proven on site and protected if necessary prior construction. Dial before you dig. Plant species and quantities shown are indicative only and are subject to change based of future project requirements.

Proposed canopy trees Eucalyptus sideroxylon and under planted with mixed native planting e.g. Acacia sp., Philotheca sp. and Lomandra sp.
Proposed feature garden bed adjacent to warehouse
Proposed staff meal break area with tensile steel wire support system with climbing plants e.g. Trachelospermun jasminoides (Star Jasmine)
Landscape to include potential seating benches located

Proposed buffer garden beds made up of car such as Acacia sp., Corymbia sp., Eucalyptus Melaleuca sp. with low level native planting sp., Crowea sp., Dianella sp. and Myoporum

	Issue	Date	Description Drawn	Checked	Drawing Title	Date	Job Number	Drawn	Checked	Drawing Number
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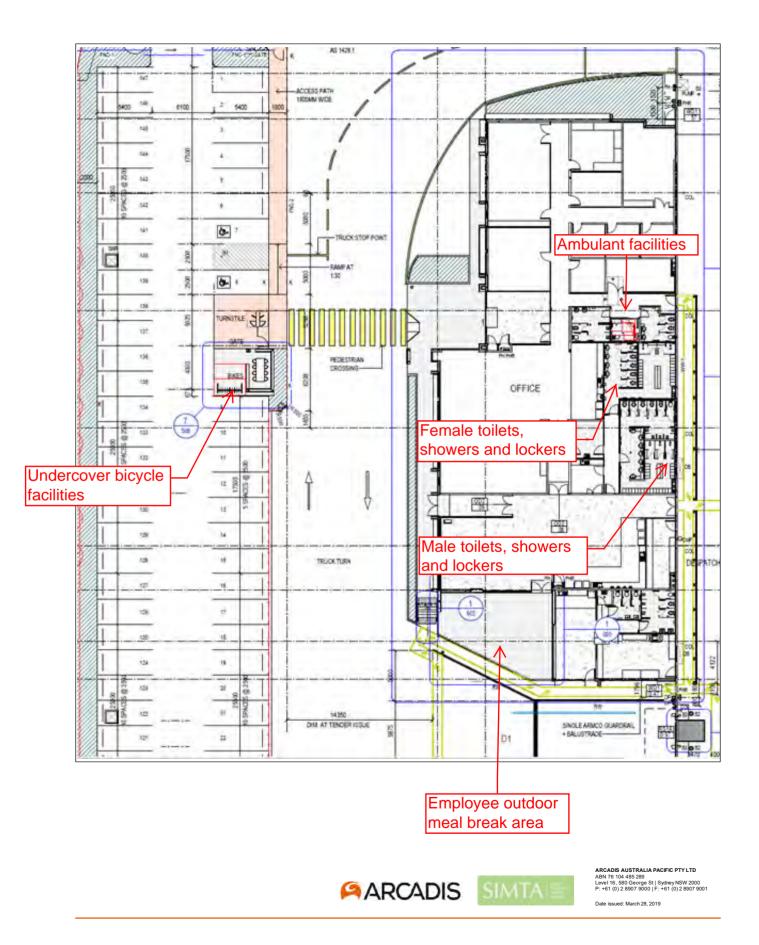


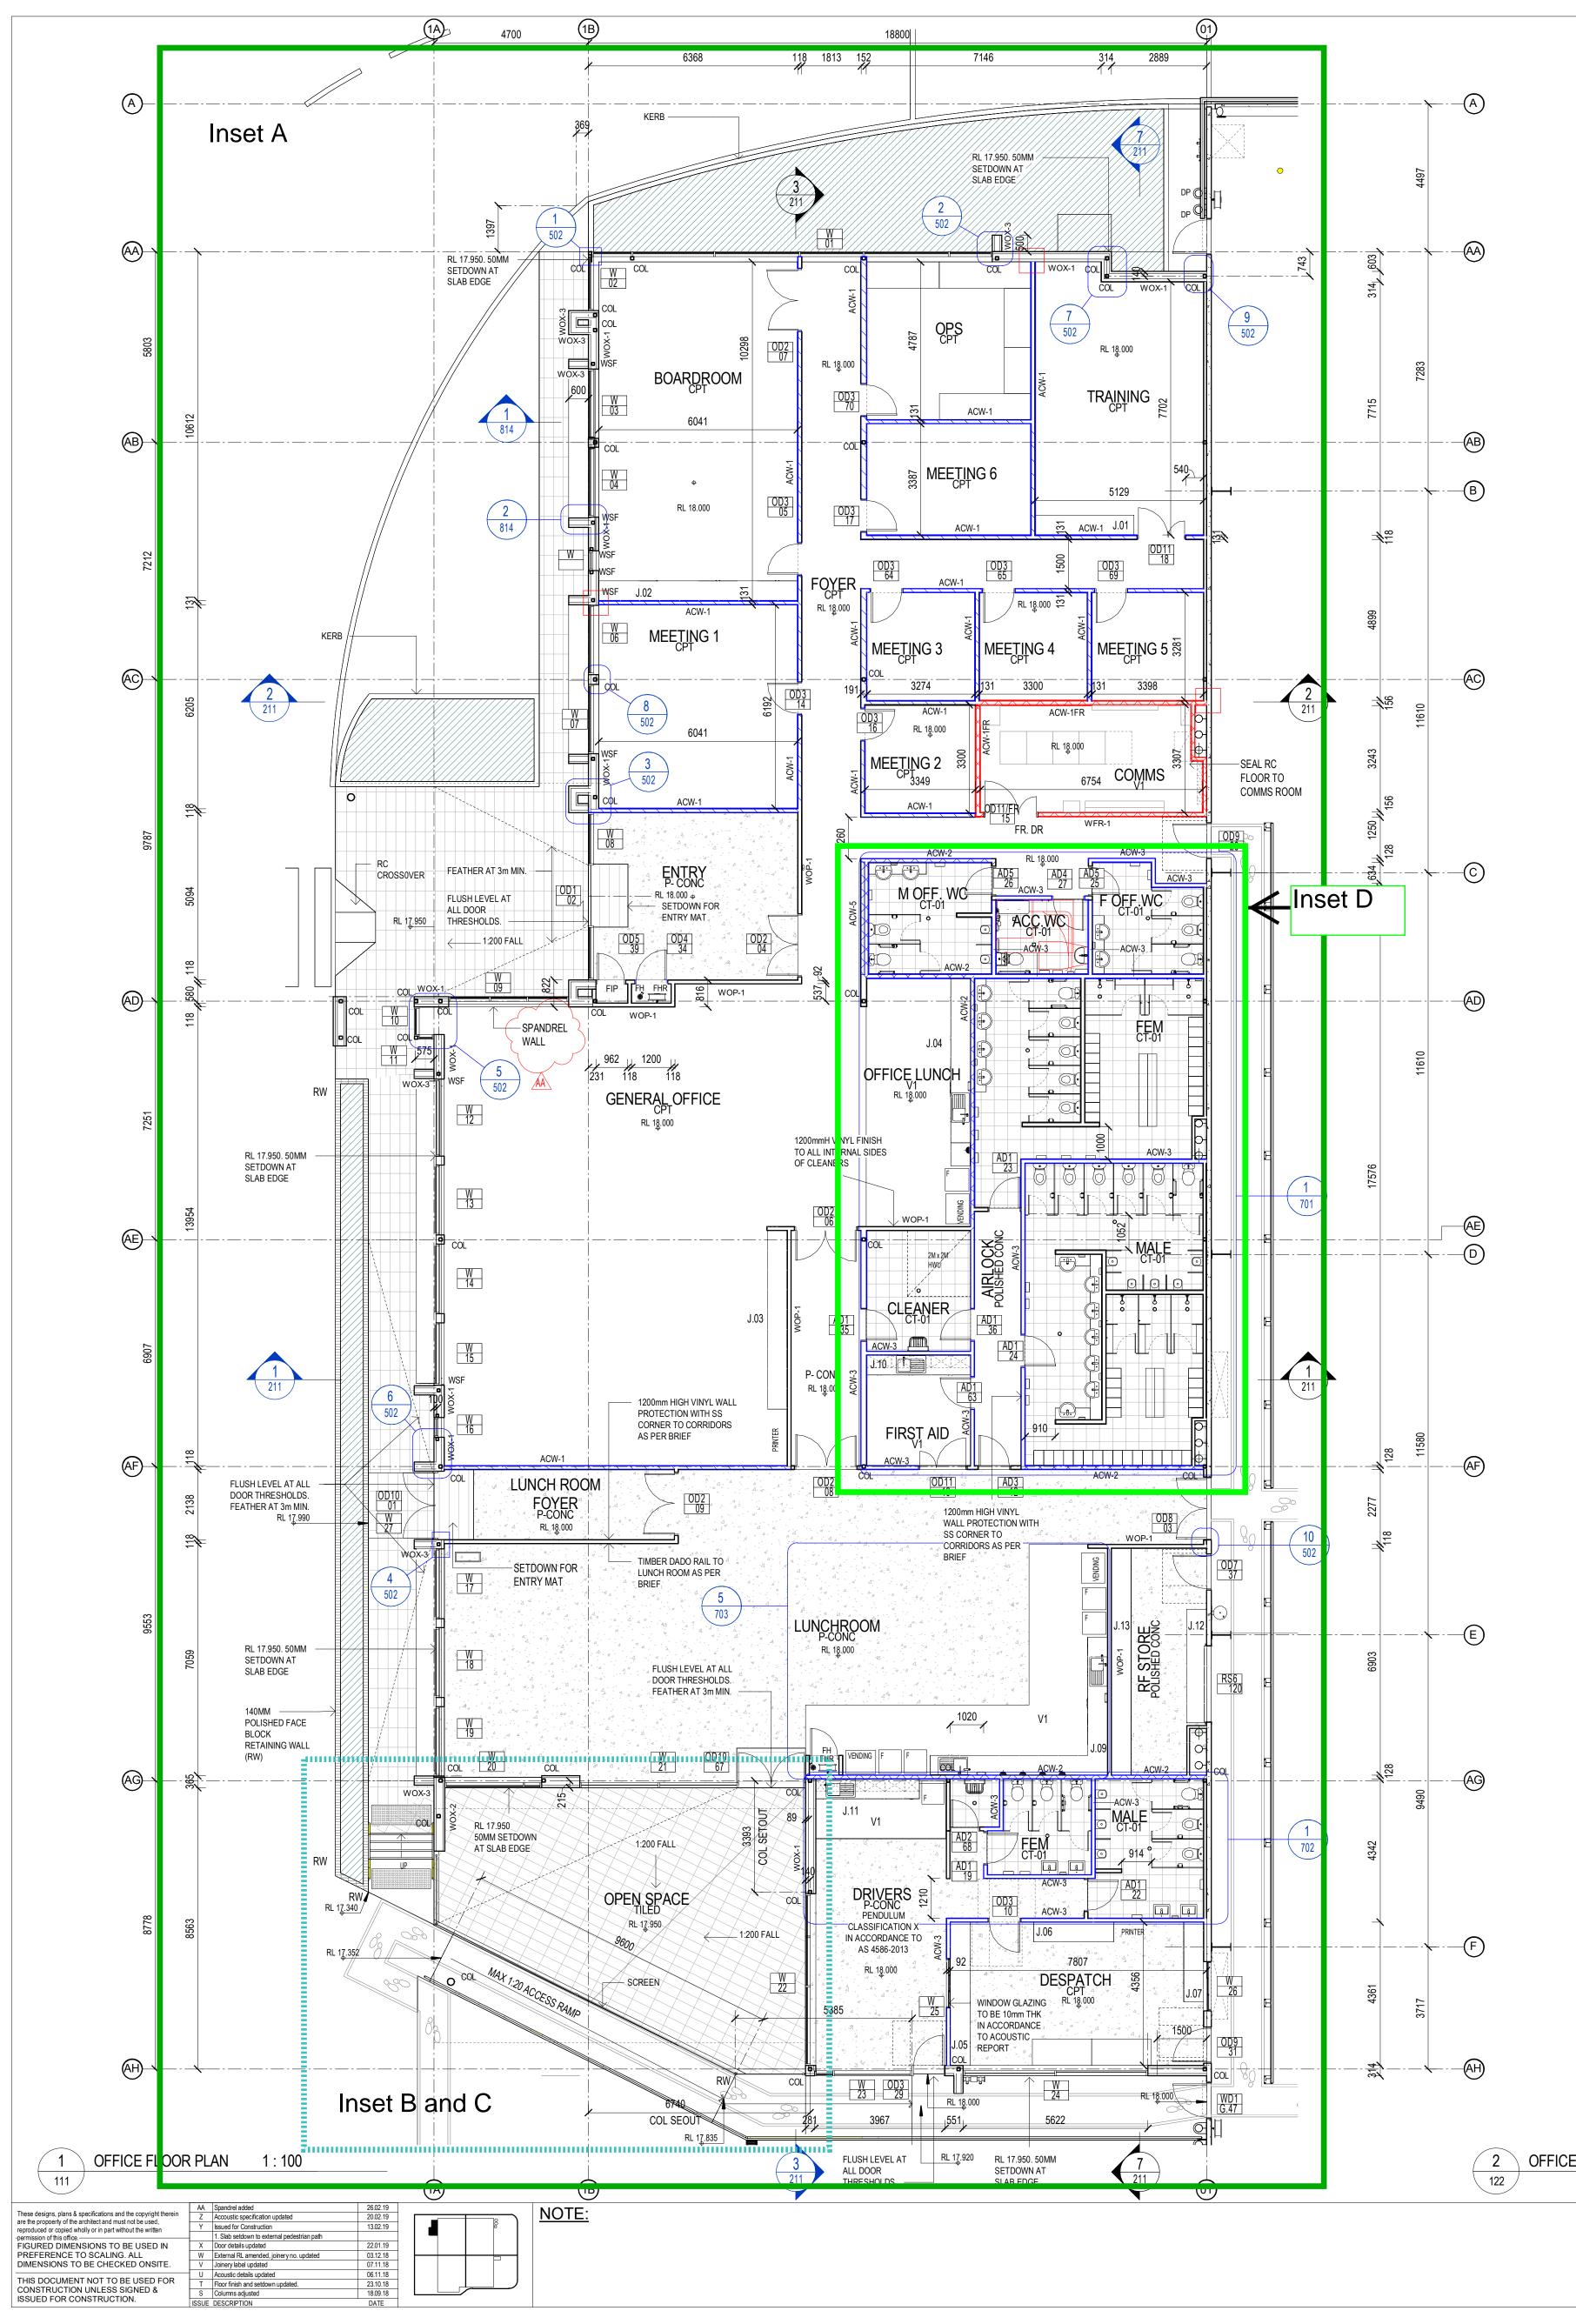

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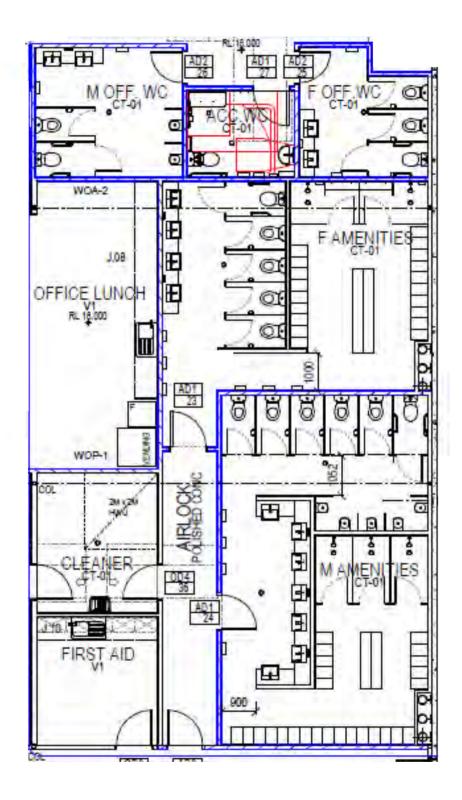
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Refer SBA Architects 17189 GA201-AA - Inset A



Cycling and Pedestrian Access and Facilities Sub Plan

Refer SBA Architects 17189 GA201-AA - Inset D







ARCADIS AUSTRALIA PACIFIC PTY LTD ABN 76 104 485 289 Level 16, 830 George St | Sydney NSW 2000 P: +61 (0) 2 8907 9000 | F: +61 (0) 2 8907 9001 Date issued: March 26, 2019



Appendix 2 – Area 2 Cycle and Pedestrian Access and Facilities Drawings and Figures

ON-SITE DETENTION BASIN 1 (OSD 1) LANDSCAPE MASTERPLAN

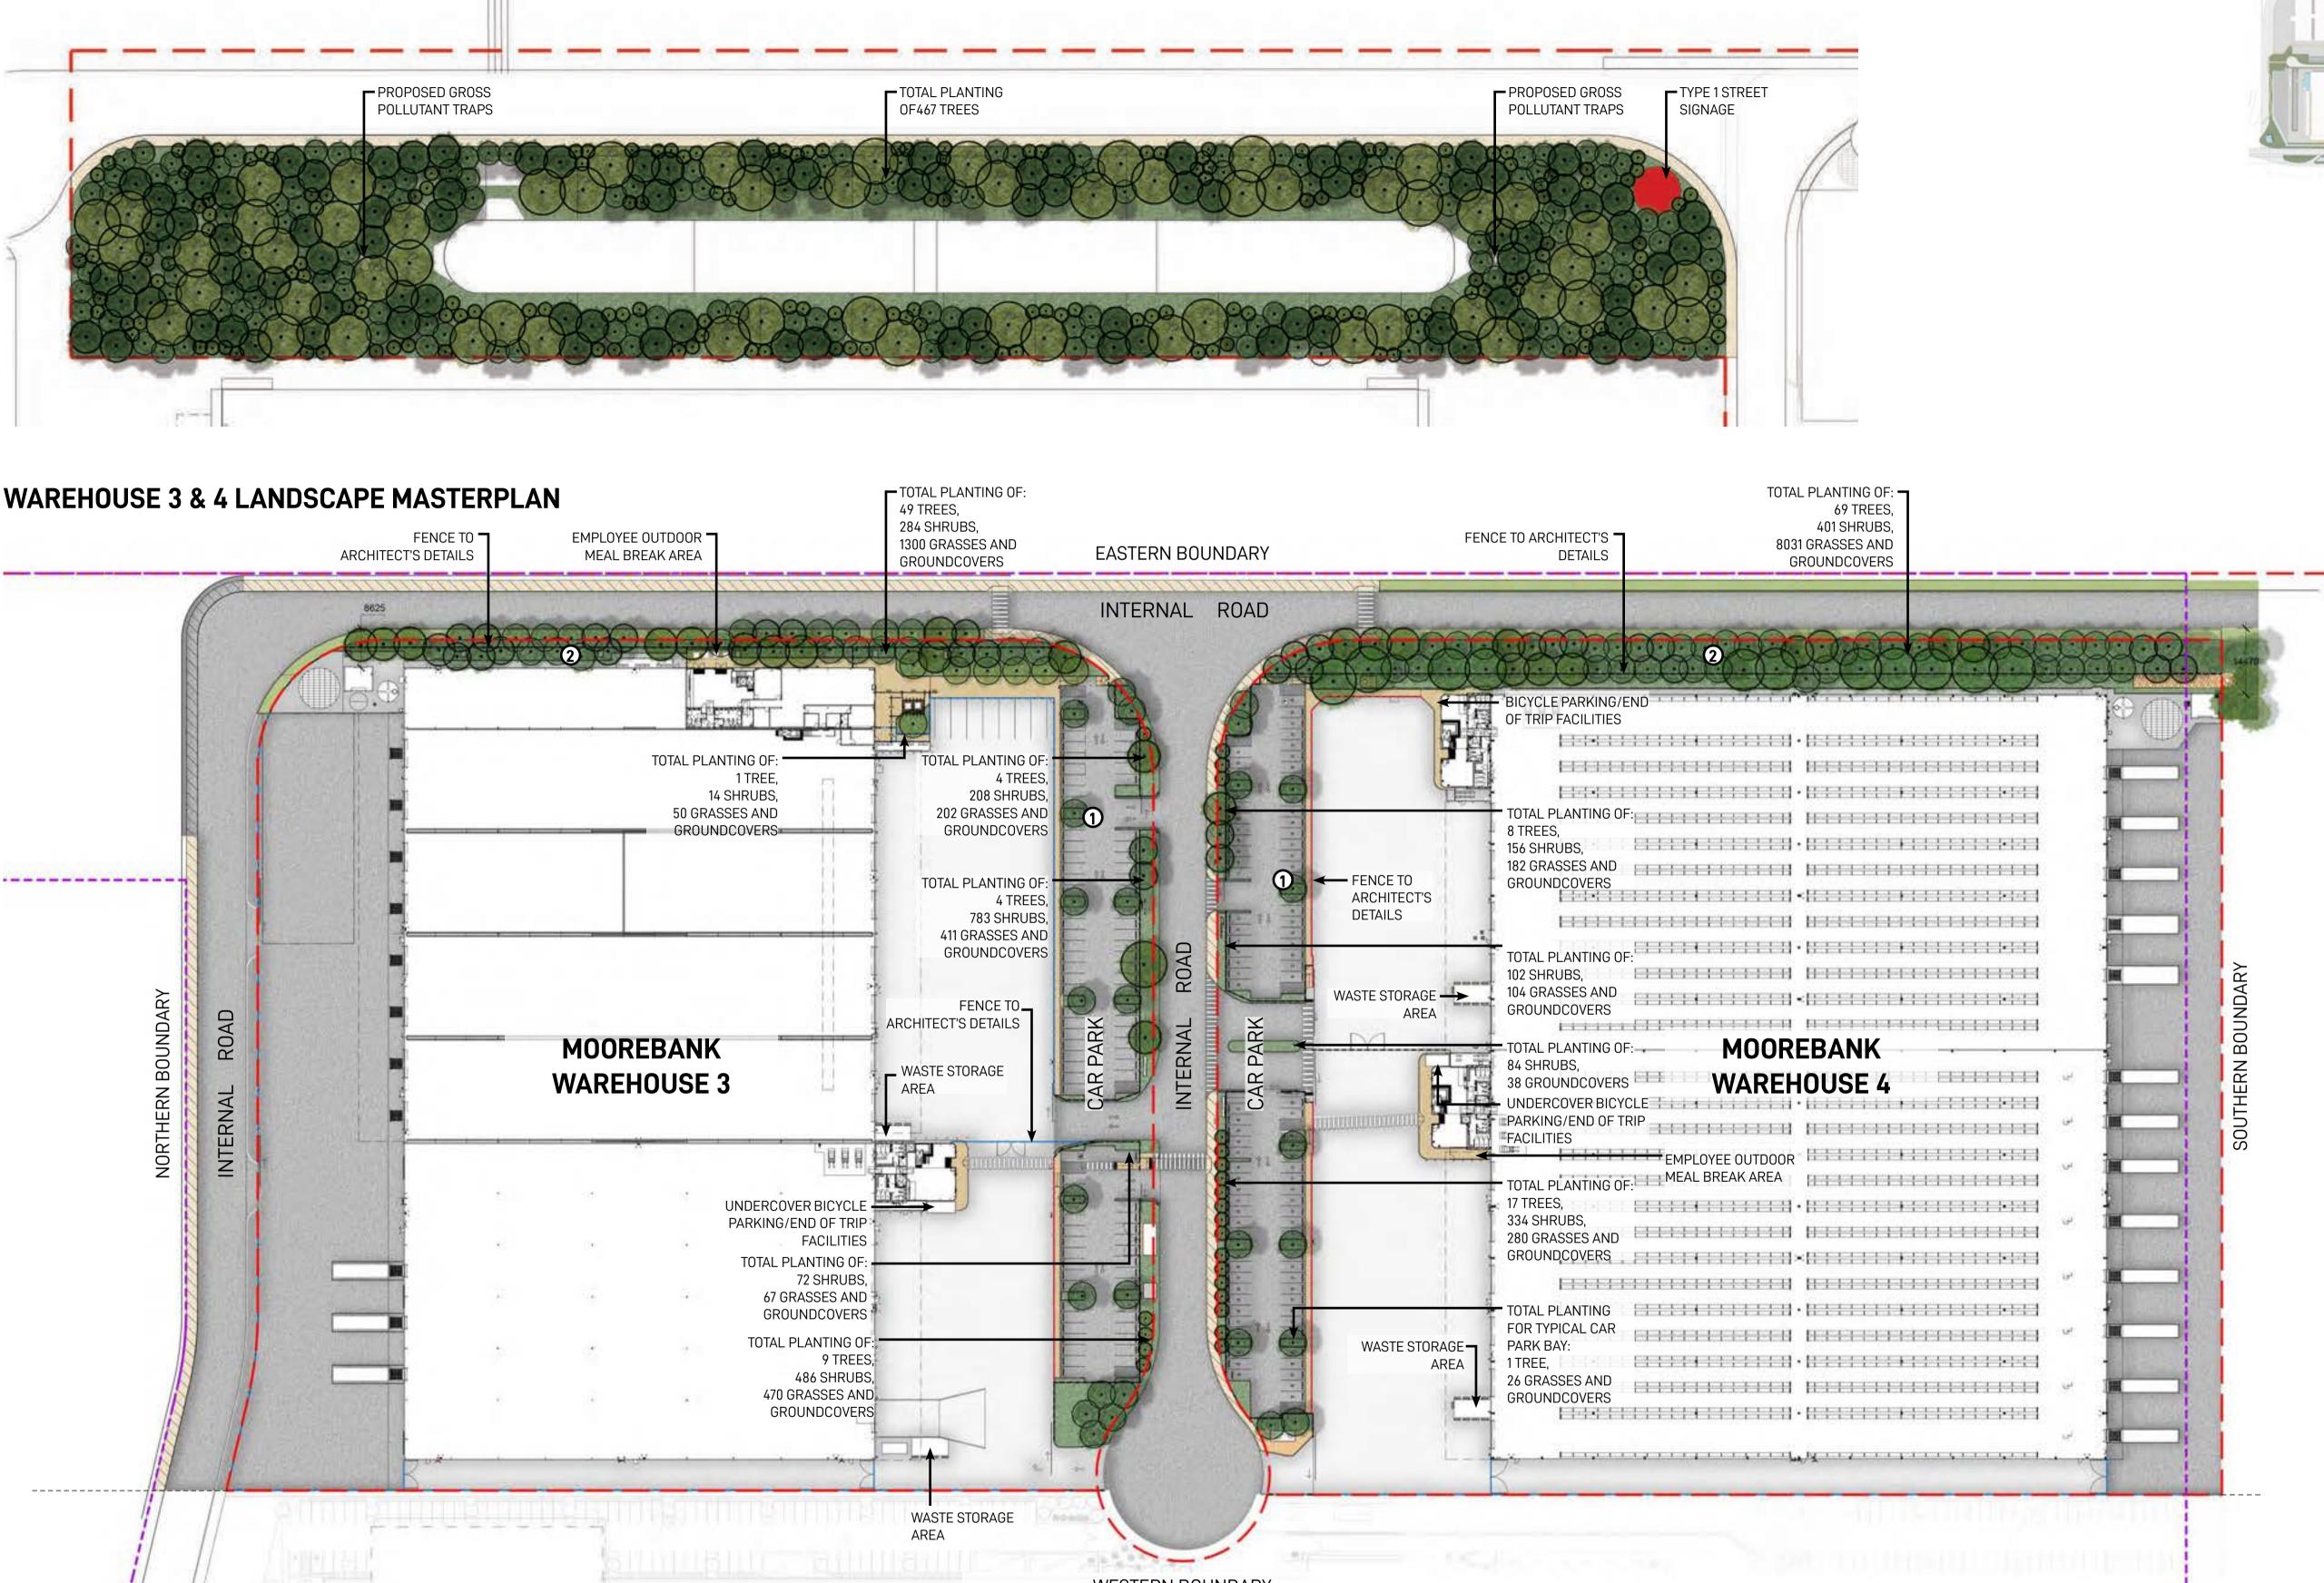

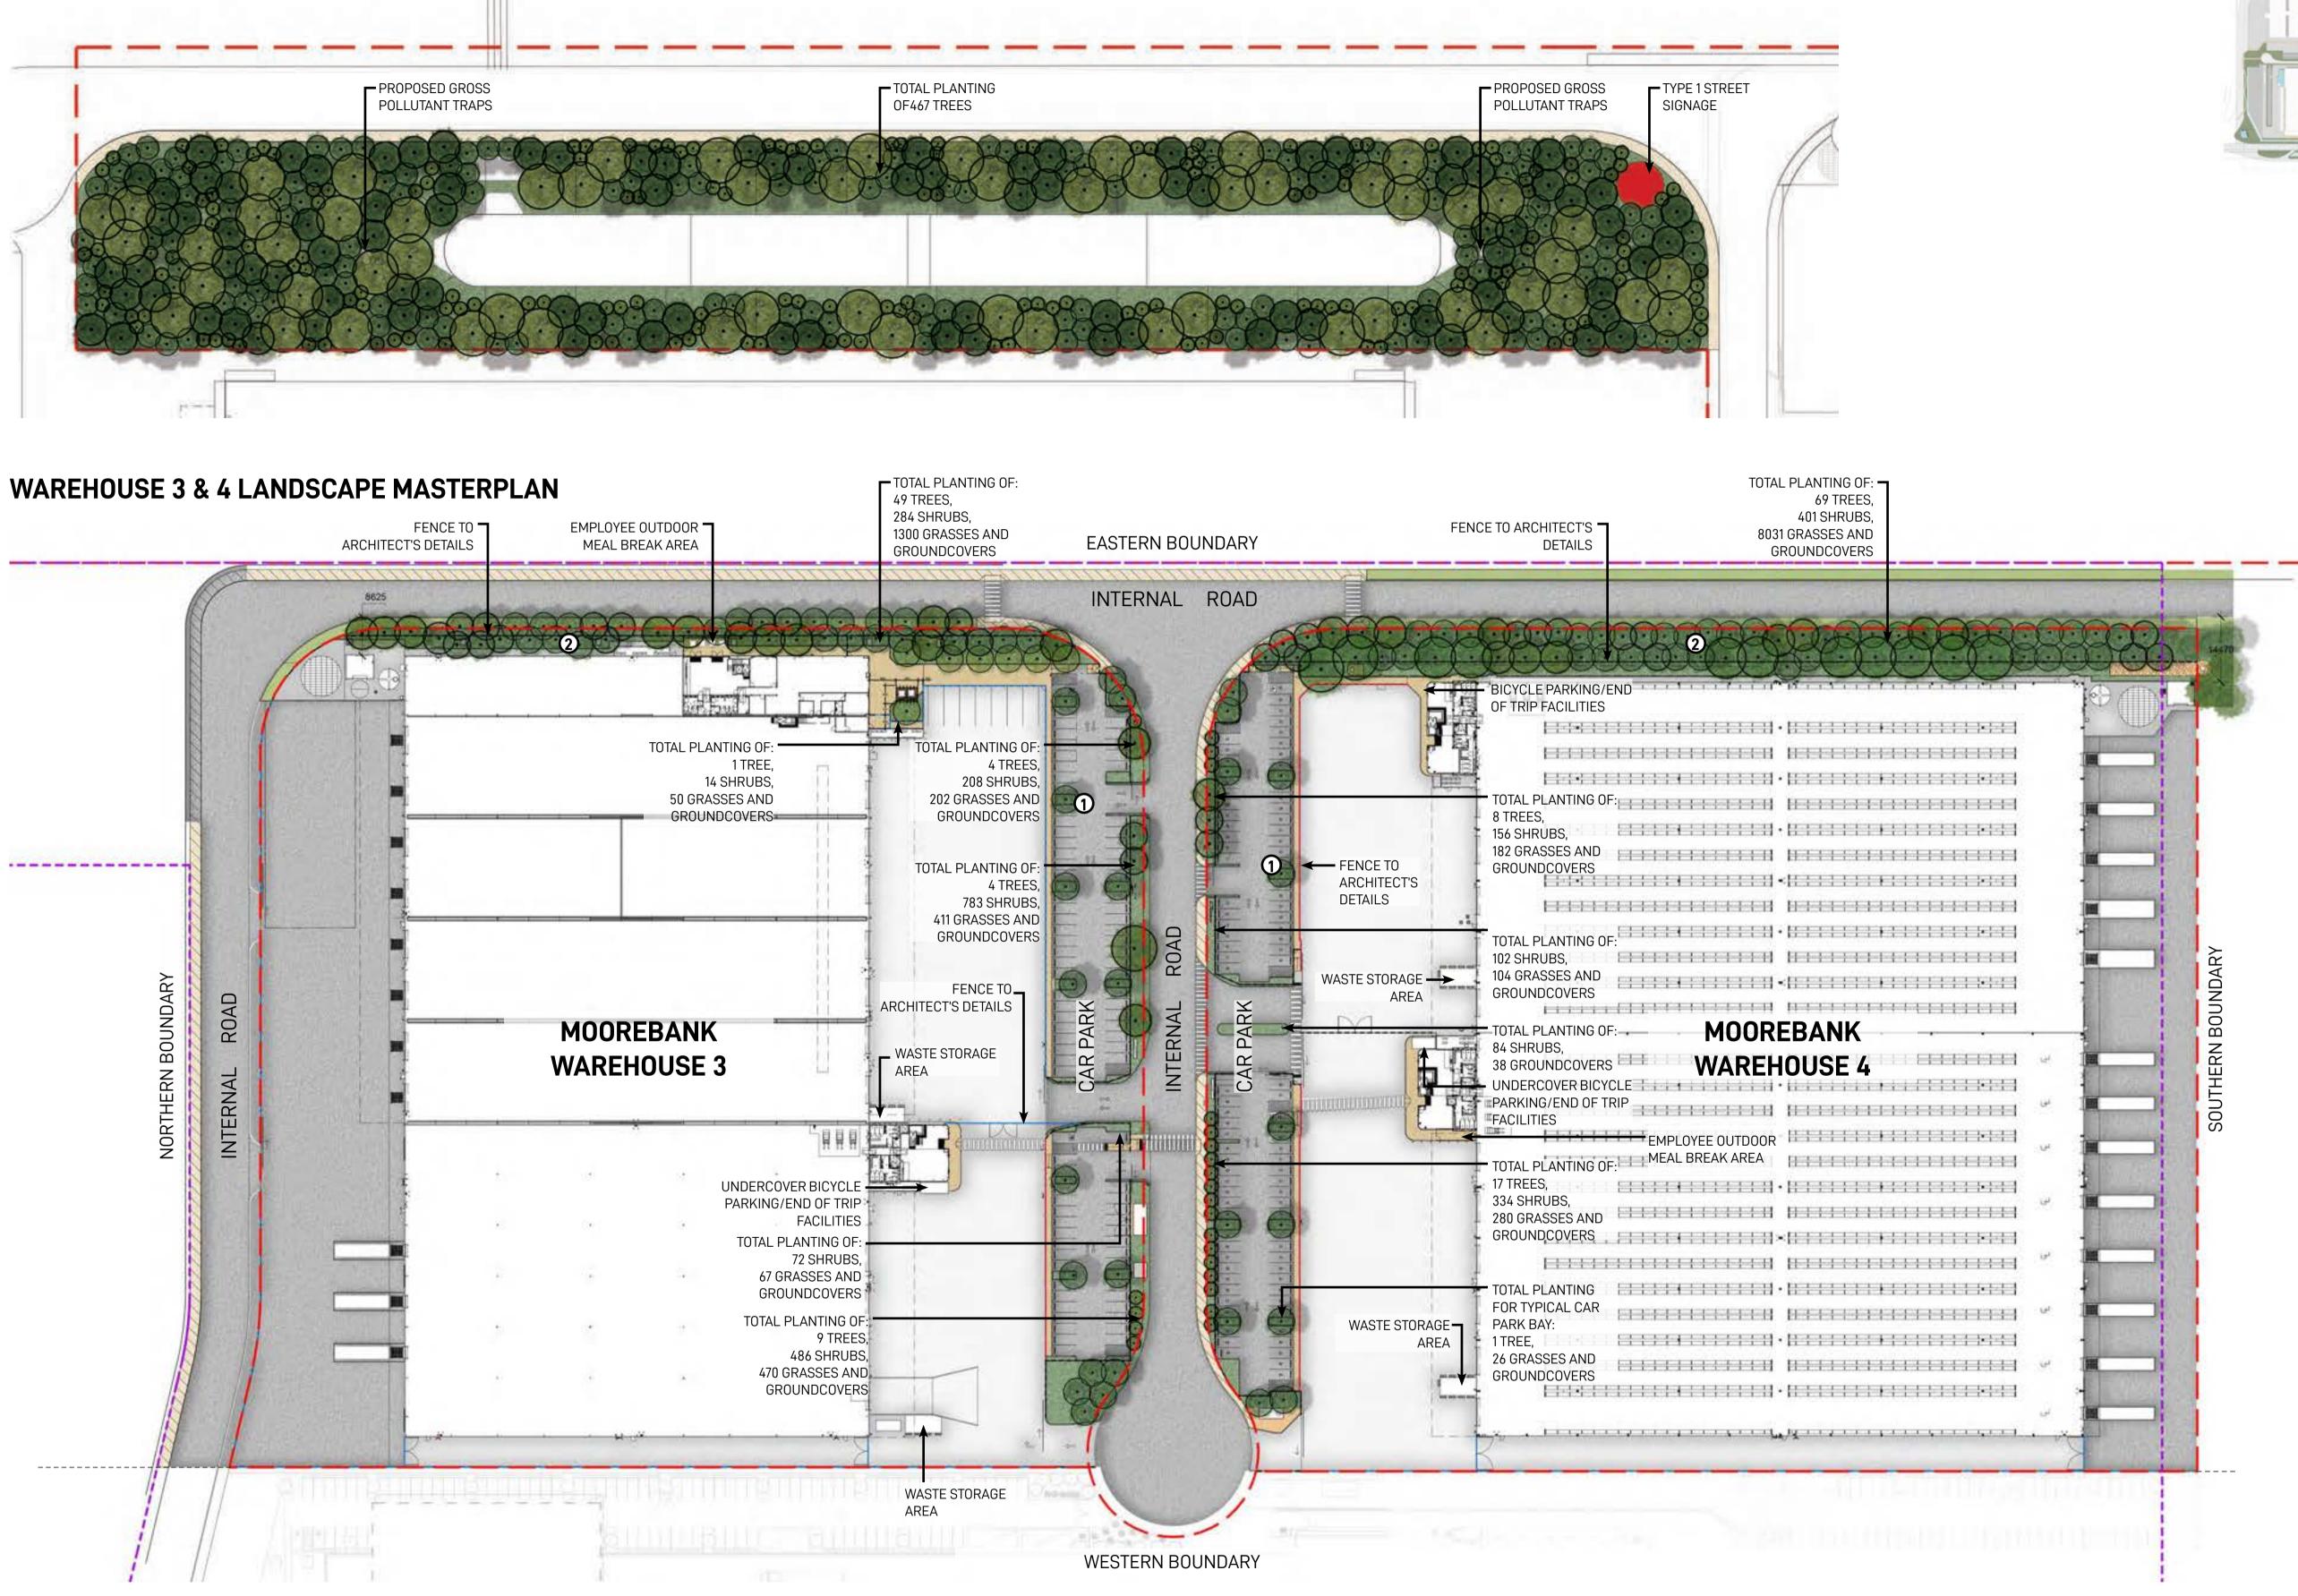




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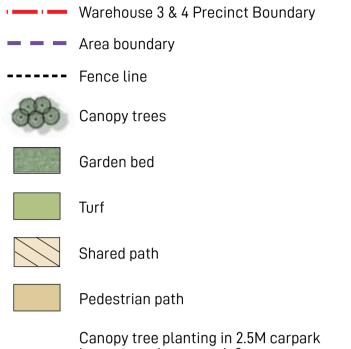
Landscape Architect

	Note	Issue	Date	Description	Drawn	Checked	Drawing Title
		6	26.11.19	Issue for coordination			5
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CP)	All work is to conform to relevant Australian standards and other codes as applicable.	9	13.02.20	Issue for coordination			
(CP)	Location of underground services to be proven on site and protected if necessary prior to construction. Dial before you dig.	10	21.02.20	Issue for coordination			LANDSCAF
		11	28.02.20	Issue for coordination			
02) 9770 7600	Plant species and quantities shown are indicative only and are subject to change based on future project requirements.	12	05.08.20	Issue for coordination			
en.com.au/		13	16.12.20	Issue for coordination			

KEY PLAN



LEGEND

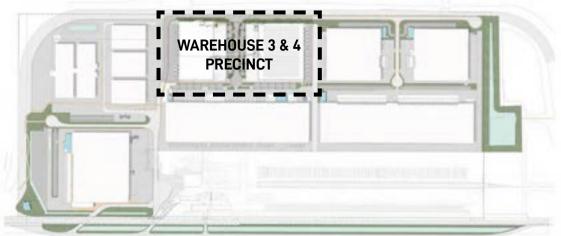

bays spaced at every 6-8 car spaces providing amenity and visual screening of warehousing in accordance with condition b140(e)(iii) & b140(e)(vi)


Mix of native canopy trees and shrubs providing visual mitigation of proposed warehouses

648 trees in 18,114 m^2 = 1 tree/27 m^2

FOR COORDINATION

Job Number Drawn Checked Drawing Number 16-12-20 20190408 KF RL W3W4-GNK-LN-DWG-2001 roiect Warehouses 3 & 4 UDLP Moorebank Logistics Park, Moorebank NSW Scale 1:750 @ A1 Rev 0 5 10 15 20m I I I I I 13

SE 3 & 4 PRECINCT **PE MASTERPLAN**

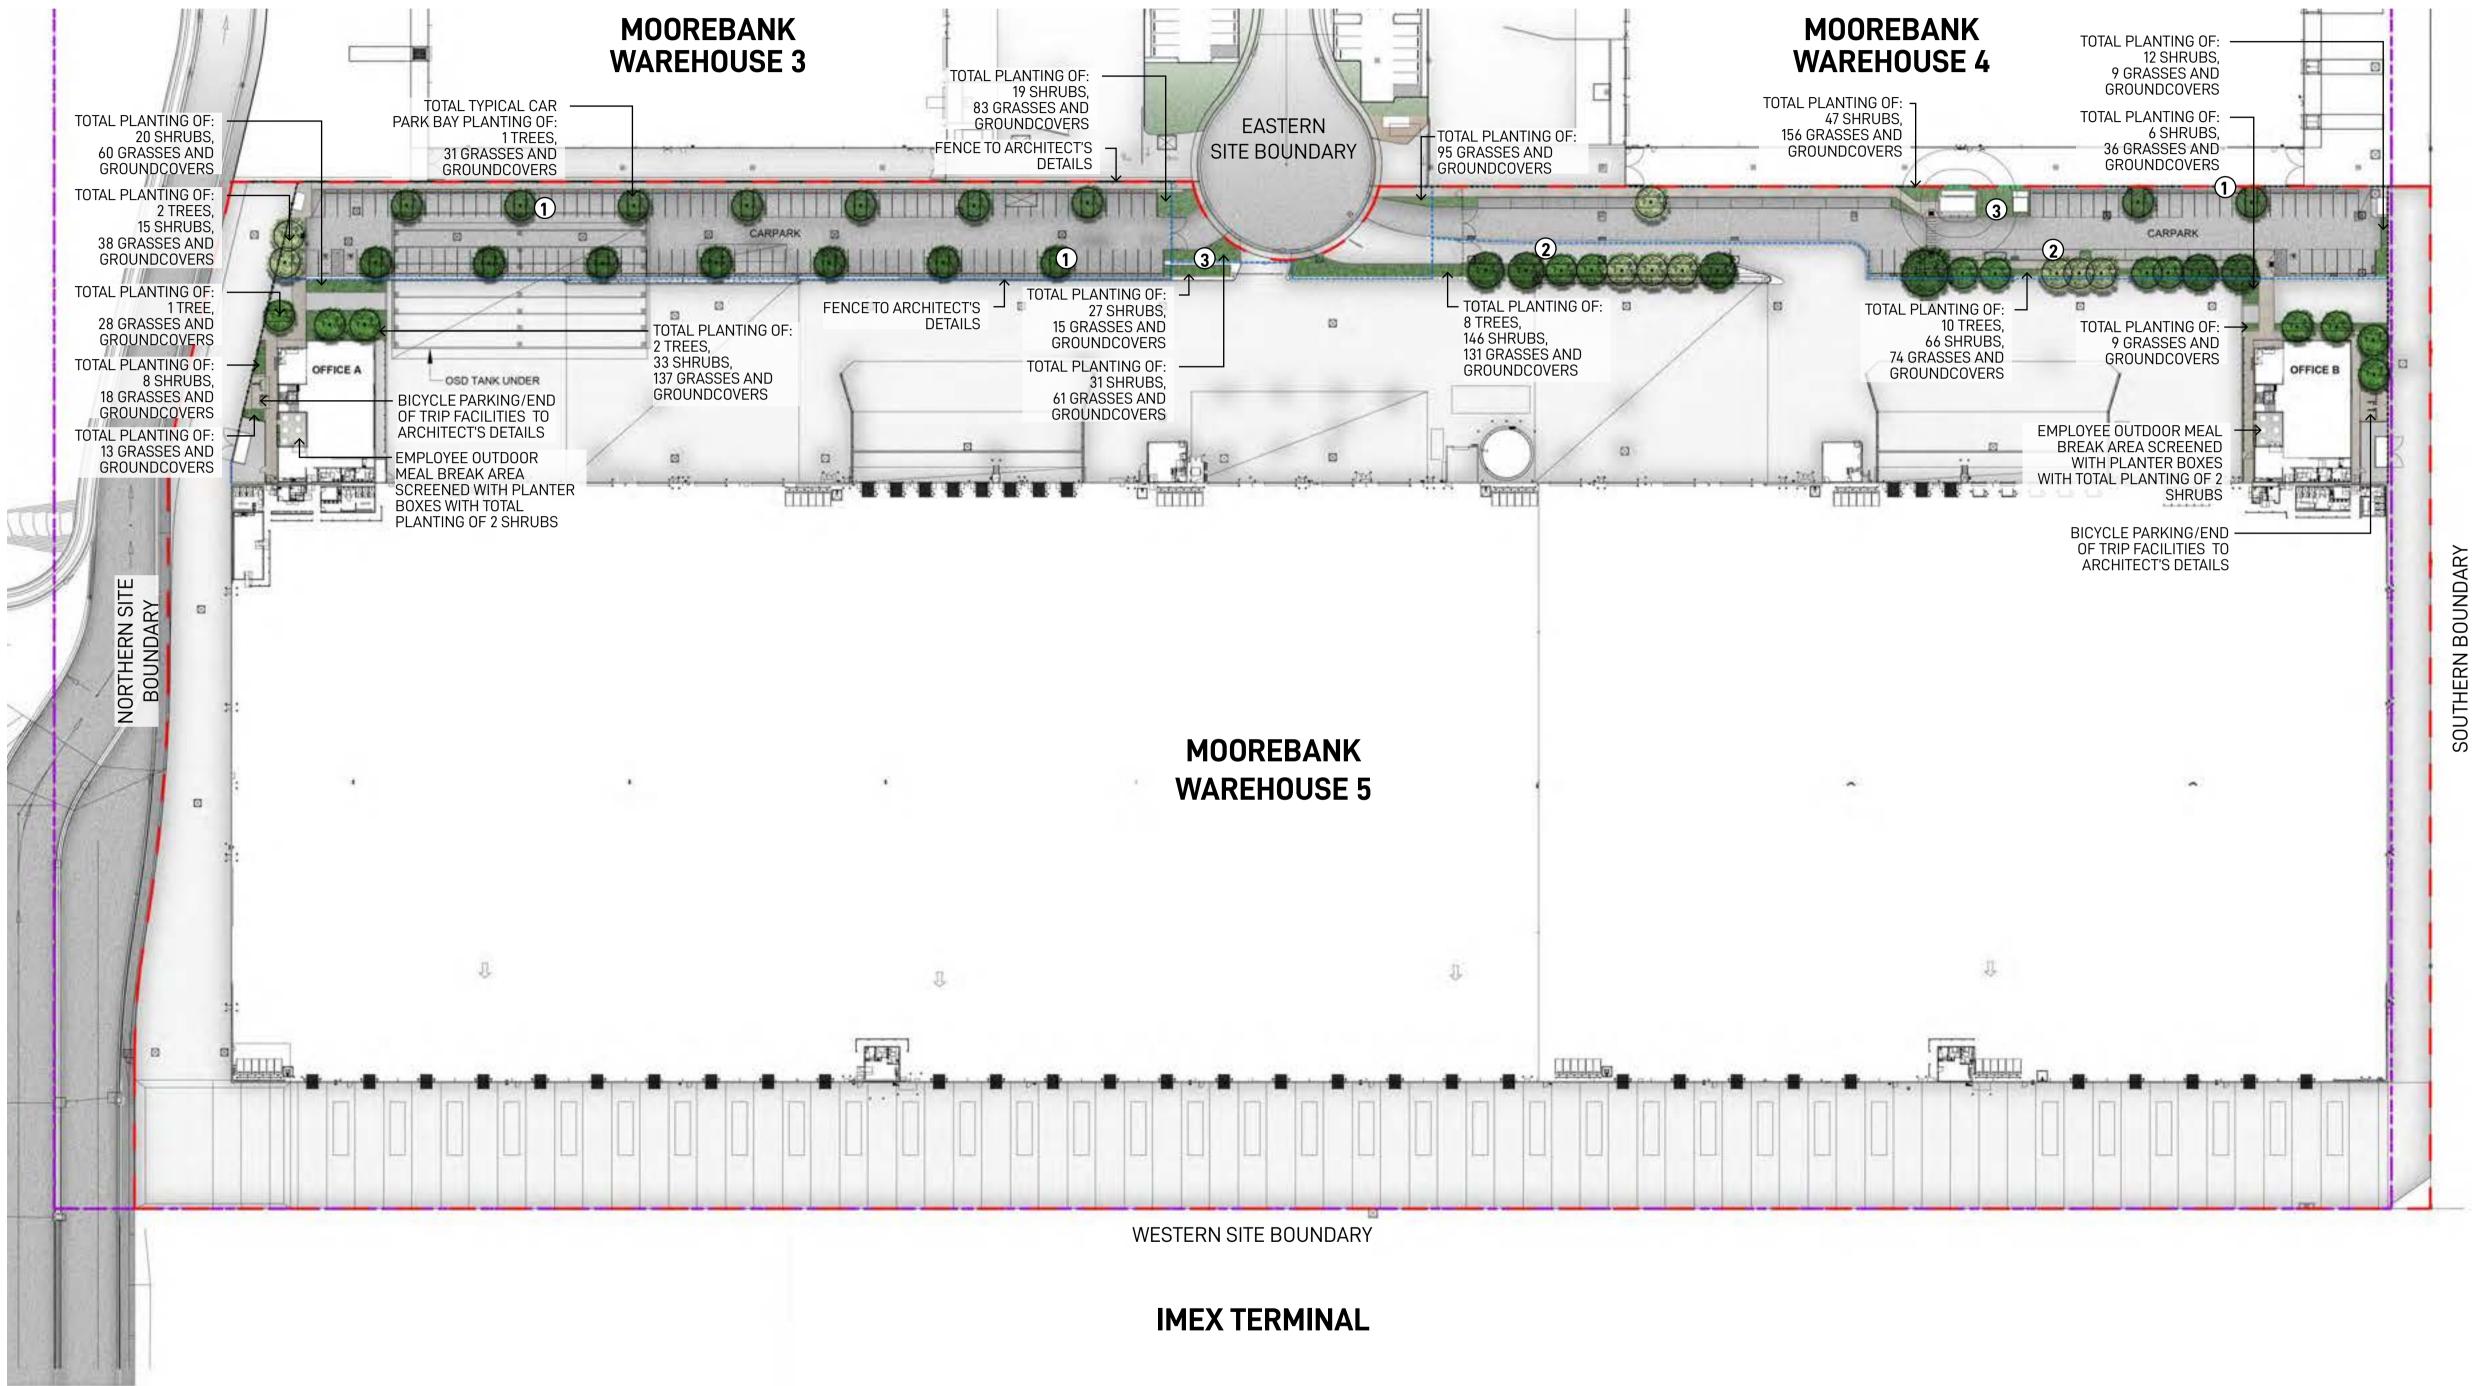





Client

Architect REIDCAMPBELL

Level 15, 124 Walker Street North Sydney NSW 2060, Australia (02) 9954 5011 https://www.reidc mpbell.com/



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KEY PLAN



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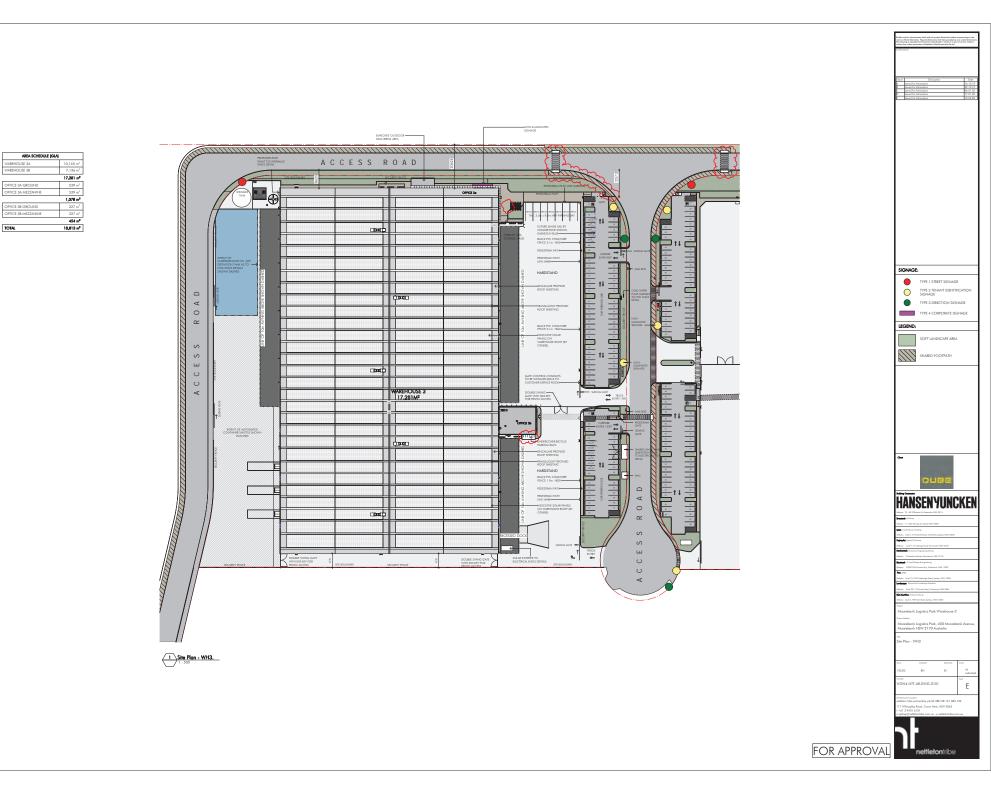
---- Area boundary Fence line \odot Proposed canopy trees Proposed garden bed Hard landscaping


Warehouse 5 Precinct Boundary


- Proposed canopy tree planting in 2.5M carpark bays spaced at every 6-8 car spaces providing amenity and visual screening of proposed warehousing in accordance with condition b140(e)(iii) & b140(e)(vi) 1
- Proposed mix of native canopy trees and shrubs providing visual mitigation of 2 proposed warehouses
- Proposed mix of native shrubs and 3 groundcovers providing visual mitigation and screening of proposed warehouses

48 trees in 1,018m² = 1 tree/21m²


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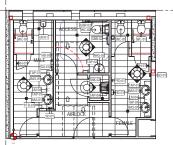



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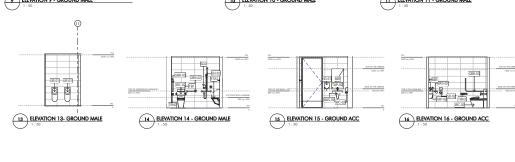
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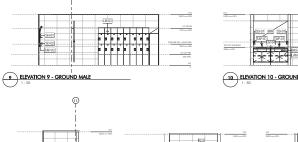

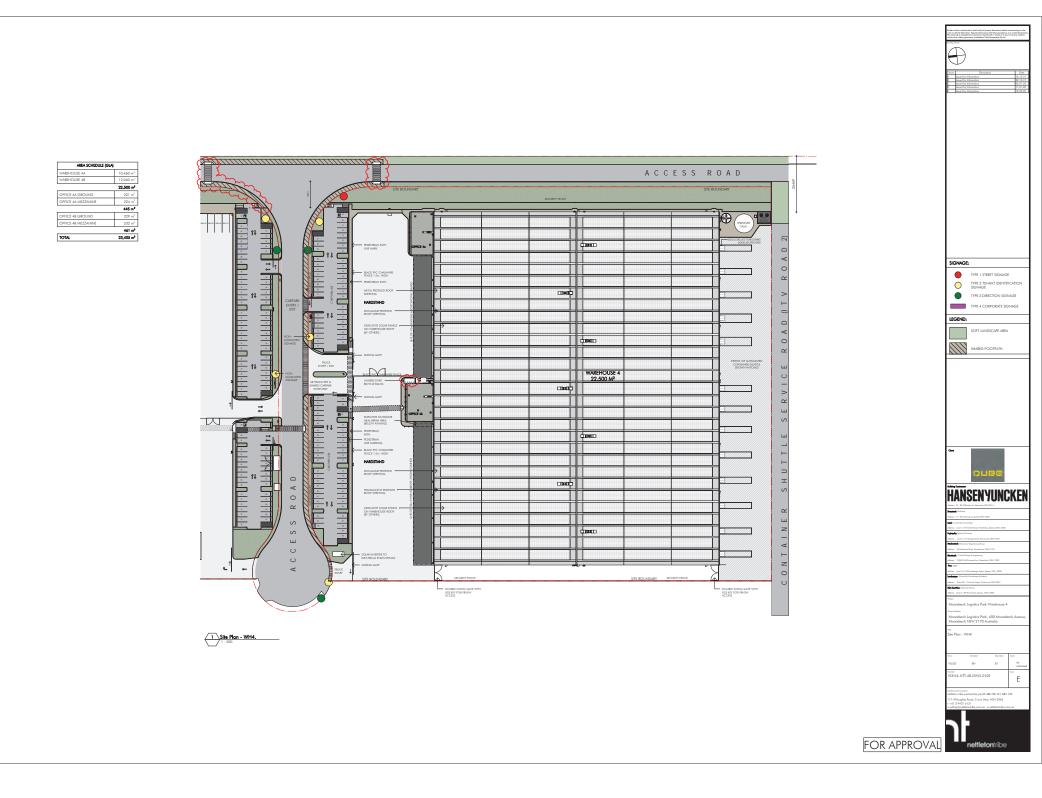
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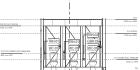
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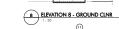
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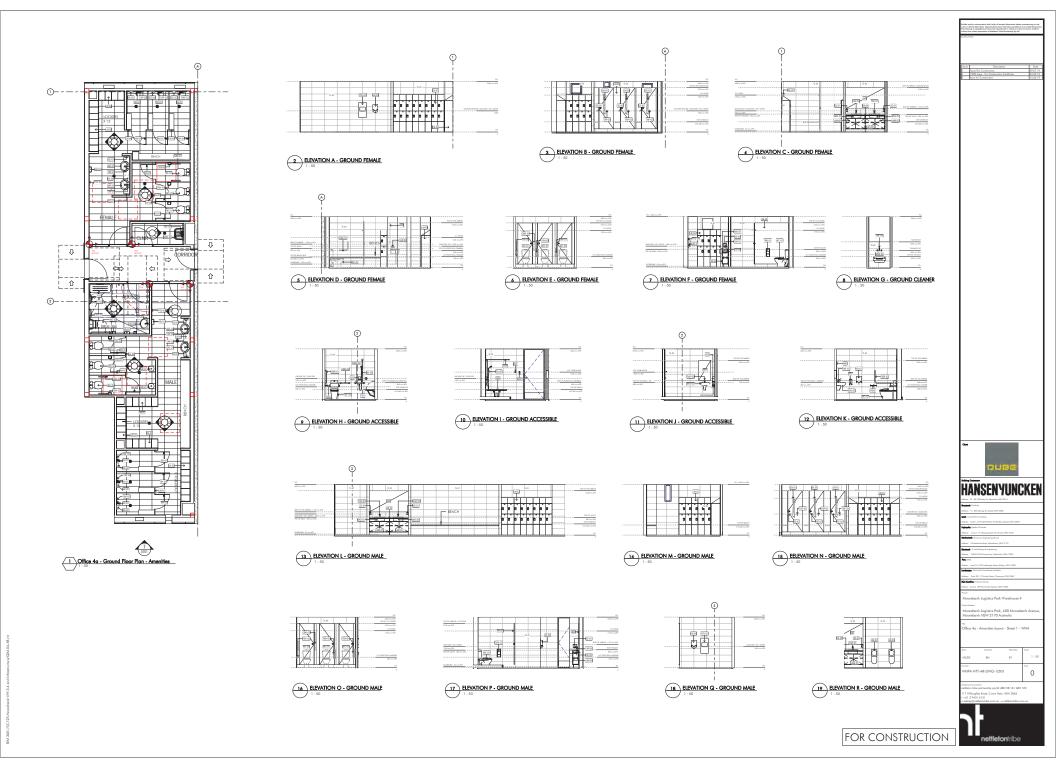
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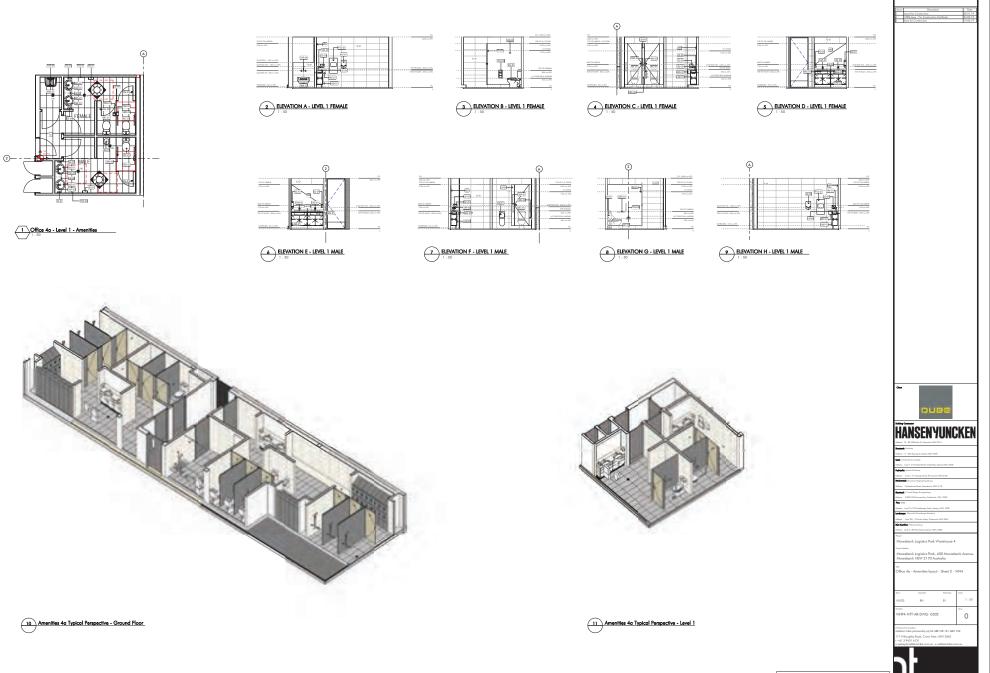
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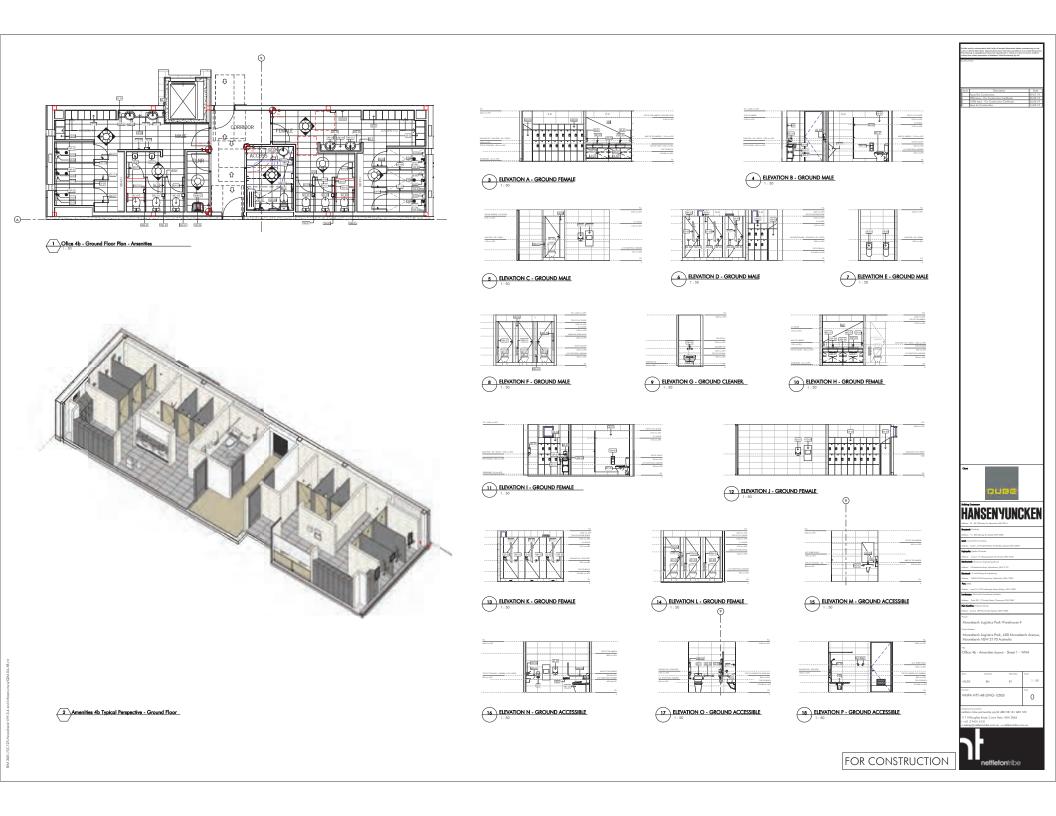
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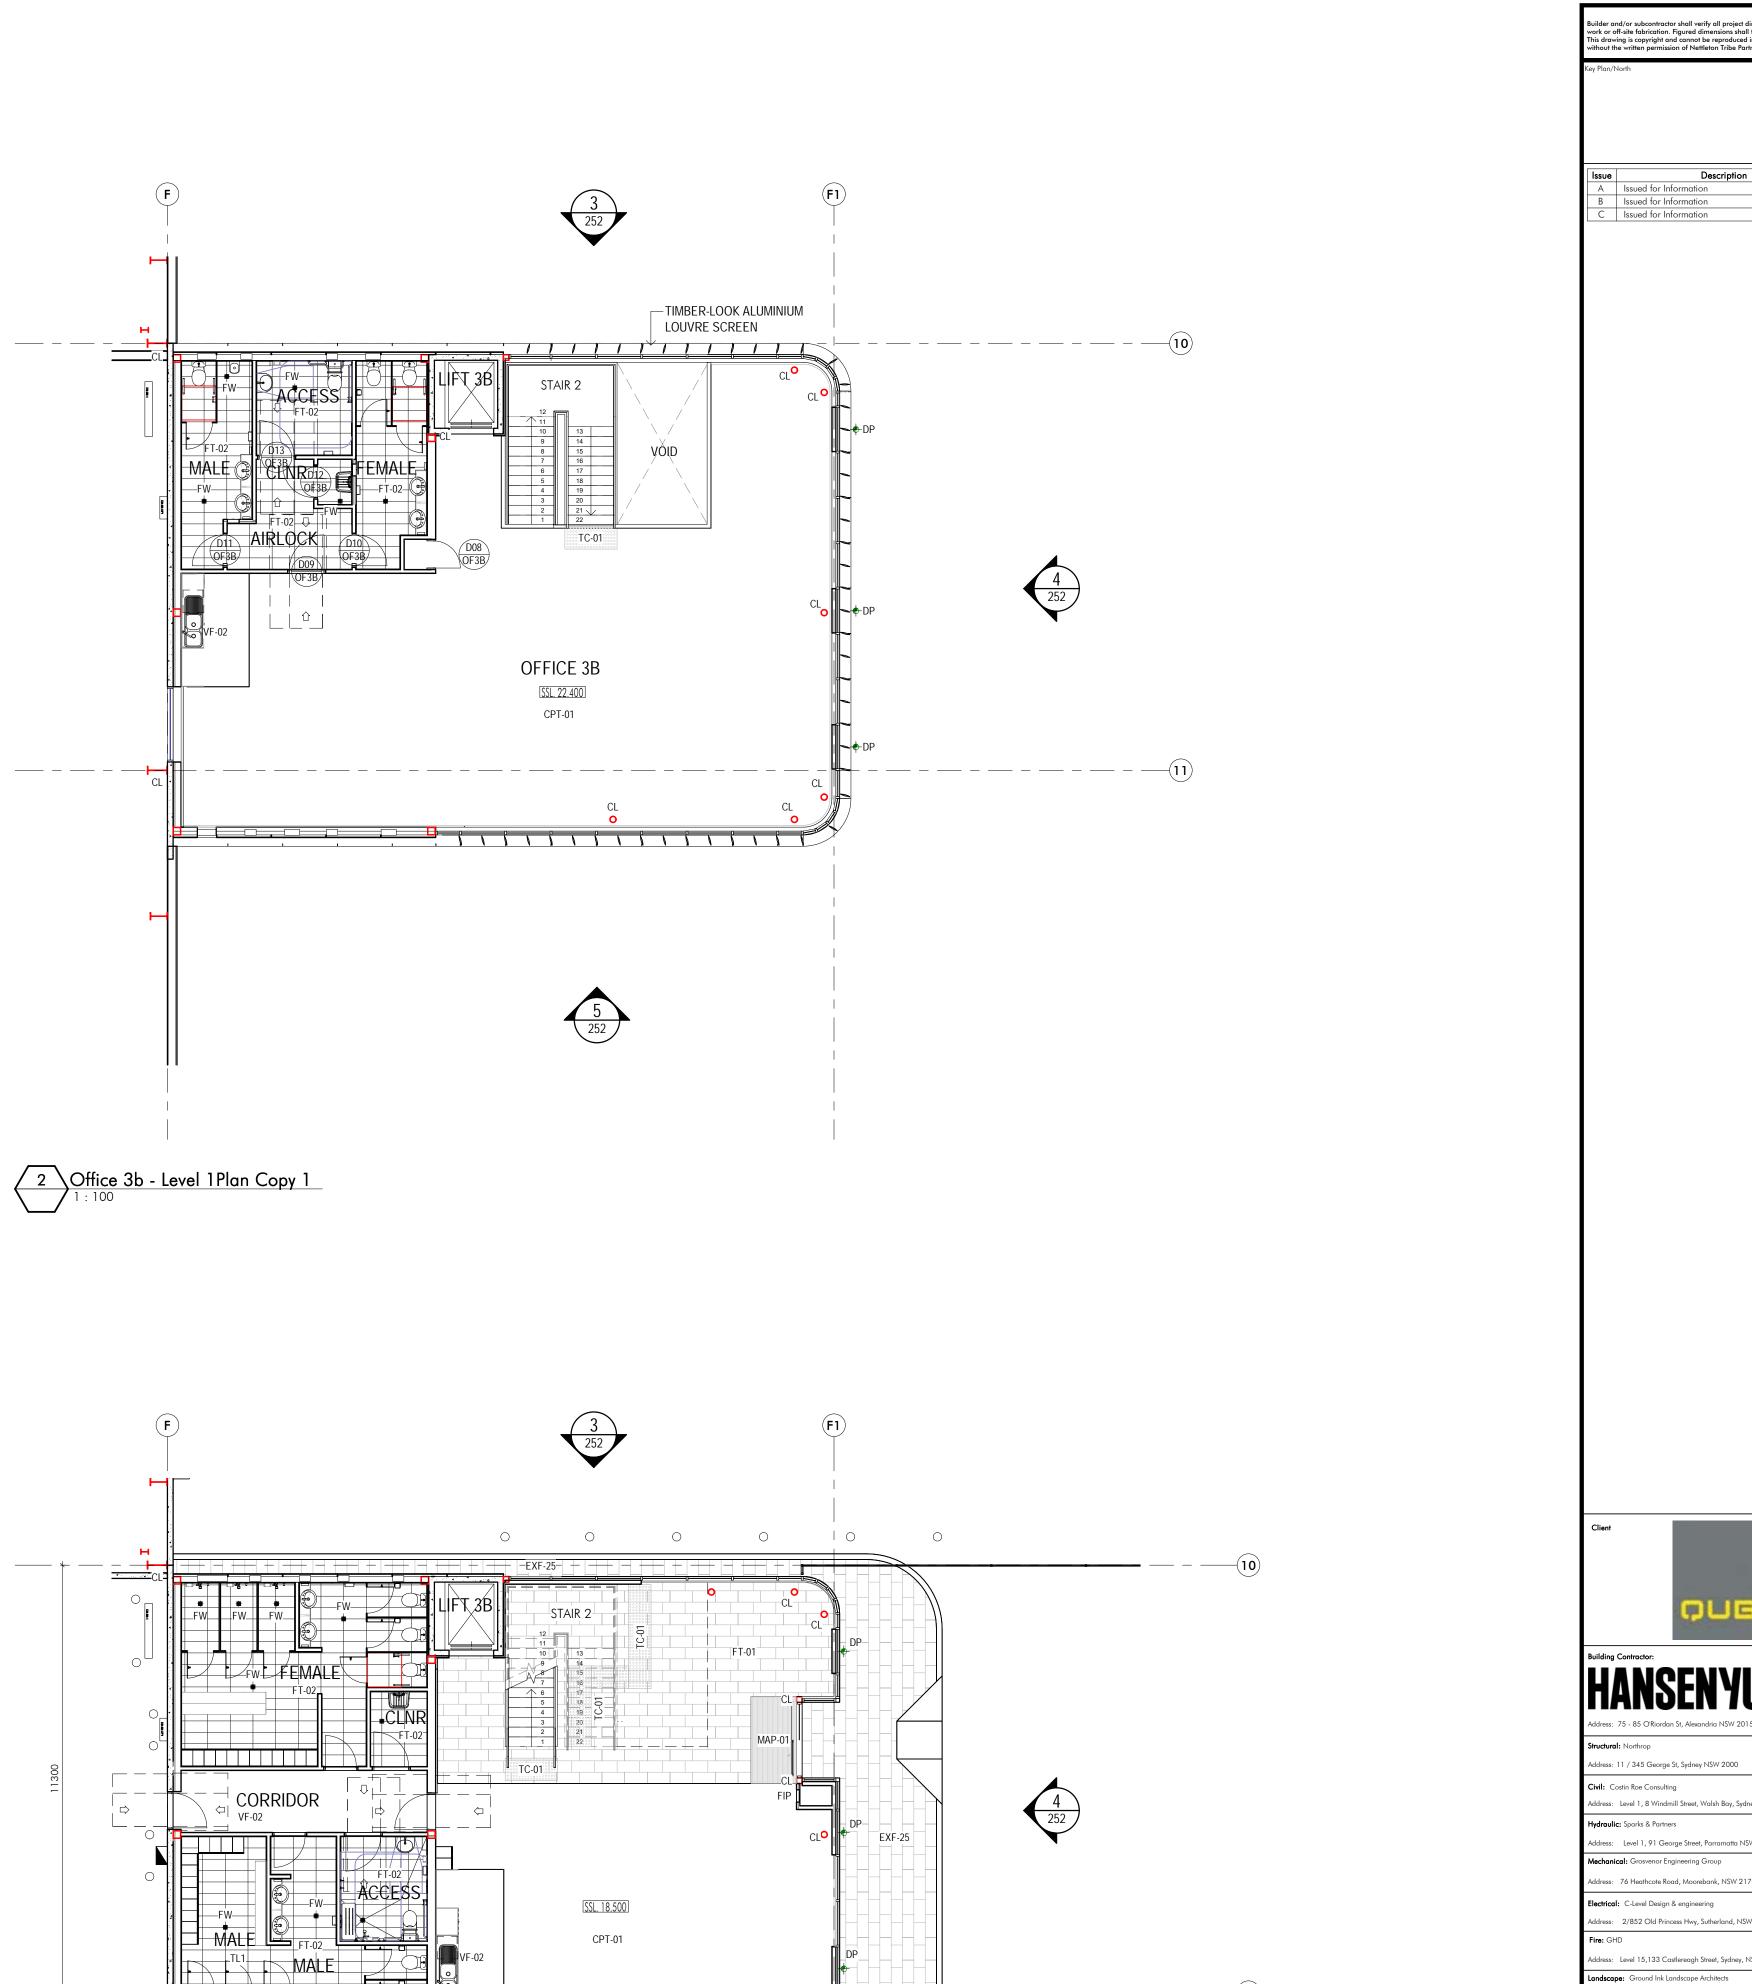
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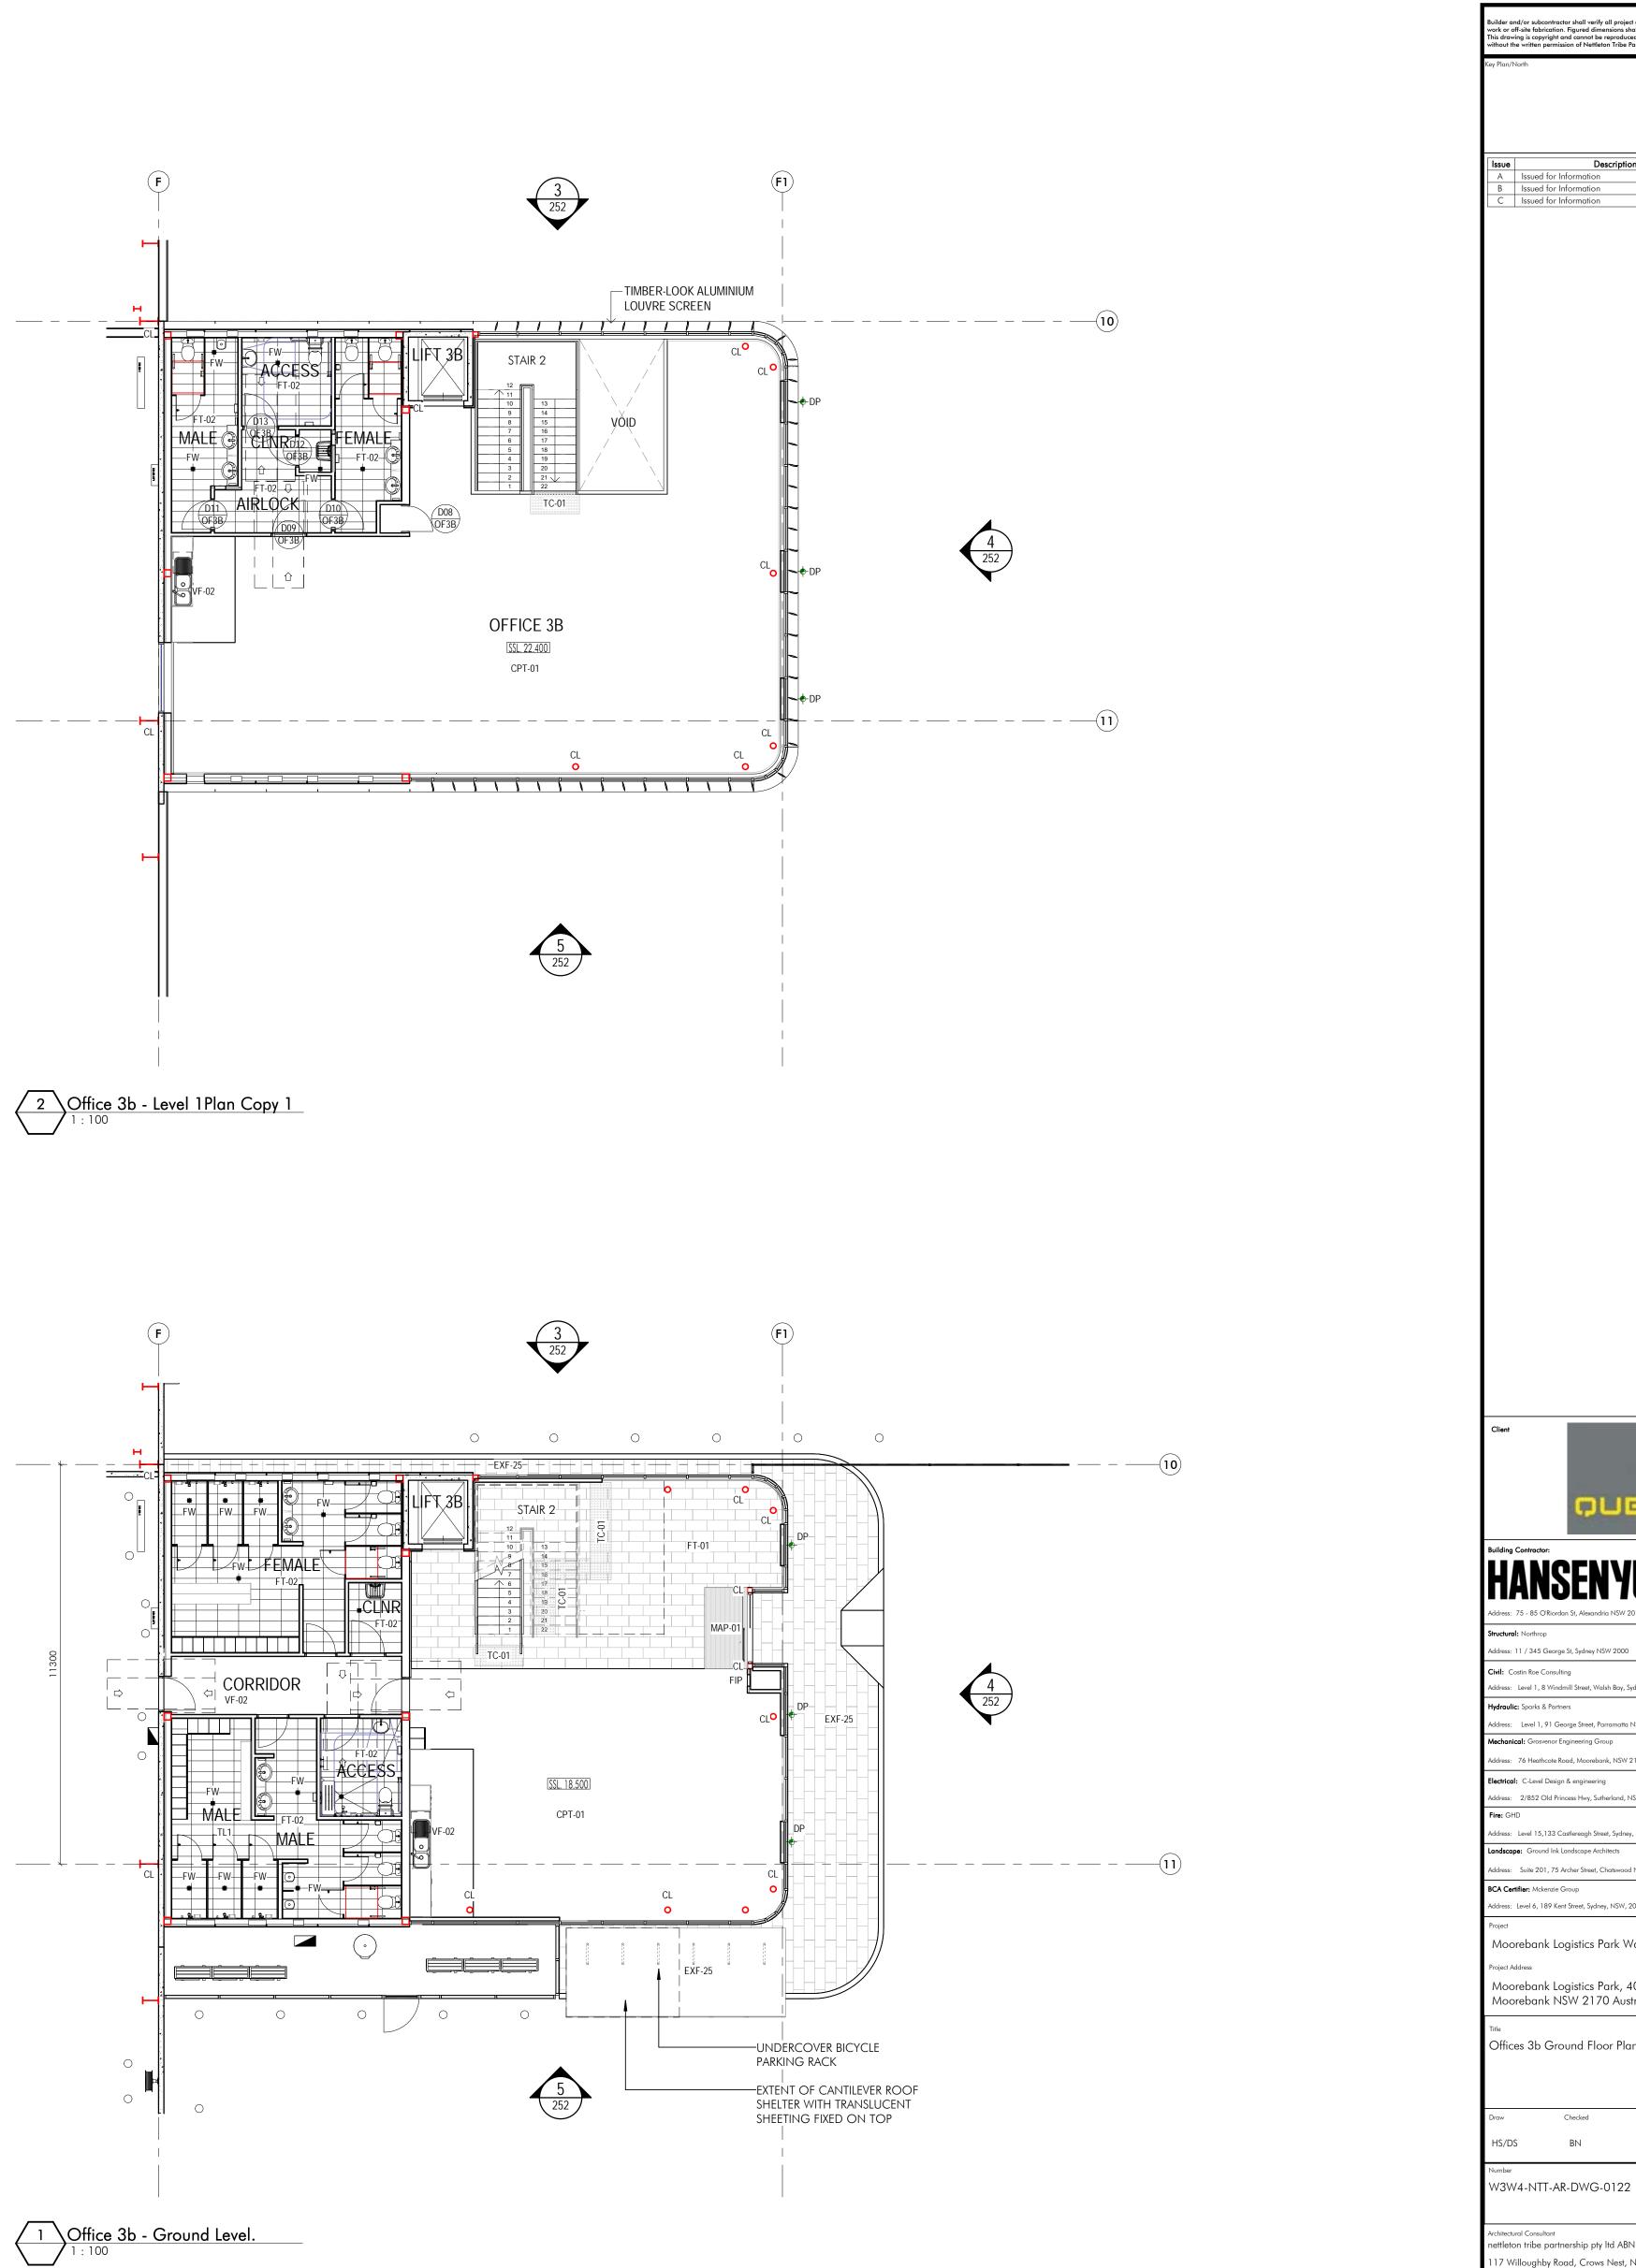
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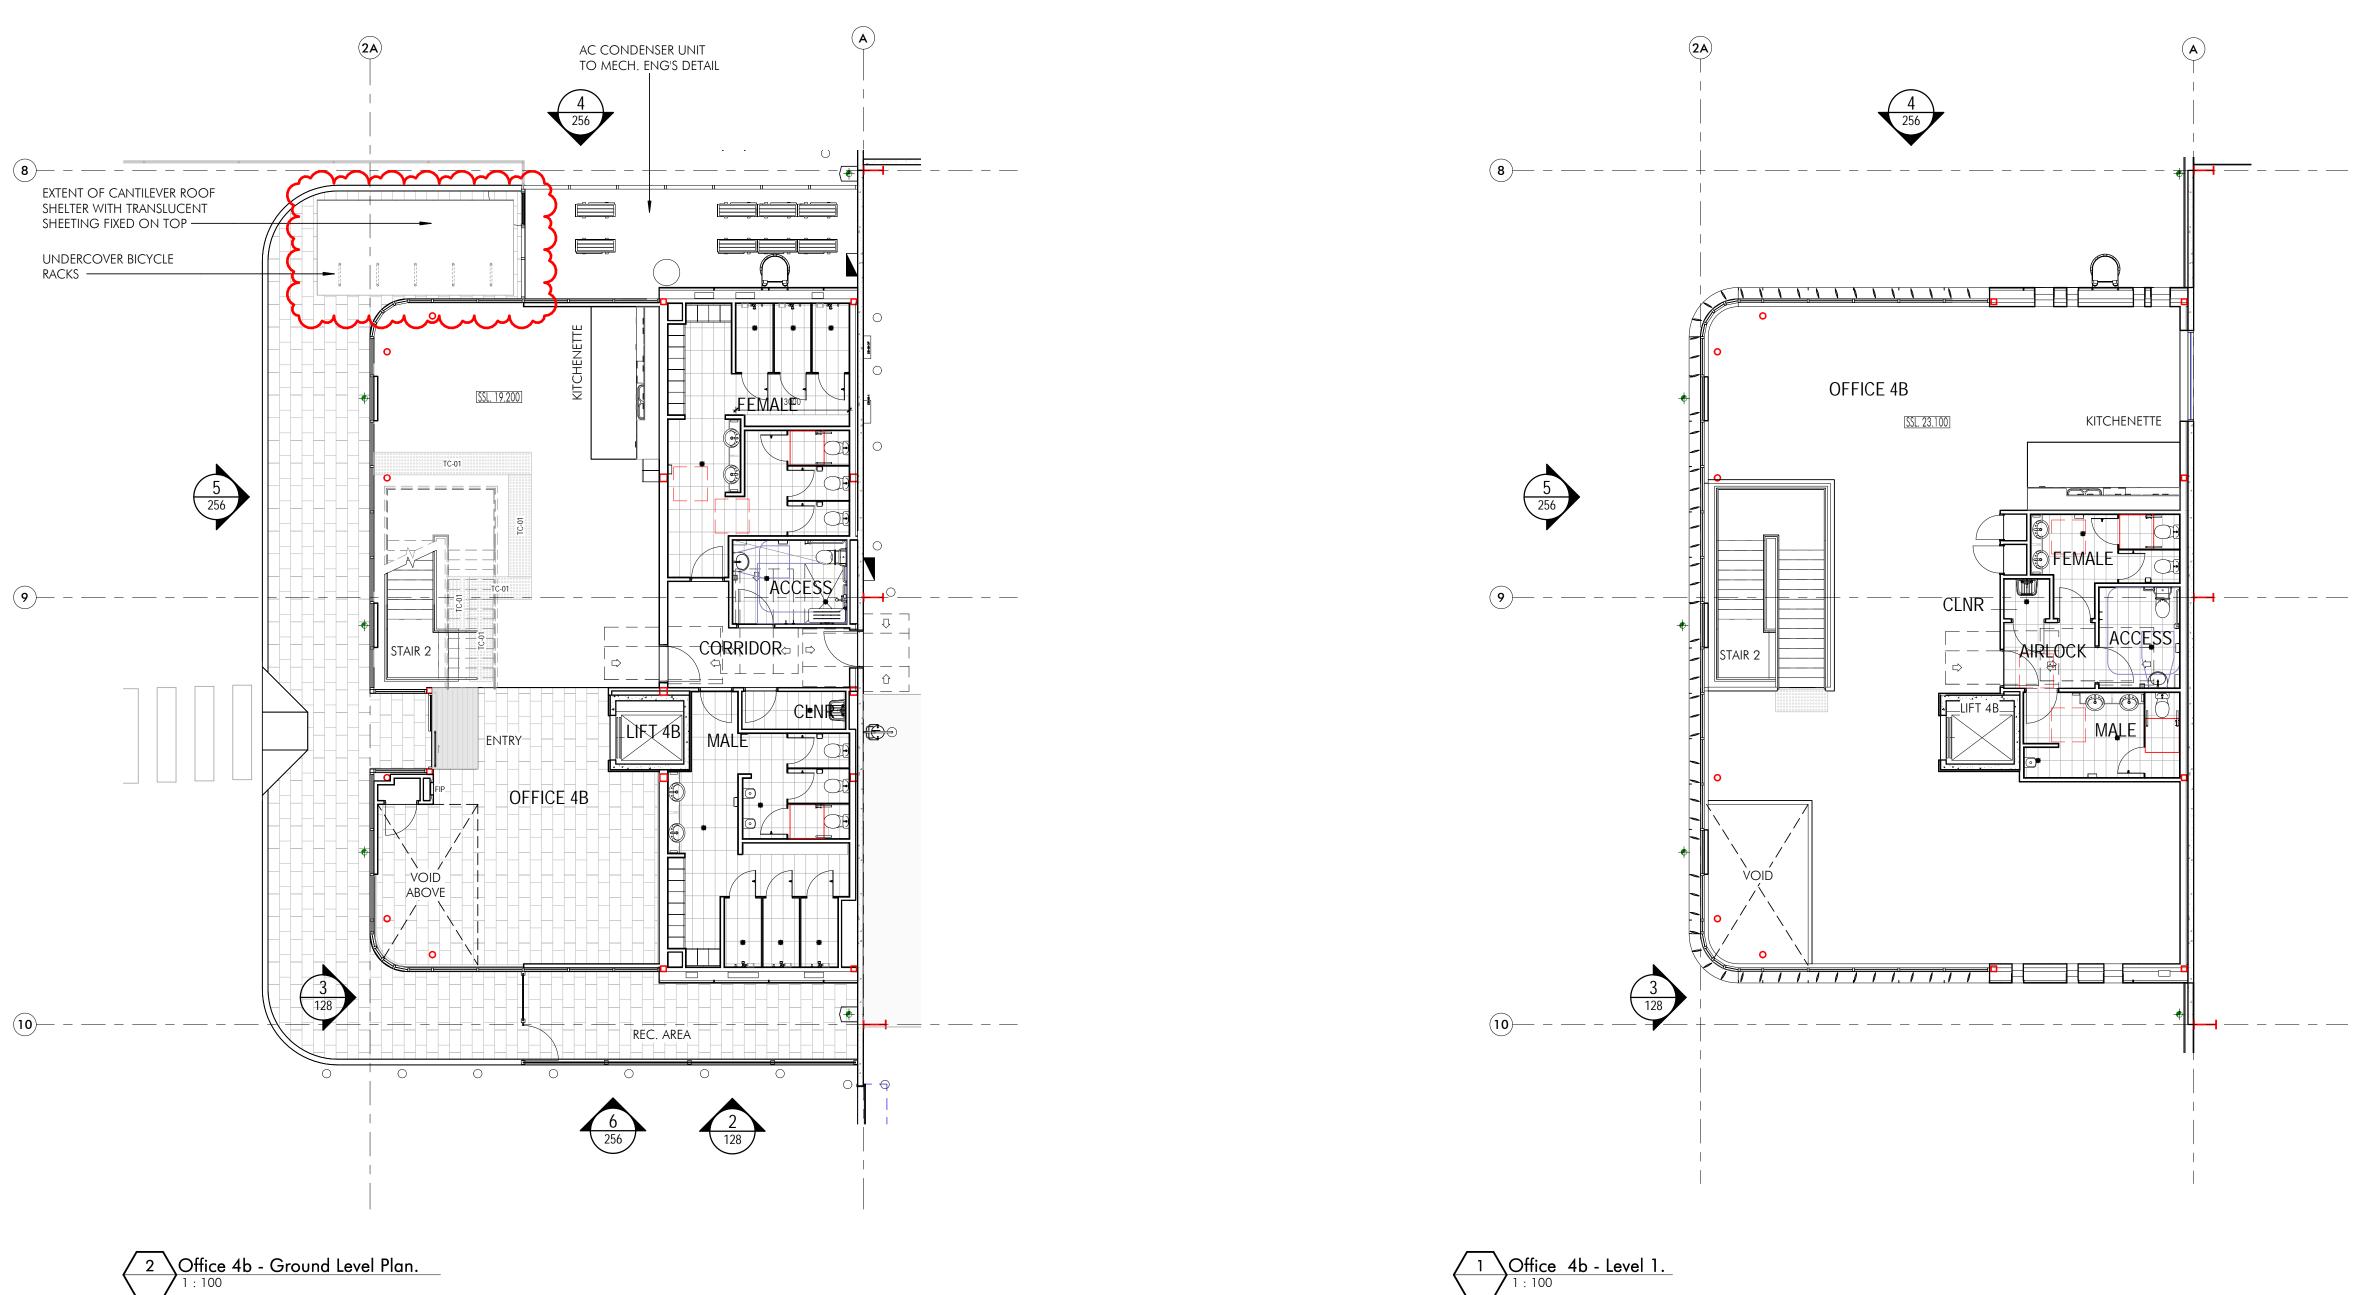

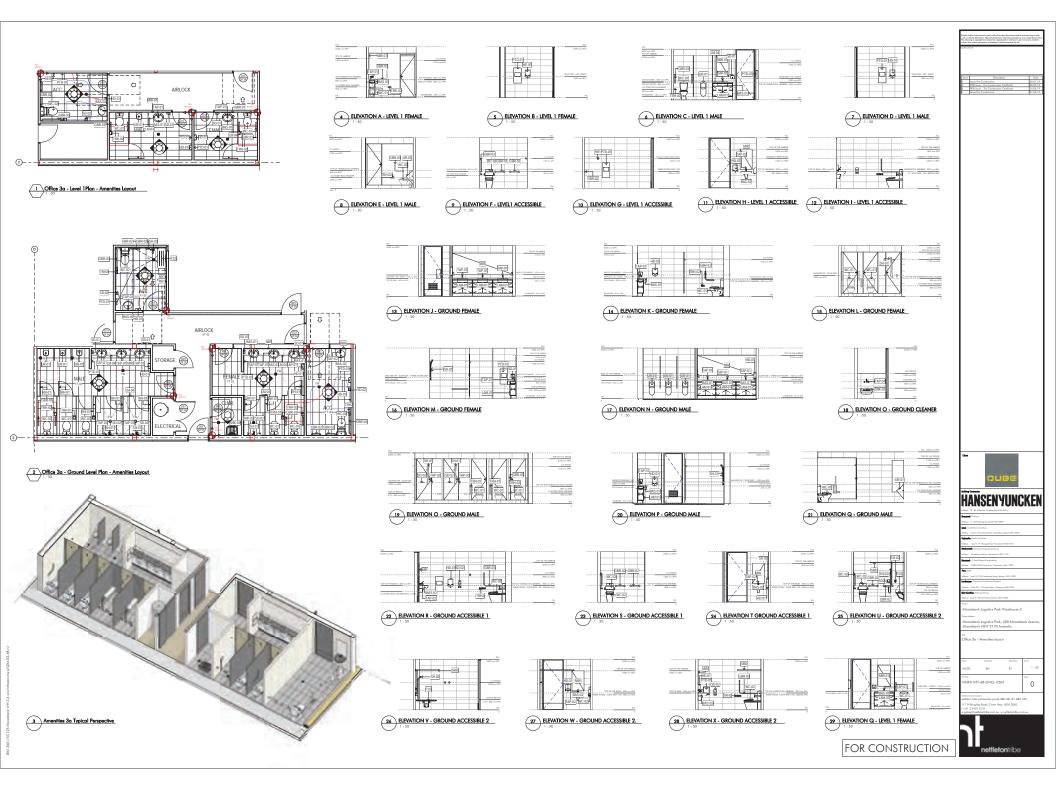
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Architectural Consultant nettleton tribe partnership pty ltd ABN 58 117 Willoughby Road, Crows Nest, NS t +61 2 9431 6131 e sydney@nettletontribe.com.au w nettle


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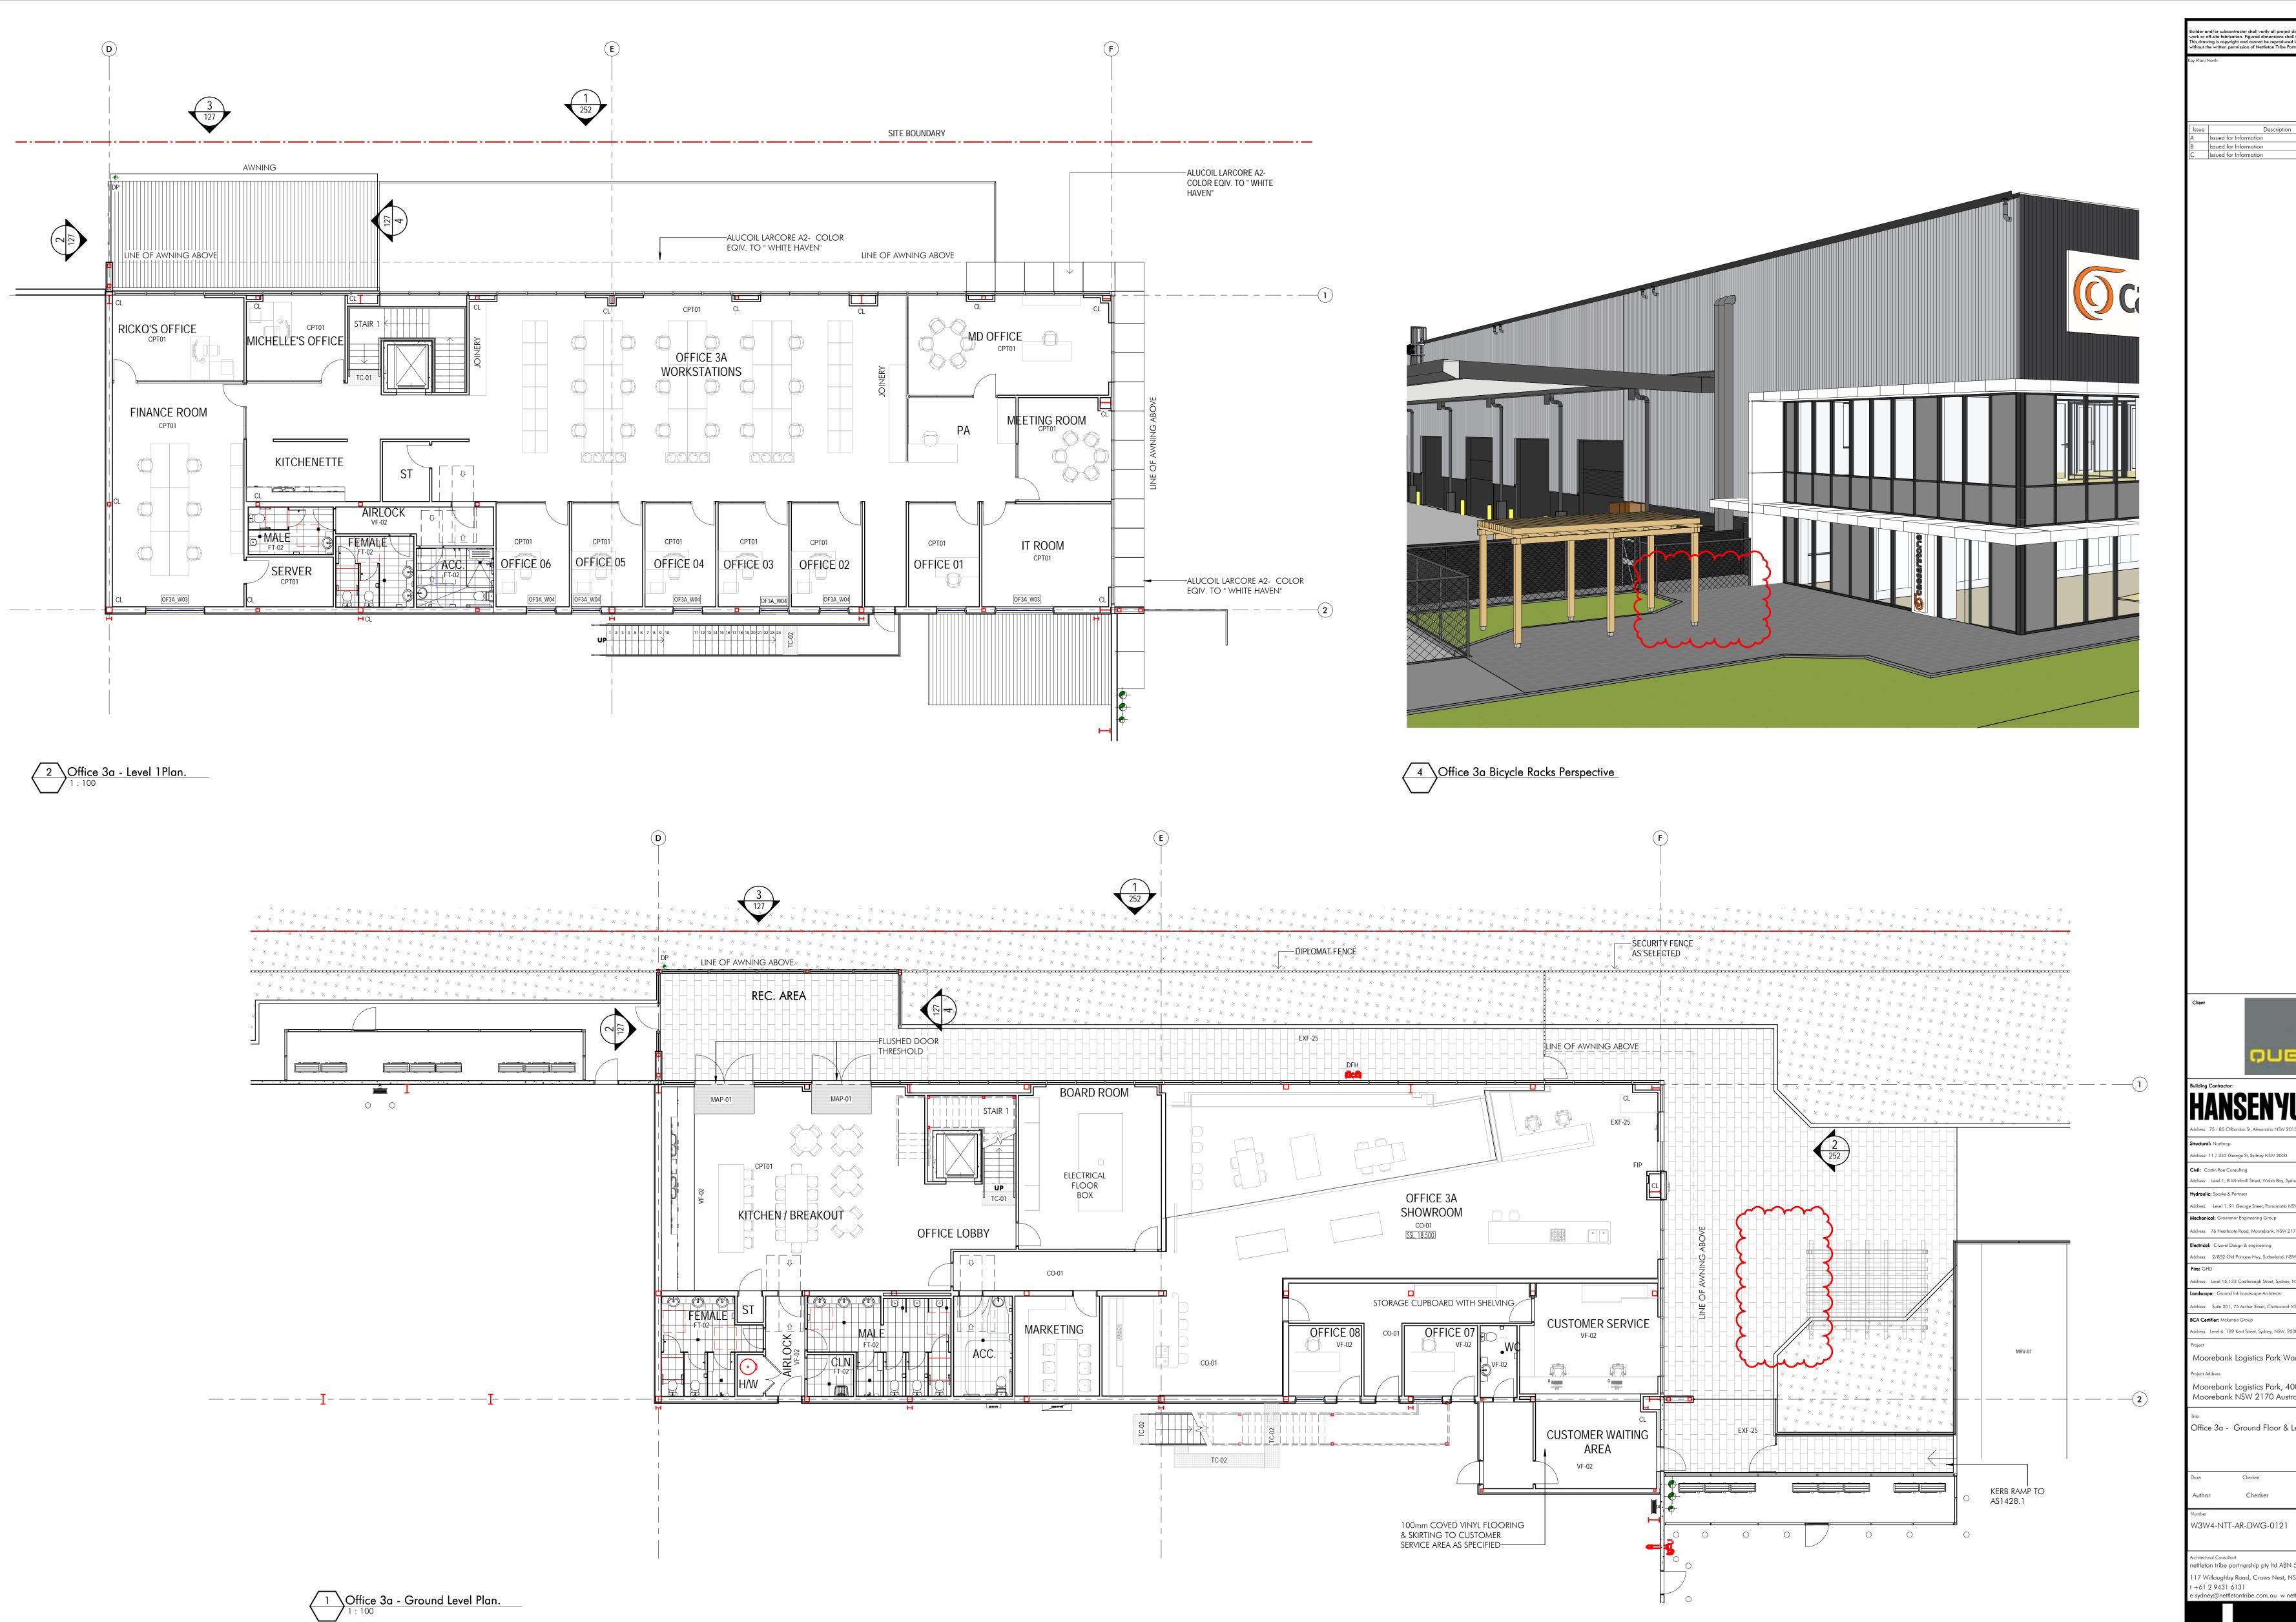


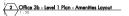
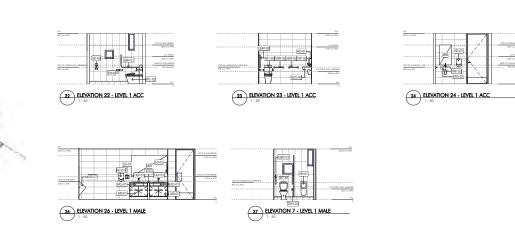
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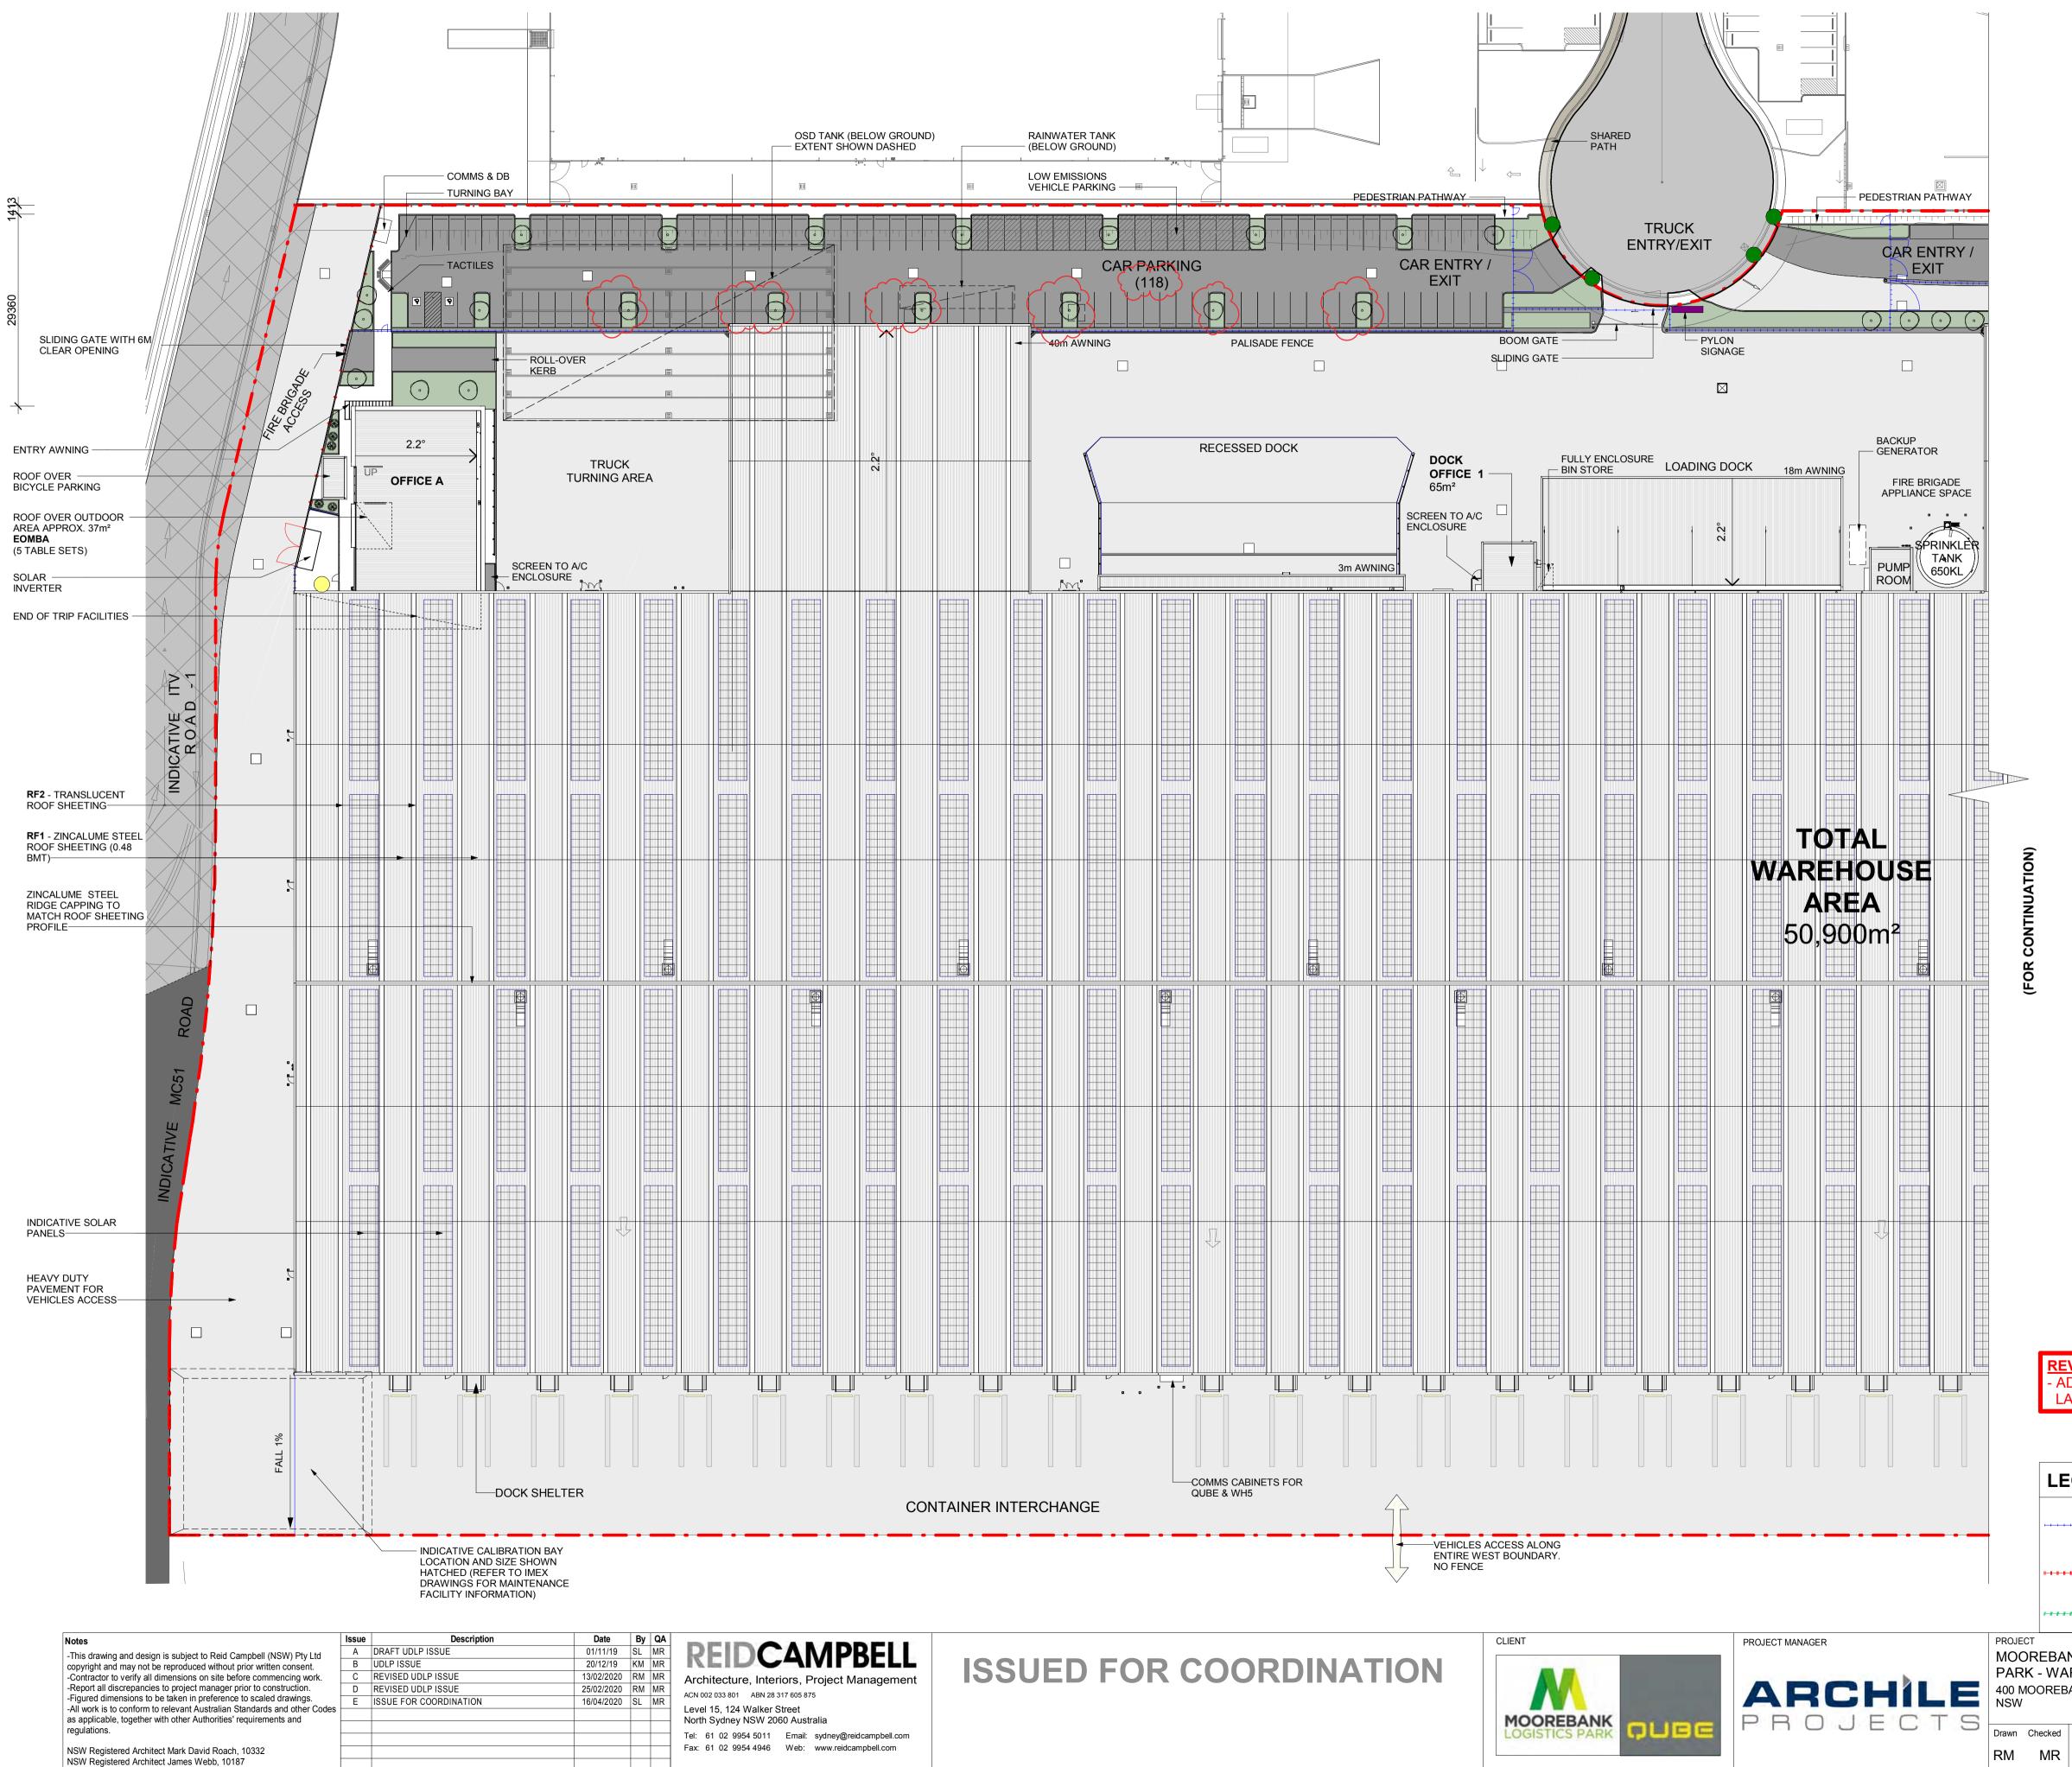


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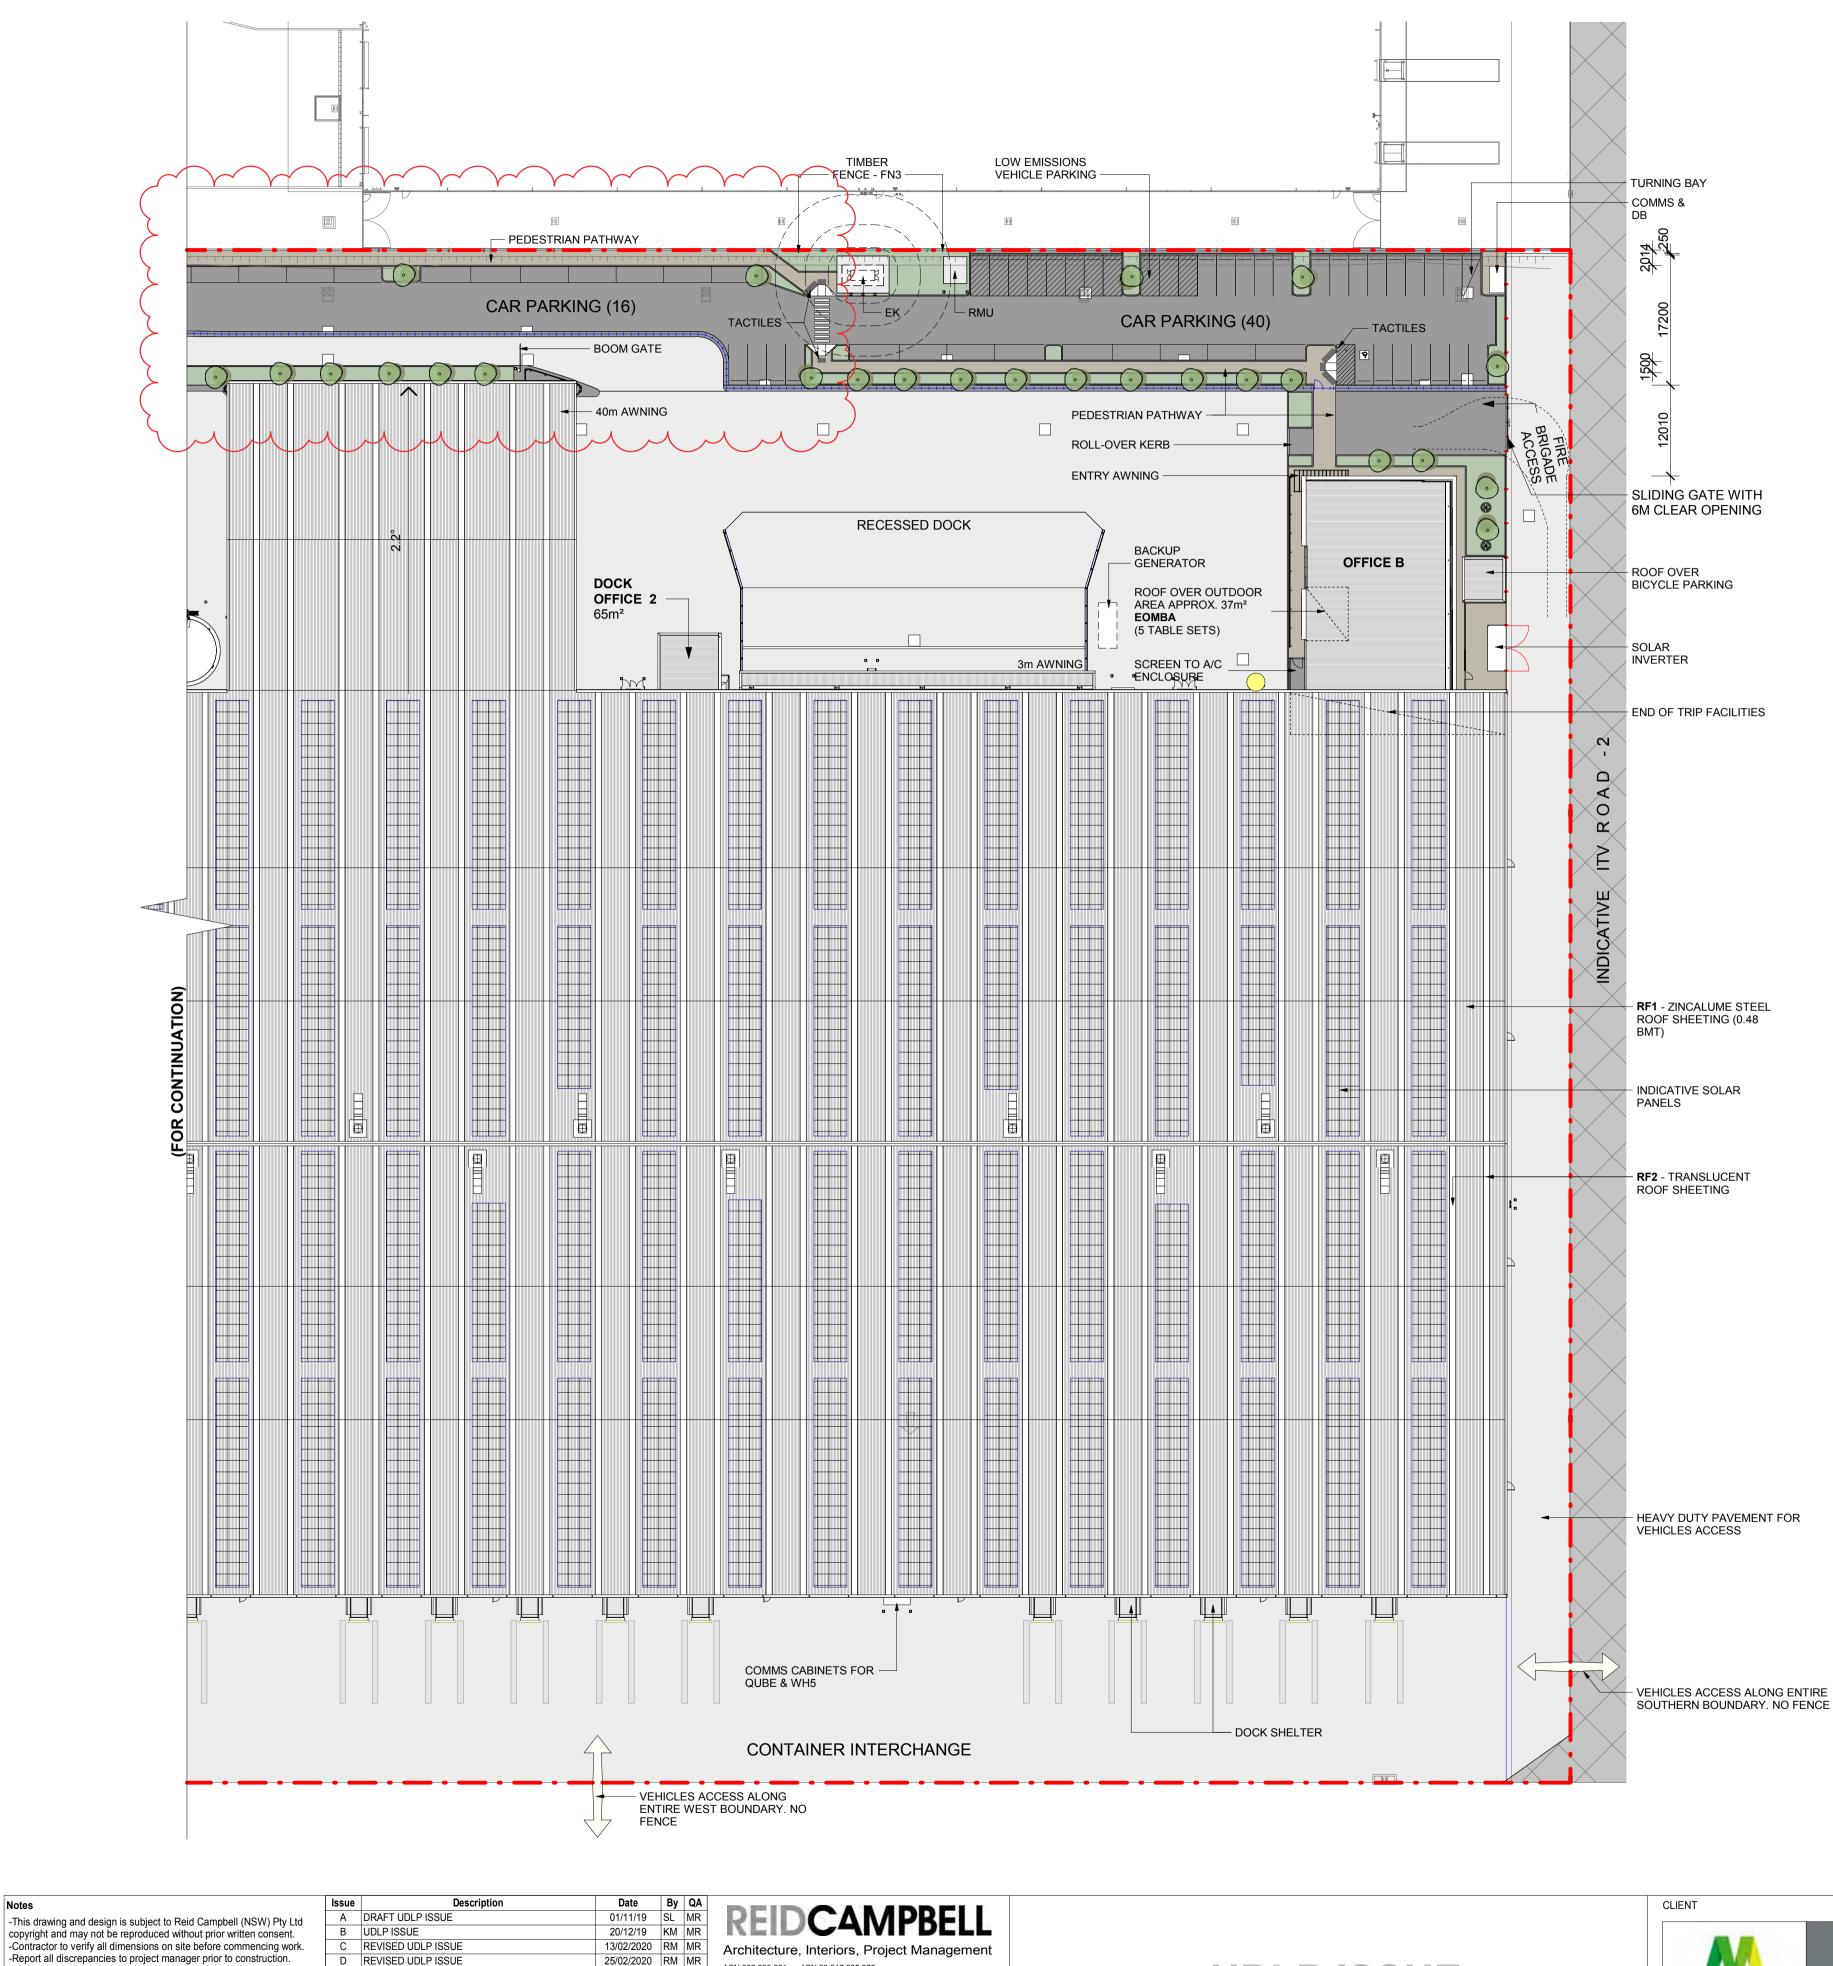
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	DEVELOPMENT SCHEDULE
	SITE AREA (APPROX.) 90,782 m ²
	(INCLUDING DOCK OFFICE 3 & 4) 50,900 m ²
	DOCK OFFICE 1 65 m² DOCK OFFICE 2 65 m²
	OFFICE AREA - GROSS FLOOR AREA (AS PER LIVERPOOL COUNCIL LEP) OFFICE A 972 m ²
	OFFICE B 972 m² 972 m² 972 m²
	CAR PARKING PROVIDED 174 SPACES
	LOW EMISSIONS CAR PARKING (15%) 27 SPACES
	BICYCLE PARKING PROVIDED 26 SPACES
	SHOWERS (PER TENANT)6LOCKERS (PER TENANT)26
	LANDSCAPE : SOFT 1.12% 1017 m² HARD 1.32% 1197 m²
	TOTAL POPULATION(APPROX.) 285TENANT A TENANT B(APPROX.) 152 (APPROX.) 133
	AMENITIES: CLOSET BASIN URINAL ACC. WC
	M F M F OFFICE A 2 2 2 2 2 2 WAREHOUSE A 4 3 5 3 5 2 DOCK OFFICE 1 1 1 1 1 1 1
	OFFICE B 2<
	WAREHOUSE B 4 3 5 3 5 2 DOCK OFFICE 2 1 1 1 1 1 1
	HEAVY DUTY PAVEMENT
	LIGHT DUTY PAVEMENT
	ITV ROAD
	PEDESTRIAN PATHWAY HARD LANDSCAPE
	SOFT LANDSCAPE
	TYPE 2 - TENANT IDENTIFICATION SIGNAGE TYPE 3 - DIRECTION SIGNAGE TYPE 4 - CORPORATE SIGNAGE
	ABBREVIATION
	SI SOLAR INVERTER
	EK ELECTRICAL KIOSK SUBSTATION
	RMU RING MAIN UNIT RF1 METAL PROFILED ROOF SHEETING
	ZINCALUME BCA CLASSIFICATION : MEDIUM
	RF2 TRANSLUCENT ROOF SHEETING
	EOMBA EMPLOYEE OUTDOOR MEAL BREAK AREA
	GENERAL NOTES:1.THIS DRAWING IS TO BE READ IN CONJUNCTION WITH ALL CONSULTANTS' DOCUMENTATION2.ALL WORKS SHALL COMPLY WITH THE REQUIREMENTS OF THE NCC (BCA), AUSTRALIAN STANDARDS, CURRENT CODES AND LOCAL AUTHORITIES REGULATIONS3.PROVIDE ALL CONCRETE AND STRUCTURAL STEEL IN ACCORDANCE WITH STRUCTURAL ENGINEER'S DOCUMENTATION4.PROVIDE ALL DRAINAGE IN ACCORDANCE WITH HYDRAULIC ENGINEER'S DOCUMENTATION5.IT IS THE CONTRACTOR'S RESPONSIBILITY TO
REVISION NOTE: - ADJUSTED CAR PARKING SPACE & LANDSCAPE	 CO-ORDINATE CONNECTIONS, LOCATIONS AND DETAILS BETWEEN STRUCTURAL STEEL, PRECAST PANELS AND INSITU CONCRETE 6. ALL LEVELS AND EXTENTS ARE INDICATIVE & SHOULD BE READ IN CONJUNCTION WITH CIVIL ENG. DWGS FOR FINAL LEVELS.
	 ALL FFL LEVELS ±500mm. ALL LEVELS AND EXTENTS ARE INDICATIVE & SHOULD BE READ IN CONJUNCTION WITH CIVIL
LEGEND:	 ENG. DWGS FOR FINAL LEVELS OF ALL EARTH WORKS AND EXCAVATION. 9. ALL LANDSCAPING TO LANDSCAPE ARCHITECT'S DETAILS. 10. ALL SIGNAGE SUBJECT TO CONDITIONS OF
STYLE PRESSED METAL FENCING 2.1M WITH CRIMPED SPEAR TOP. BLACK VINYL COATED CHAINWIRE	0m 10m 20m 30m 40m 50m
MESH WITH 3 ROWS OF BARBED WIRE. OVERALL HEIGHT OF 3M. TIMBER FENCE	SCALE BAR: 1:500 @ A1
REBANK LOGISTICS	DRAWING NAME SITE PLAN PART 01
DOREBANK AVE, MOOREBANK	RCG. PROJECT NO. 118124 STATUS CODE SHEET NUMBER ISSU
MR 16/04/2020 6:48:21 PM	WHP5-RCG-AR-DWG-UDLP1 E

BIM 360://Qube - Warehouse 5/118124_MB LOGISTICS_QUBE WH5_V1.rvt

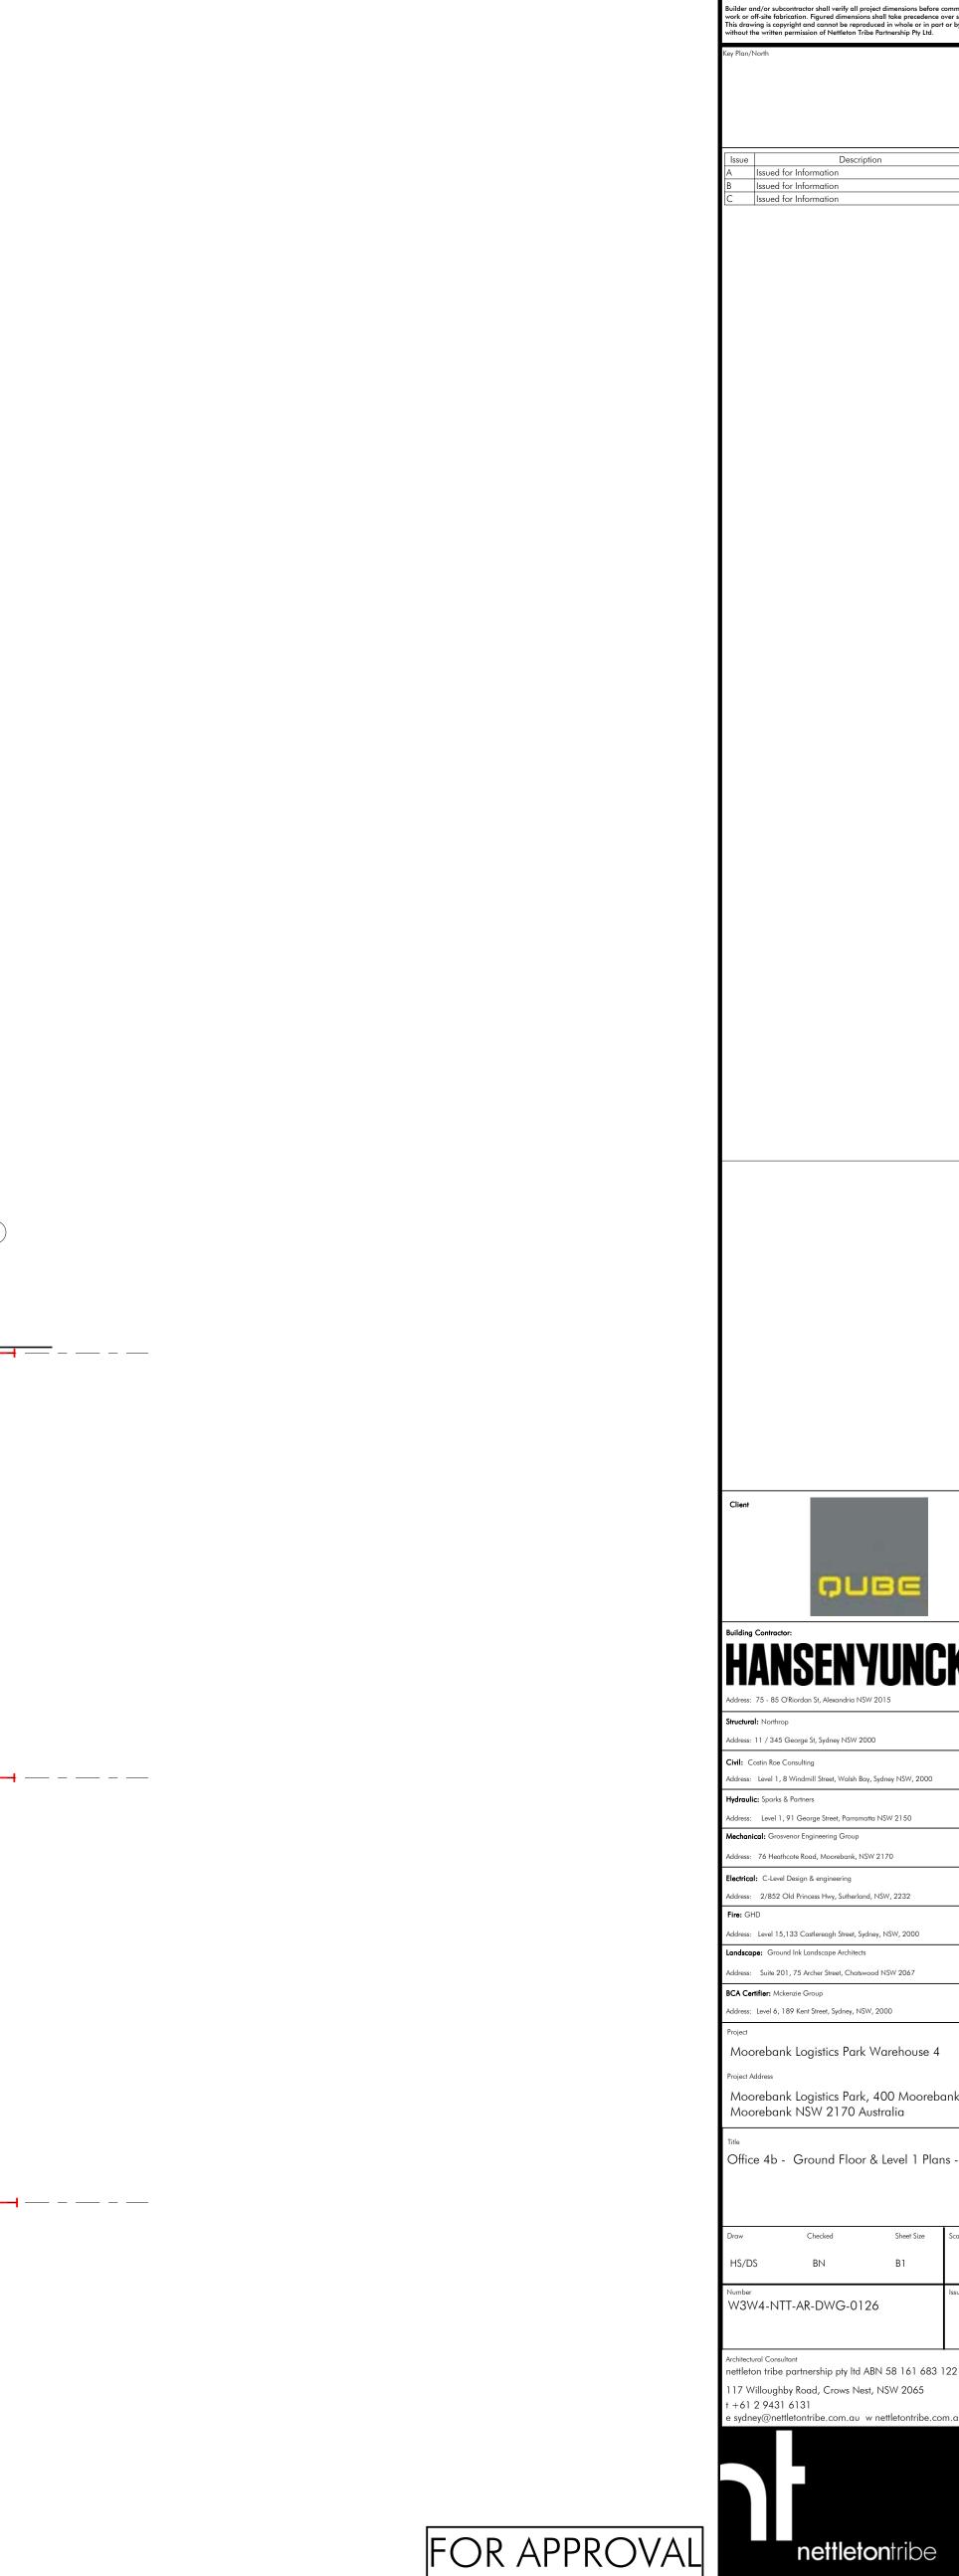

NSW Registered Architect Mark David Roach, 10332 NSW Registered Architect James Webb, 10187

-Figured dimensions to be taken in preference to scaled drawings. -All work is to conform to relevant Australian Standards and other Codes

as applicable, together with other Authorities' requirements and

Notes

regulations.

D REVISED UDLP ISSUE

25/02/2020 RM MR

North Sydney NSW 2060 Australia Tel: 61 02 9954 5011 Email: sydney@reidcampbell.com Fax: 61 02 9954 4946 Web: www.reidcampbell.com

ACN 002 033 801 ABN 28 317 605 875

Level 15, 124 Walker Street

UDLP ISSUE





PROJECT MOOR PARK

RM


		ITV ROAD PEDESTRIAN PATHWAY HARD LANDSCAPE SOFT LANDSCAPE TYPE 2 - TENANT IDENTIFICATION SIGNAGE TYPE 3 - DIRECTION SIGNAGE TYPE 4 - CORPORATE SIGNAGE
	SI	SOLAR INVERTER
	EK	ELECTRICAL KIOSK SUBSTATION
	RMU	RING MAIN UNIT
	RF1	METAL PROFILED ROOF SHEETING ZINCALUME BCA CLASSIFICATION : MEDIUM
	RF2	TRANSLUCENT ROOF SHEETING
	EOMBA	EMPLOYEE OUTDOOR MEAL BREAK AREA
REVISION NOTE: • MAIN ENTRY AND PARKING ADJUSTED • DRAFT ISSUE DELETED • LANDSCAPE AREA AMENDED LEGEND: • BLACK POWDER COATED DIPLOMAT STYLE PRESSED METAL FENCING 2.1M WITH CRIMPED SPEAR TOP. • HITTE • BLACK VINYL COATED CHAINWIRE	1.THIS WIT2.ALL REC AUS2.ALL REC AUS3.PRC ENC3.PRC ENC4.PRC HYE5.IT IS CO- DET PRE6.ALL SHC ENC 7.7.ALL SHC ENC U9.ALL ARC COI10.ALL COI	L NOTES: S DRAWING IS TO BE READ IN CONJUNCTION THALL CONSULTANTS' DOCUMENTATION WORKS SHALL COMPLY WITH THE QUIREMENTS OF THE NCC (BCA), STRALIAN STANDARDS, CURRENT CODES D LOCAL AUTHORITIES REGULATIONS DVIDE ALL CONCRETE AND STRUCTURAL EL IN ACCORDANCE WITH STRUCTURAL EL IN ACCORDANCE WITH STRUCTURAL GINEER'S DOCUMENTATION DVIDE ALL DRAINAGE IN ACCORDANCE WITH DRAULIC ENGINEER'S DOCUMENTATION S THE CONTRACTOR'S RESPONSIBILITY TO ORDINATE CONNECTIONS, LOCATIONS AND TAILS BETWEEN STRUCTURAL STEEL, ECAST PANELS AND INSITU CONCRETE LEVELS AND EXTENTS ARE INDICATIVE & DULD BE READ IN CONJUNCTION WITH CIVIL 3. DWGS FOR FINAL LEVELS. FFL LEVELS ±500mm. LEVELS AND EXTENTS ARE INDICATIVE & DULD BE READ IN CONJUNCTION WITH CIVIL 3. DWGS FOR FINAL LEVELS OF ALL EARTH RKS AND EXCAVATION. LANDSCAPING TO LANDSCAPE CHITECT'S DETAILS. SIGNAGE SUBJECT TO CONDITIONS OF NSENT.
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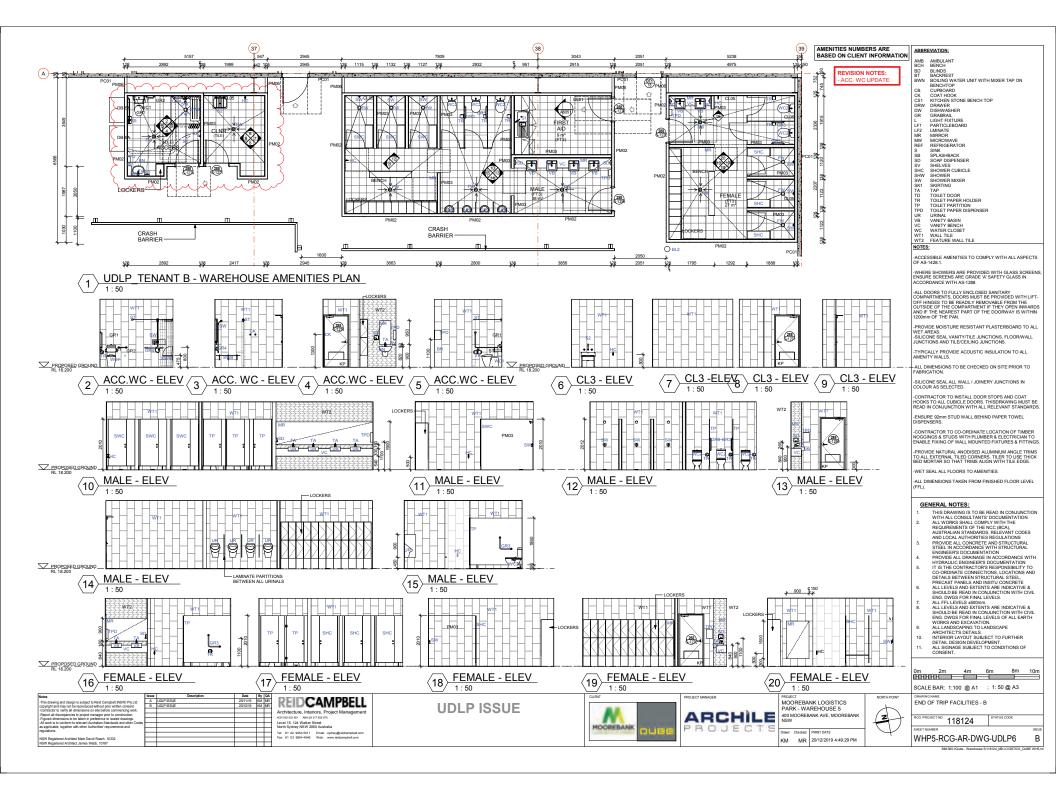
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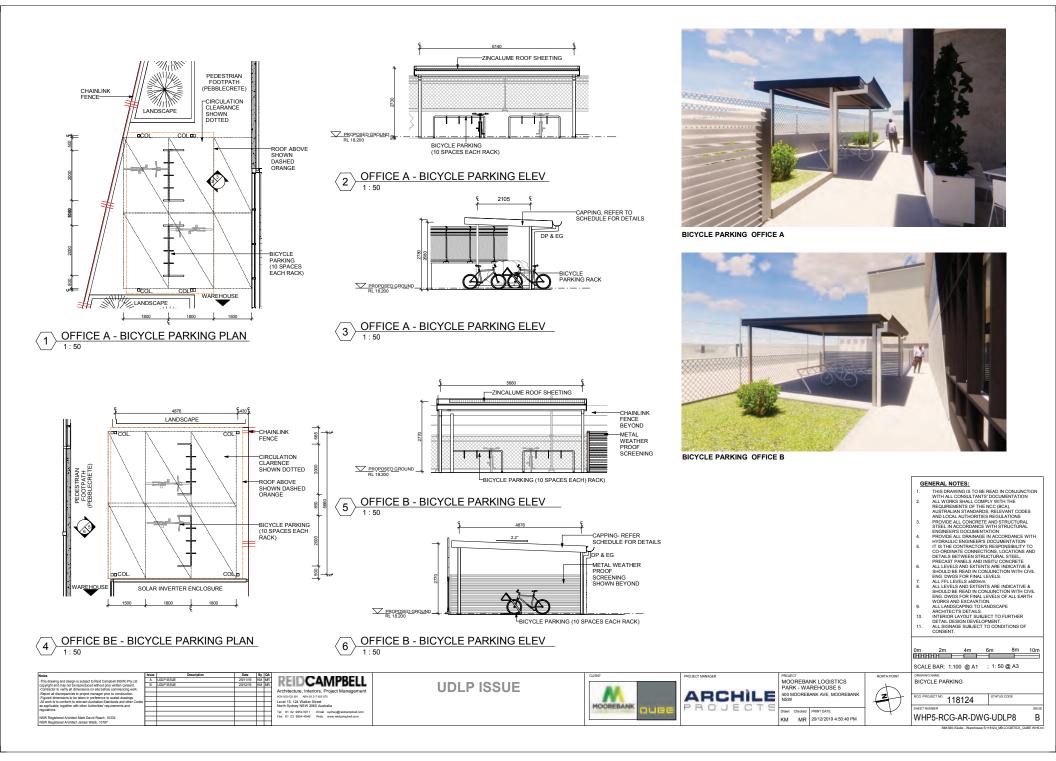
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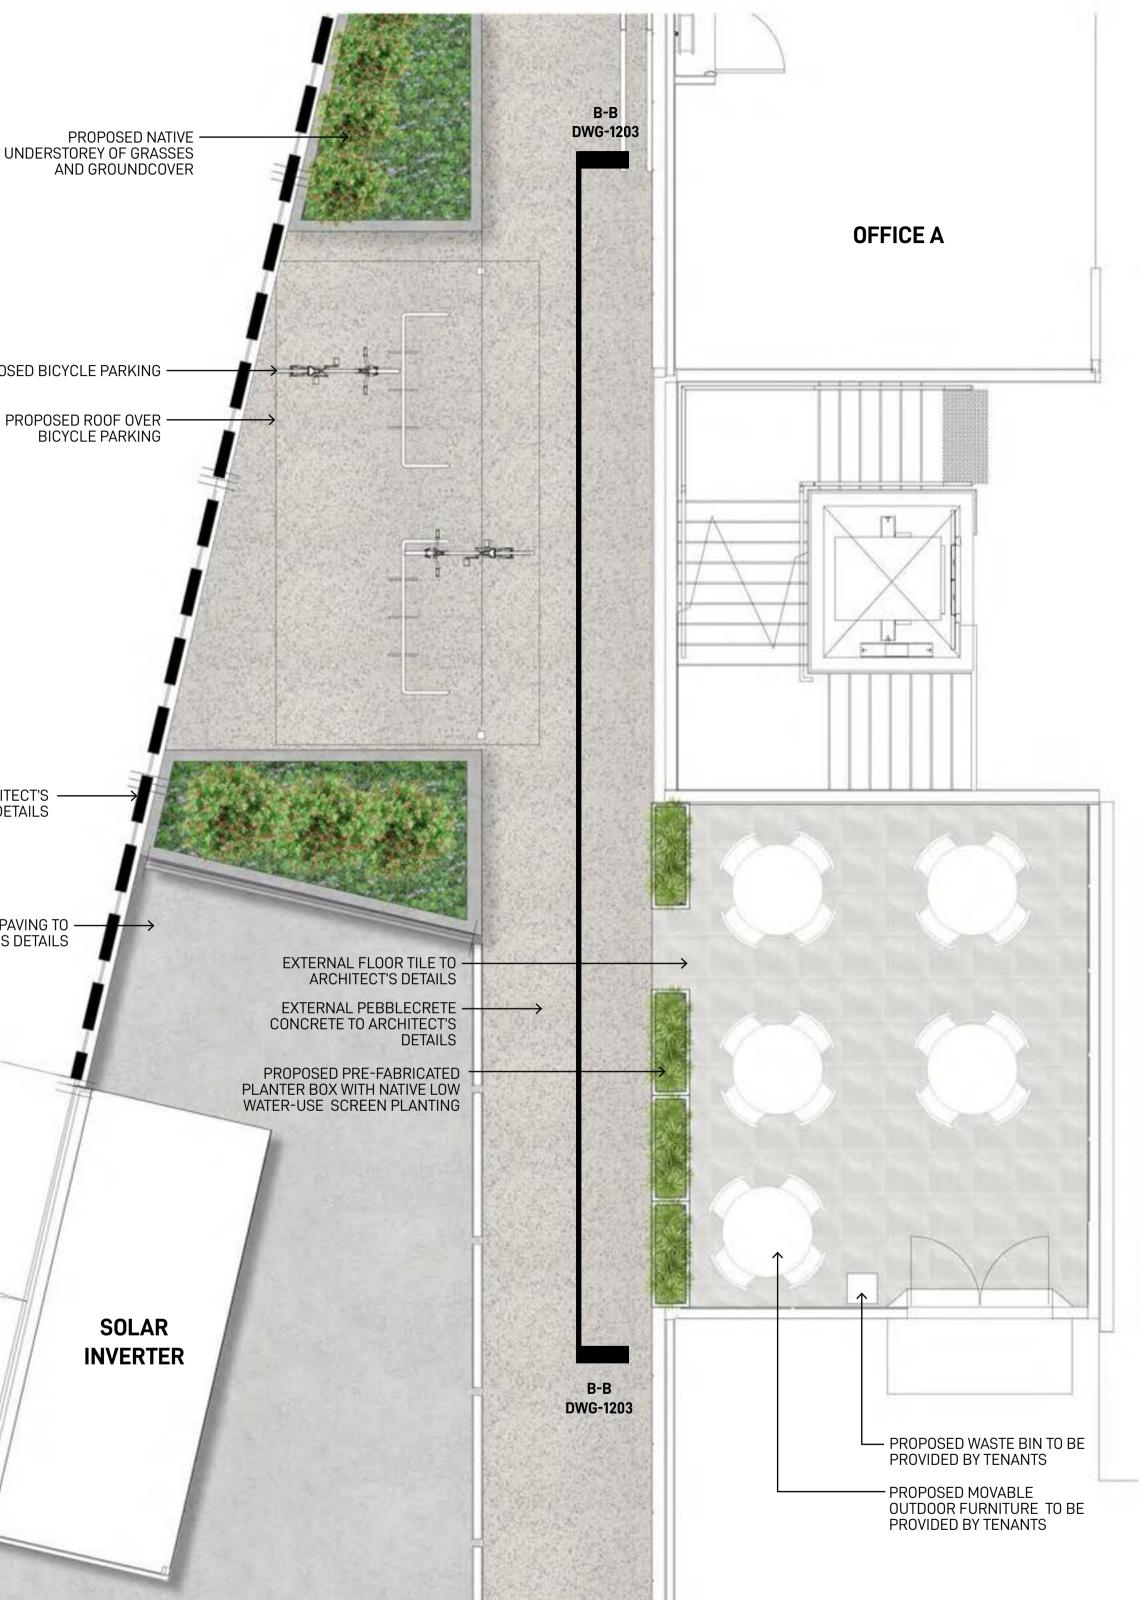
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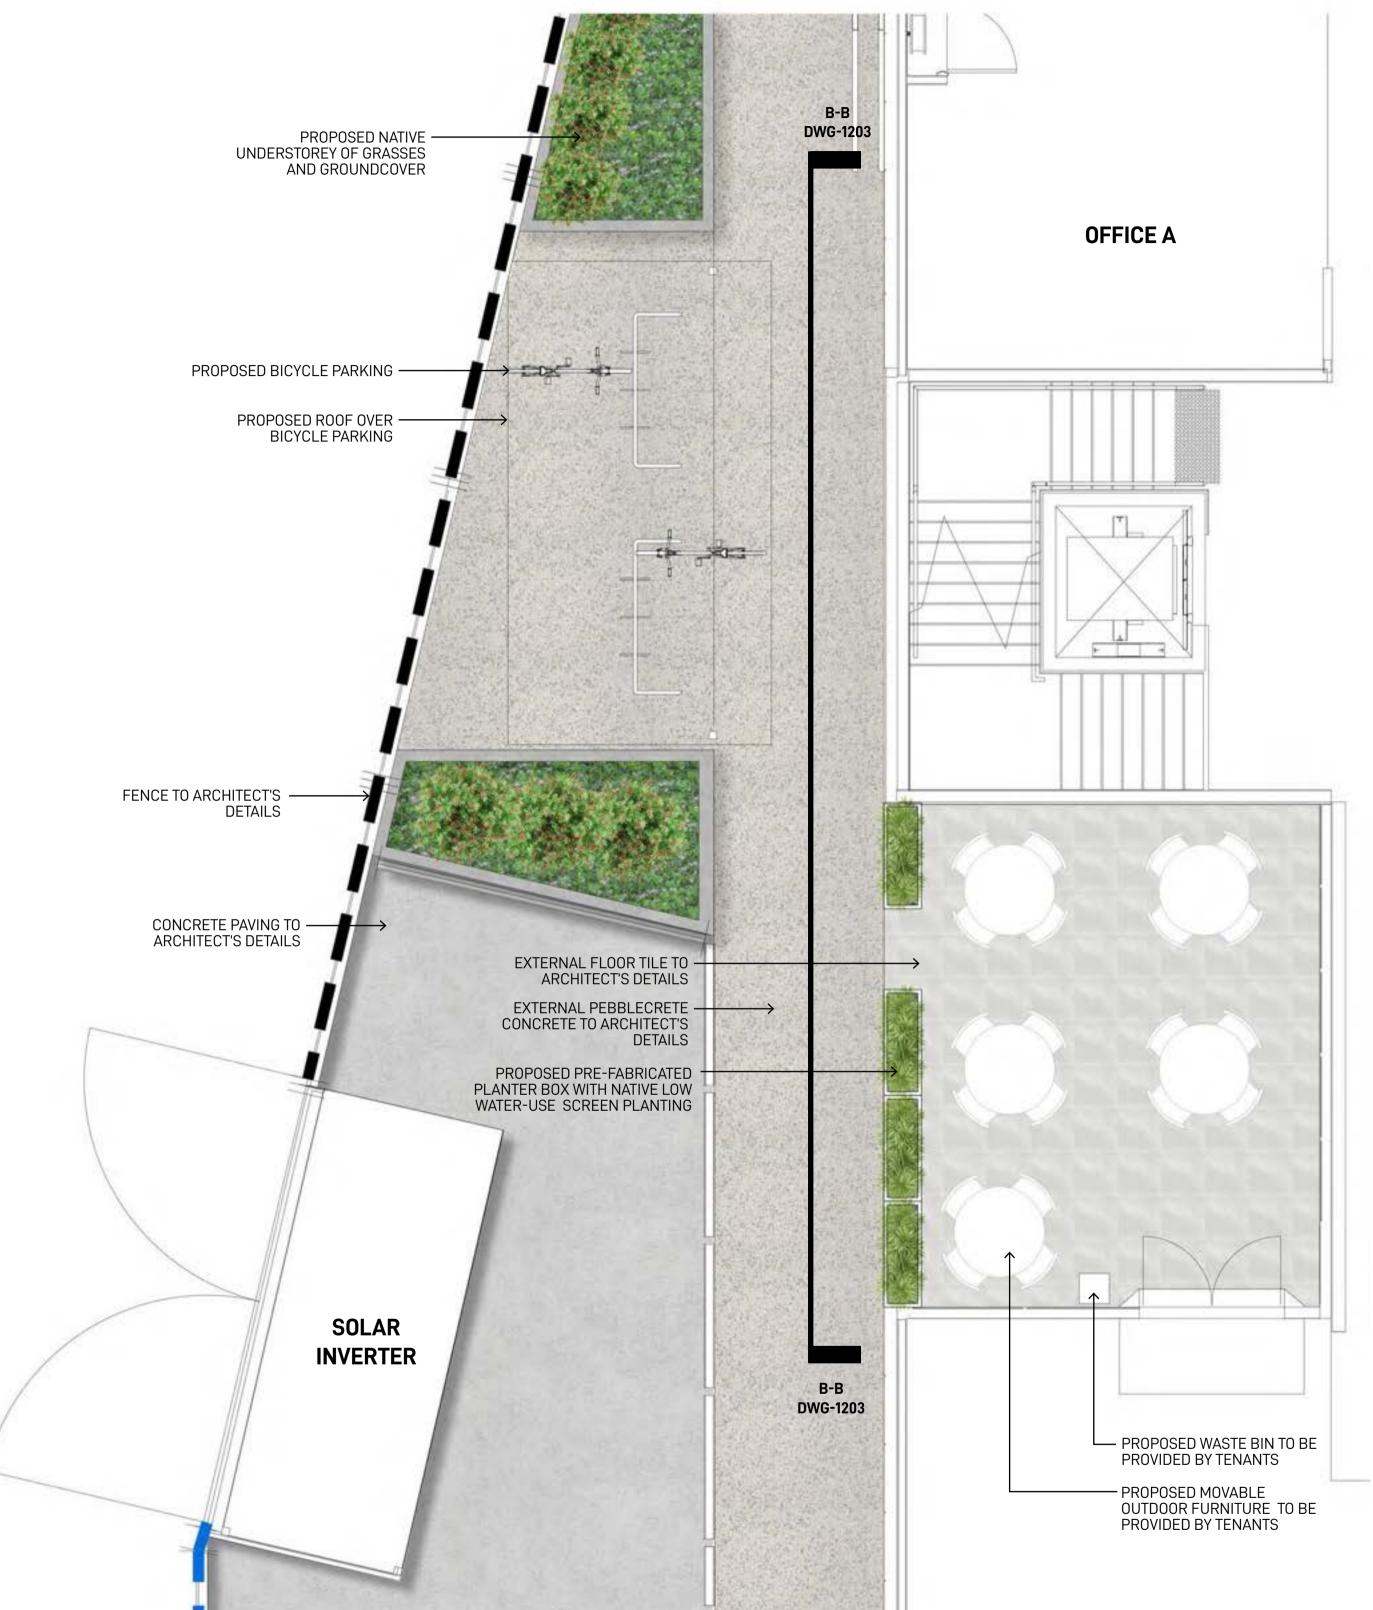
LIGHT DUTY PAVEMENT











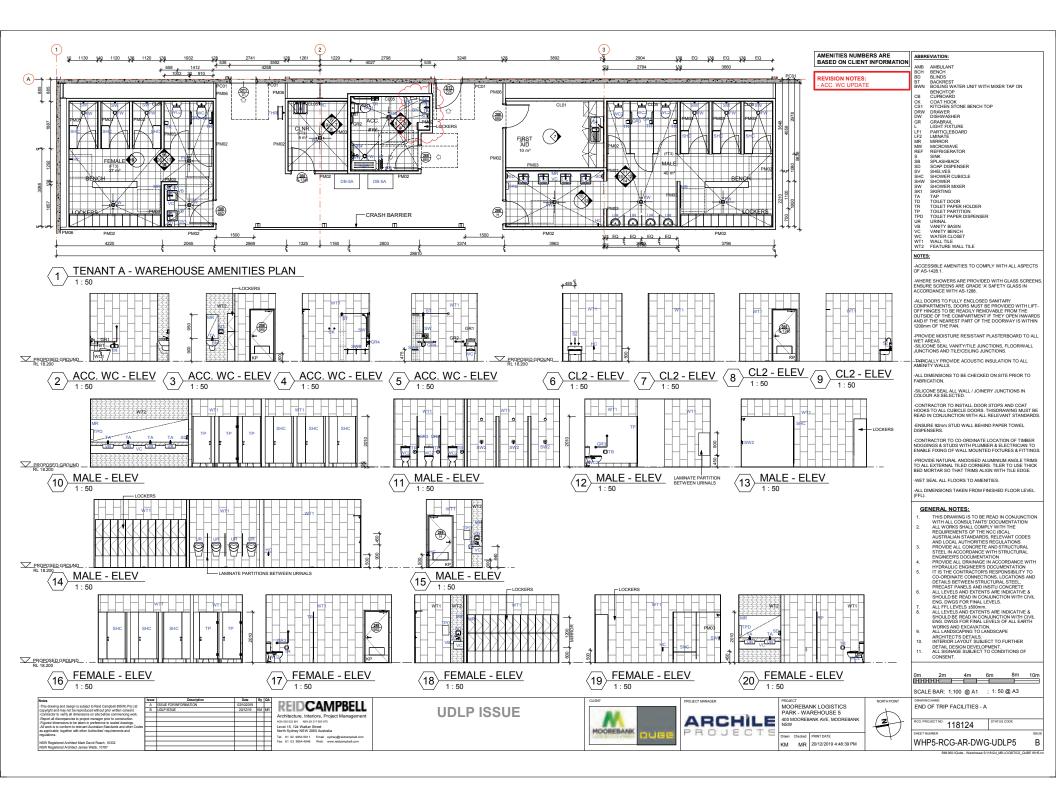

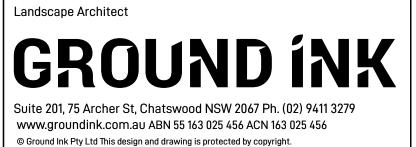

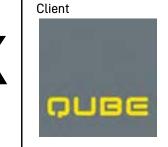




REIDCAMPBELL ARCH Level 15, 124 Walker Street North Sydney NSW 2060, Australia (02) 9954 5011 https://www.reidcampbell.com/

Architect



	Note	Issue	Date	Description	Drawn	Checked	Drawing Title		
		А	05.08.20	Preliminary for coordination	KF	RL	5		
	Architect prior to construction. Figured dimensions to be taken in preference to scaled drawings.								
	All work is to conform to relevant Australian standards and other codes as applicable.							WARE	
CTS									
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								E.	U
	Plant species and quantities snown are indicative only and are subject to change based on future project requirements.								
	· ·								
	Verify all dimensions on site before commencing work. Report all discrepancies to Landscape Architect prior to construction. Figured dimensions to be taken in preference to scaled drawings. All work is to conform to relevant Australian standards and other codes as applicable. Location of underground services to be proven on site and protected if necessary prior to construction. Dial before you dig.	Issue A			-		Drawing Title	WA	REF E

KEY PLAN

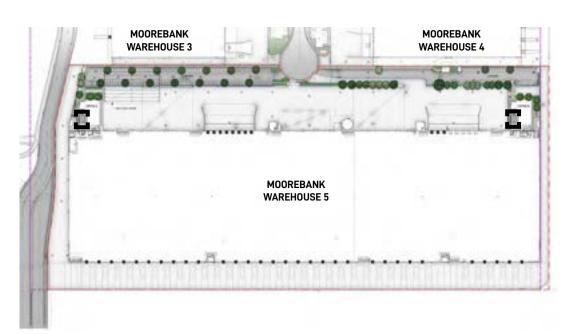


PRELIMINARY FOR COORDINATION

IOUSE 5 TYPICAL OMBA PLAN

Date	Job Number	Drawn	Checked	Drawing Number
05-08-20	20190511	KF	RL	WHP5-GNK-LN-DWG-1206
Project				North
Wareho	ouses 5 UI	DLP		
Mooreban	k Logistics Pa	irk, Moore	bank NSW	
Scale 1:50	@ A1			Rev
0 2.5 5 I I I	7.5 1m I I			Α



Appendix 3 – Area 3 Cycle and Pedestrian Access and Facilities Drawings and Figures

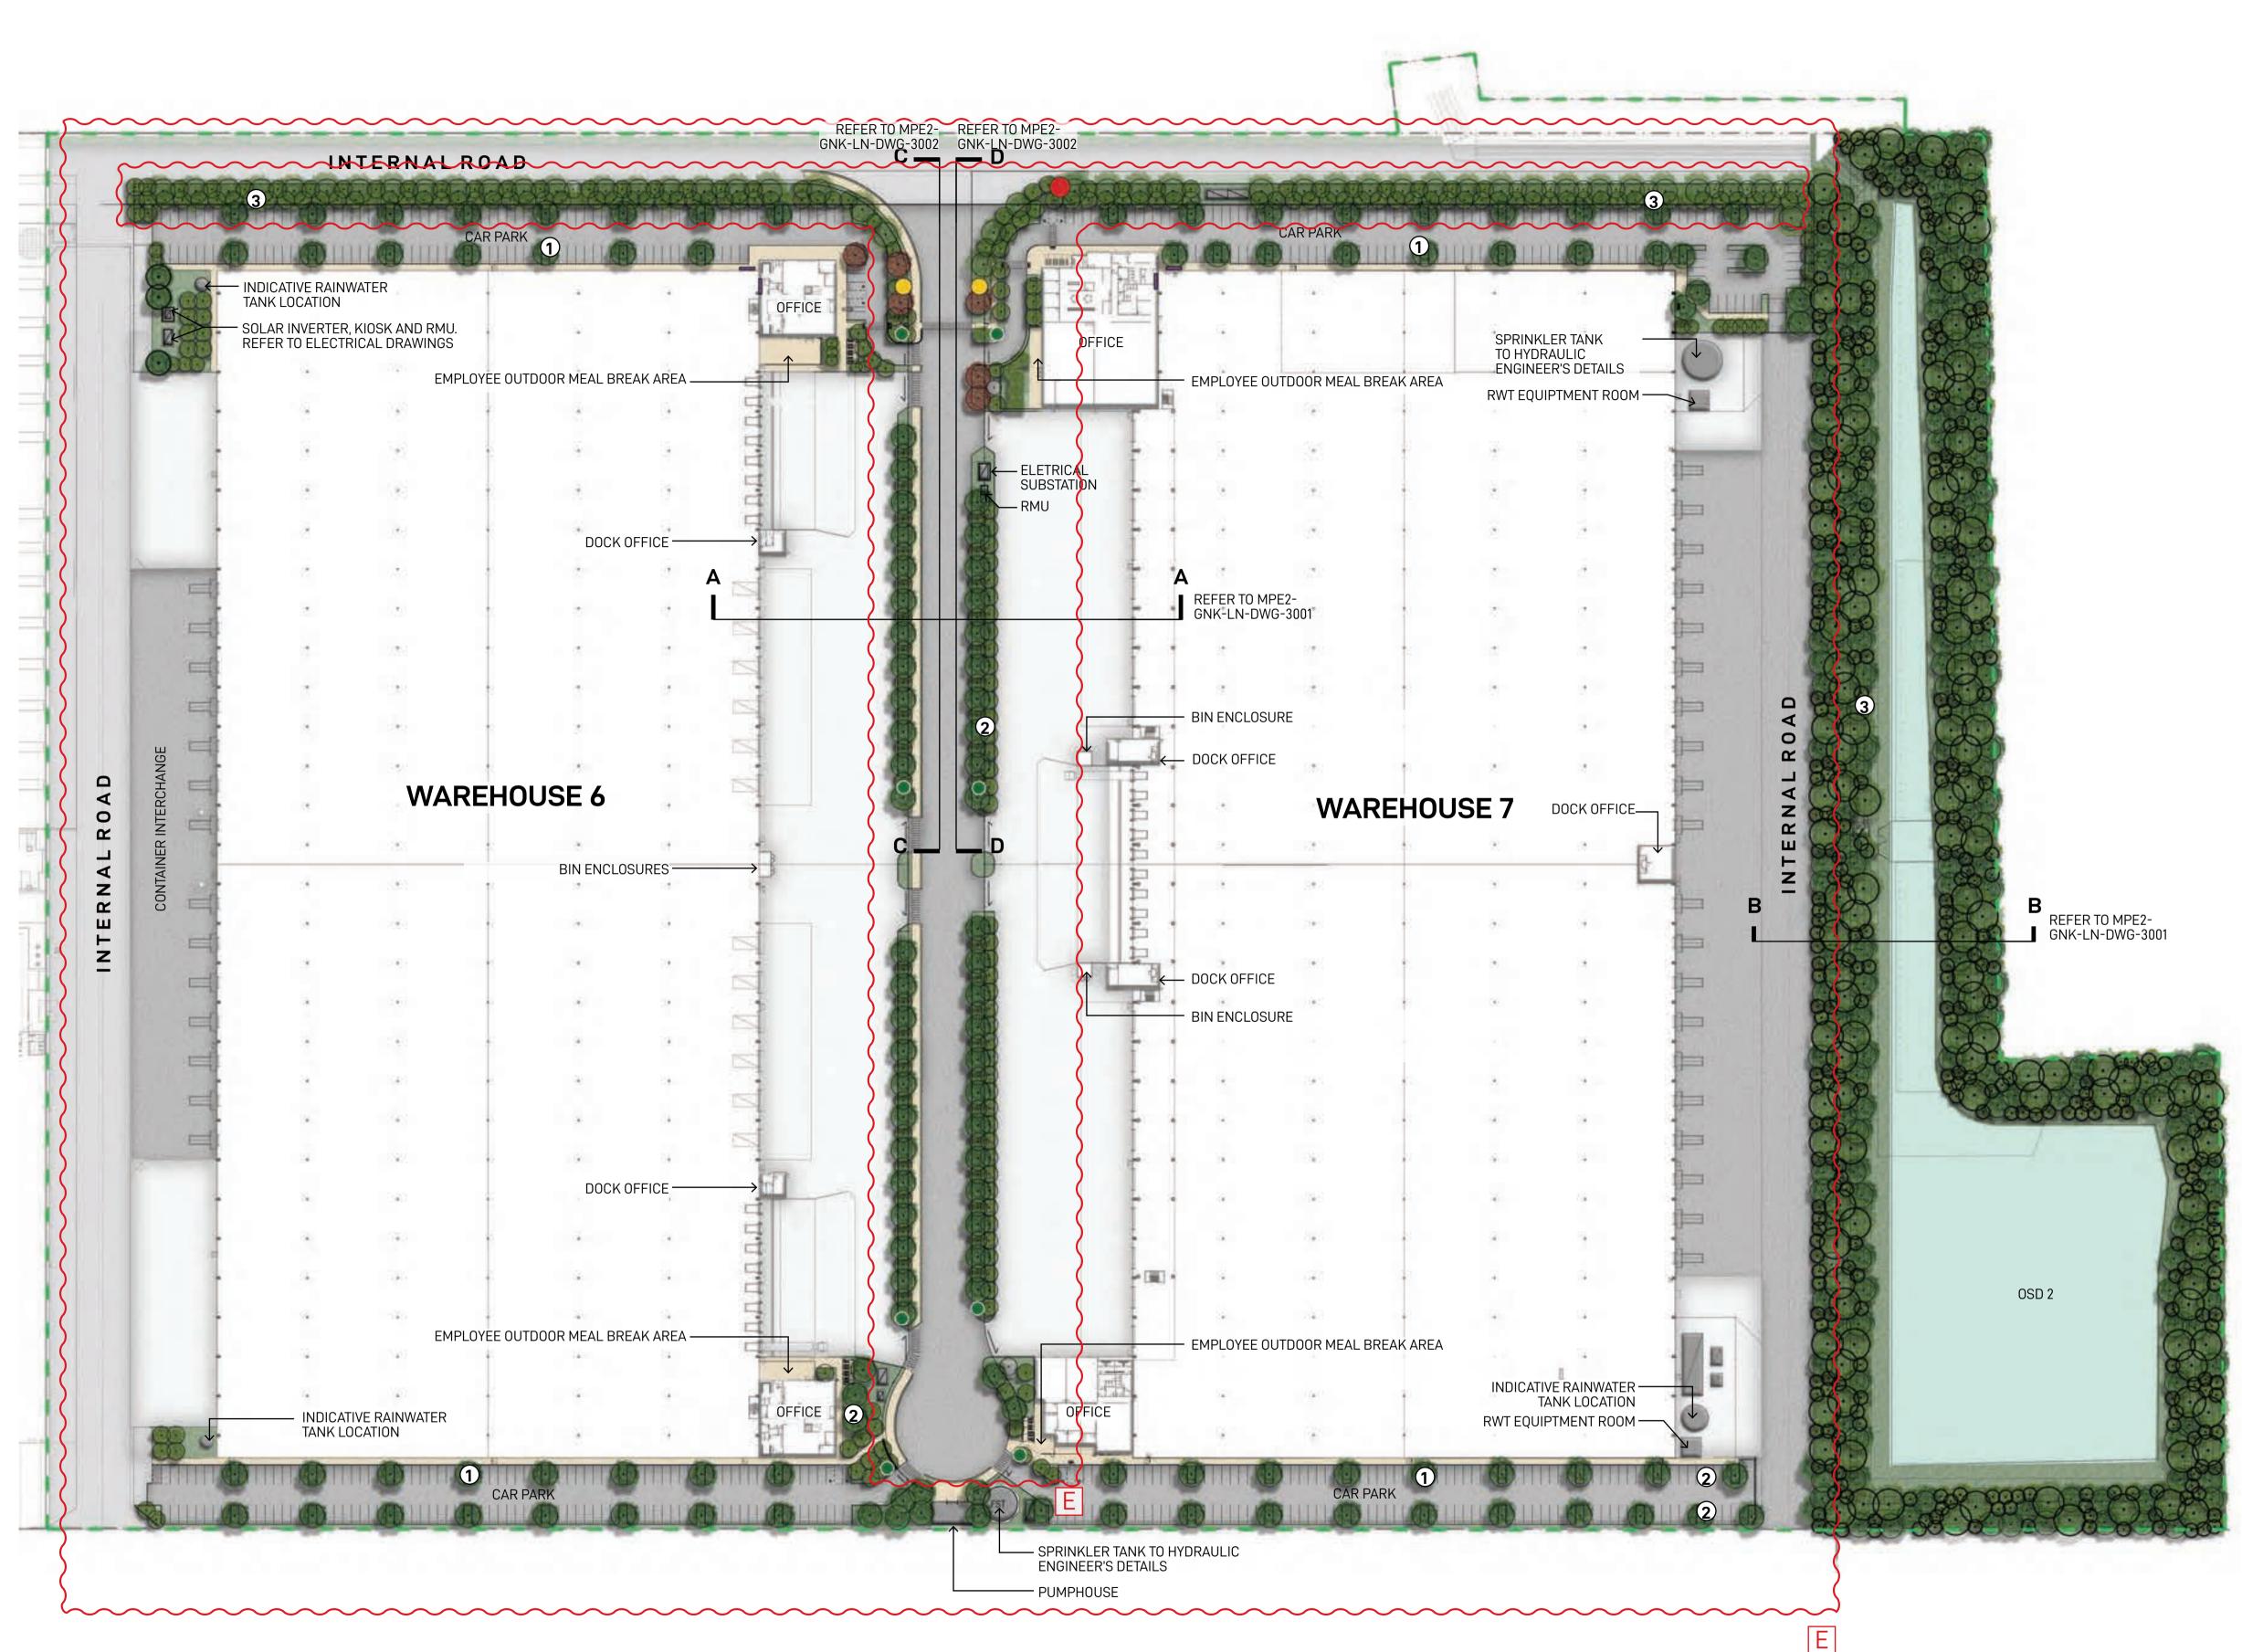



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Landscape Architect



29/88 Phillip Street, Sydney, NSW 2000

Ph. (02) 81973900

www.logosproperty.com.au




www.watsonyoung.com.au



Note Verify all dimensions on site before commencing work. Report all discrepancies to Landscape Architect prior to construction. Figured dimensions to be taken in preference to scaled drawings. All work is to conform to relevant Australian standards and other codes as applicable. Location of underground services to be proven on site and protected if necessary prior to construction. Dial before you dig. Plant species and quantities shown are indicative only and are subject to change based on future project requirements.

Issue Date Description A 04.06.20 Issue for Coordination B 28.10.20 Issue for Coordination C 28.10.20 Issue for Coordination D 16.12.20 Issue for Coordination E 21.07.22 Issue for Coordination

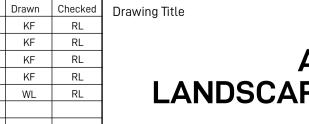


KF RL KF RL

KF RL

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KEY PLAN



LEGEND

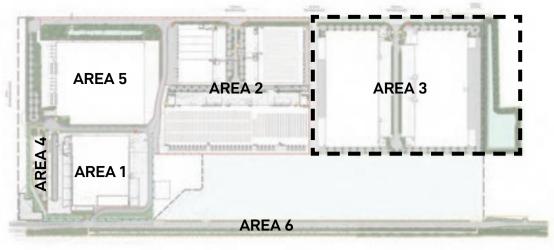
	Area 3 Boundary
	Hard Landscaping
	Proposed Garden Bed
8.8	Proposed Canopy Trees
	Proposed OSD
	Type 1 Street Signage
\bigcirc	Type 2 Tenant Identification Signage
	Type 3 Direction Signage
	Type 4 Corporate Signage
1	Proposed canopy tree planting in 2.5M carpark bays spaced at every 6-8 car spaces providing amenity and visual screening of proposed warehousing in accordance with condition b140(e)(iii) & b140(e)(vi)
2	Proposed enlarged parking bays

Proposed mix of native canopy trees and shrubs providing visual mitigation of proposed warehouses

<u>NOTE</u>

Elements shown in plans are indicative and are subject to final design

INDICATIVE TREE IMAGES

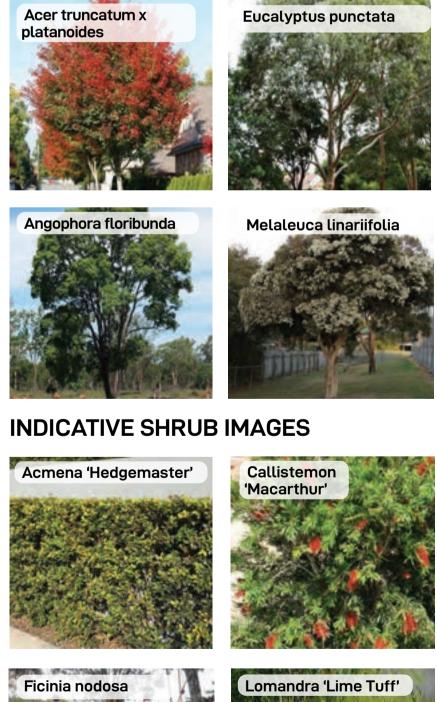



FOR COORDINATION


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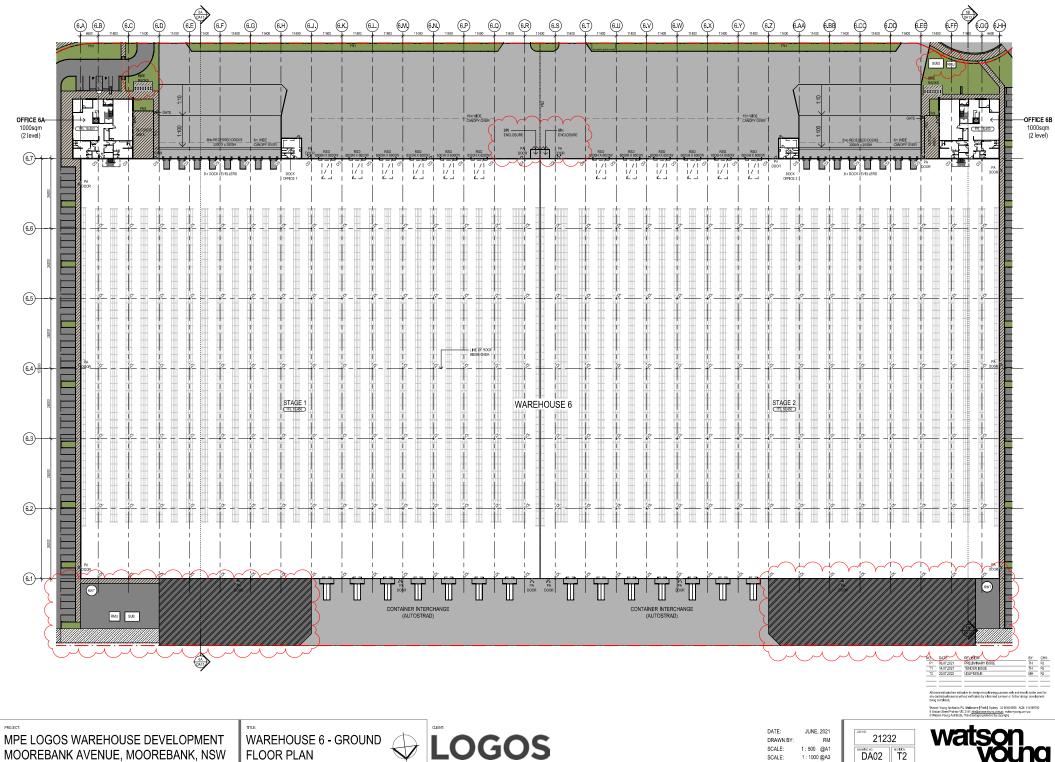
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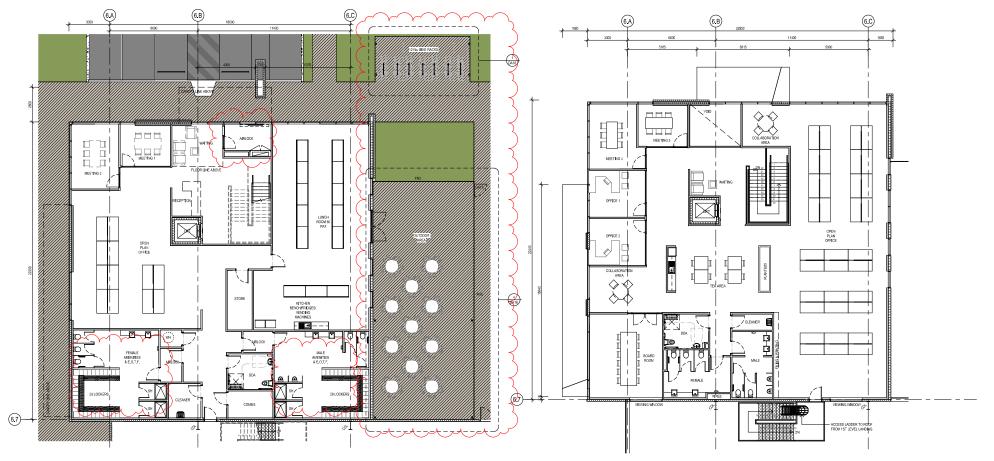



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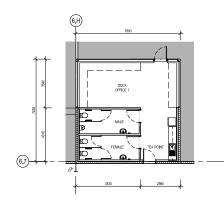
Date

Job Number Drawn Checked





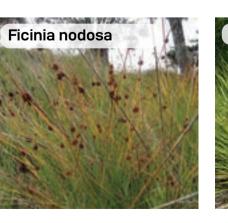

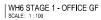

WH6 DOCK OFFICE 1 SCALE: 1:100

PROJECT:

WH6 STAGE 1 - OFFICE FF



MPE LOGOS WAREHOUSE DEVELOPMENT MOOREBANK AVENUE, MOOREBANK, NSW VAREHOUSE 6 STAGE 1 - OFFICE & E.O.T.F. FLOOR PLANS


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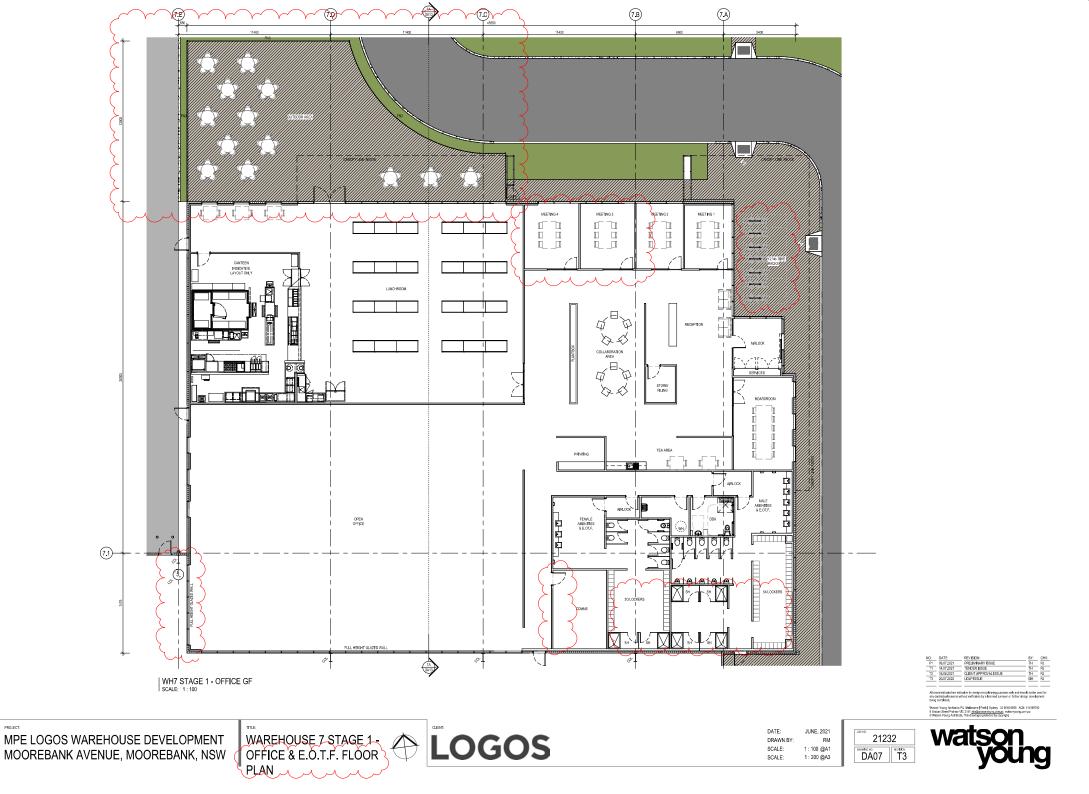
DATE: JUNE, 2021 DRAWN BY: RM SCALE: 1:100 @A1 SCALE: 1:200 @A3

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watson

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JUNE, 2021

1:100 @A1

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DA08 T3

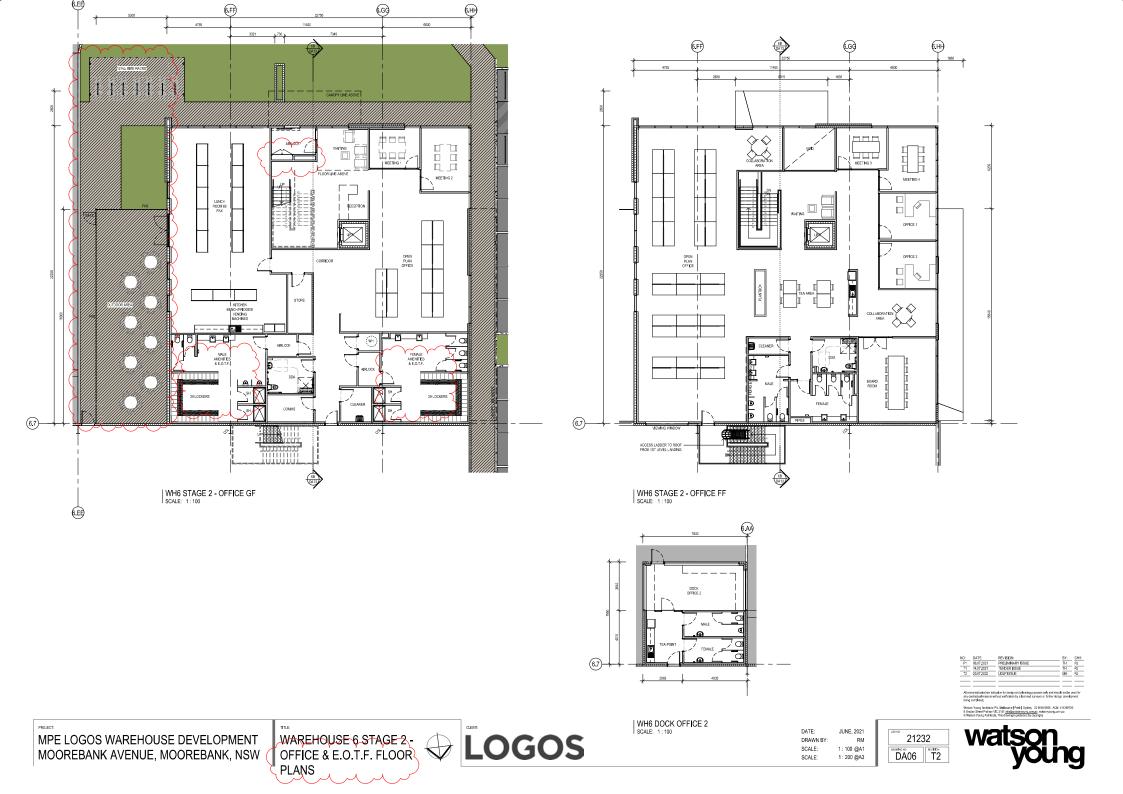MPE LOGOS WAREHOUSE DEVELOPMENT MOOREBANK AVENUE, MOOREBANK, NSW TITLE:

PLANS


WAREHOUSE 7 STAGE 2-OFFICE & E.O.T.F. FLOOR

(7.1)-

PROJECT:



Appendix 4 – Areas 4 and 5 Typical Cycle and Pedestrian Access and Facilities Drawings and Figures

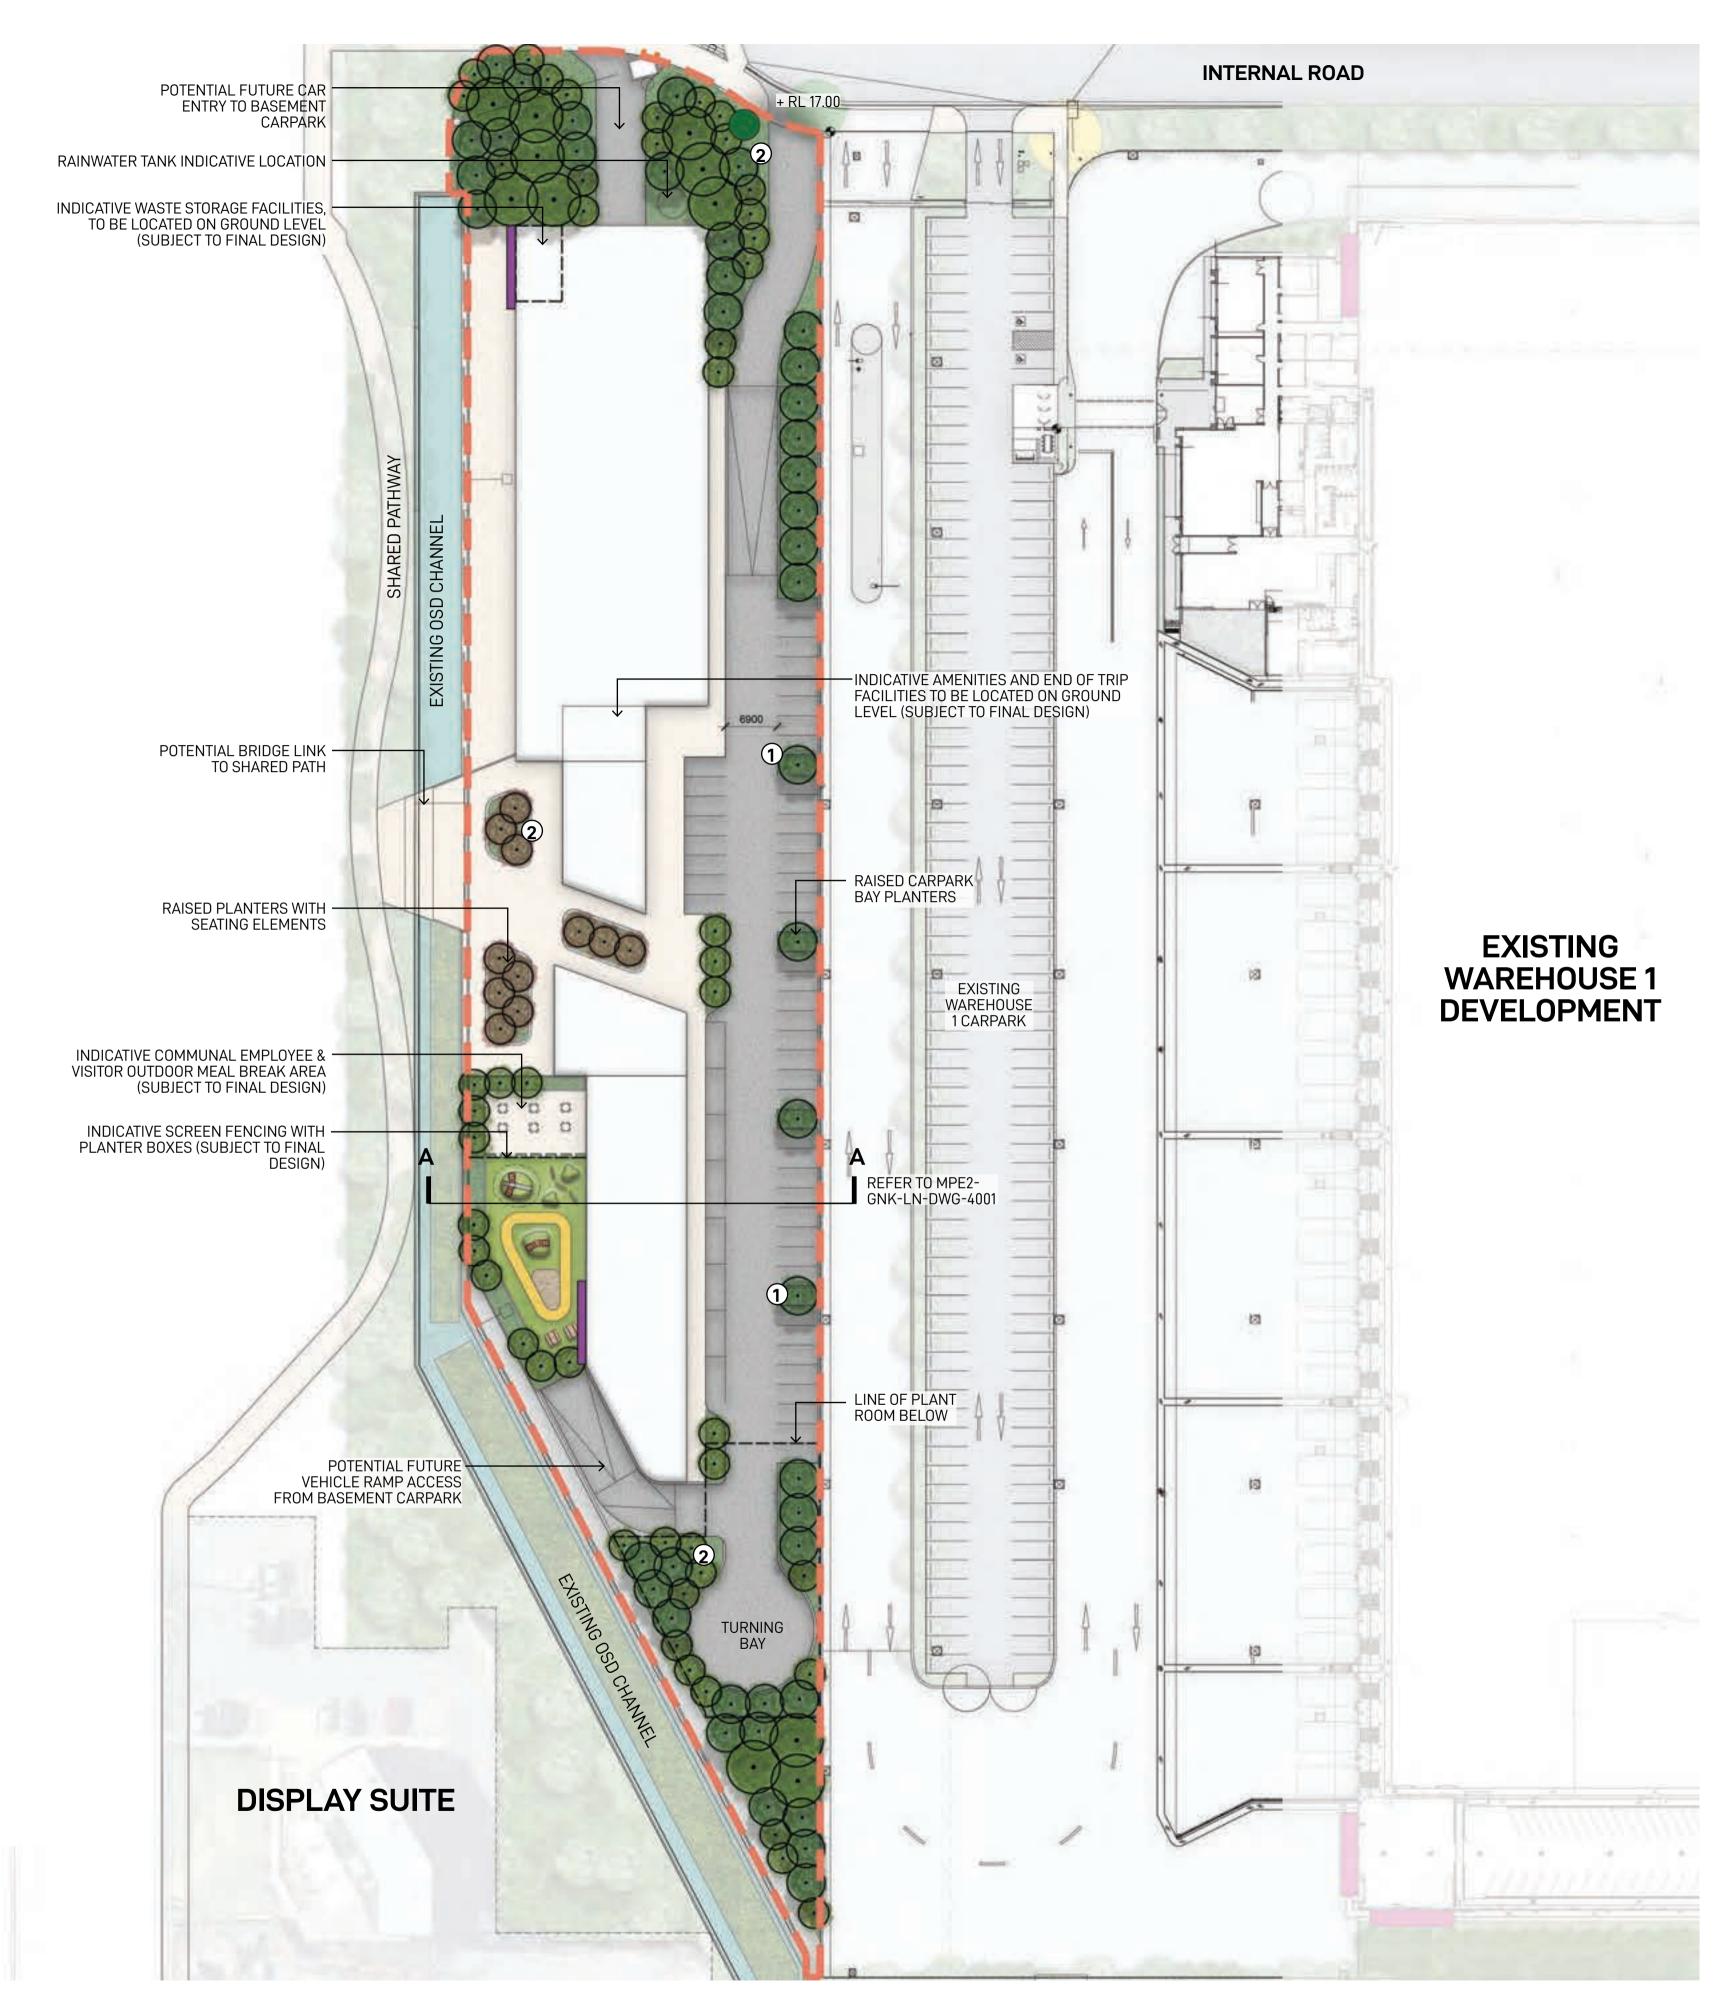



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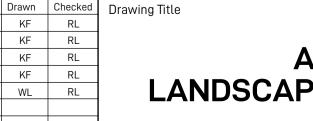




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Verify all dimensions on site before commencing work. Report all discrepancies to Landscape Architect prior to construction. Figured dimensions to be taken in preference to scaled drawings.	В	28
All work is to conform to relevant Australian standards and other adds as applicable	С	28
All work is to conform to relevant Australian standards and other codes as applicable.	D	16
Location of underground services to be proven on site and protected if necessary prior to construction. Dial before you dig.	E	21
Plant species and quantities shown are indicative only and are subject to change based on future		
project requirements.		

Date	Description
04.06.20	Issue for Coordination
28.10.20	Issue for Coordination
28.10.20	Issue for Coordination
16.12.20	Issue for Coordination
21.07.22	Issue for Coordination




KF RL KF RL

KF RL

KF RL

WL RL

KEY PLAN

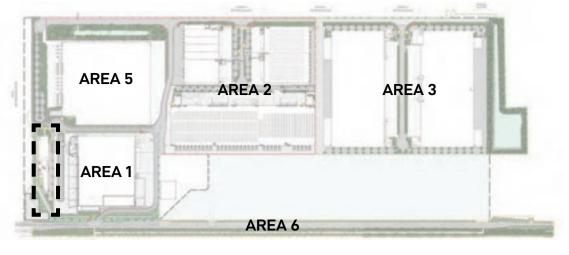

LEGEND



1

Pedestrian Path Proposed Garden Bed

Proposed Canopy Trees

Type 3 Direction Signage

Type 4 Corporate Signage

Proposed canopy tree planting in 2.5M carpark bays spaced at every 6-8 car spaces providing amenity and visual screening of proposed warehousing in accordance with condition b140(e)(iii) & b140(e)(vi)

Proposed mix of native canopy trees and shrubs providing visual amenity


<u>NOTE</u>

- Indicative building footprints are representative of approximately 8,000m² GFA (Subject to future building design)
- Elements shown in plans are indicative and are subject to final design

AREA 4	
PE MASTERPL	.AN

FOR COORDINATION

Date	Job Numbe	r Drawn	Checked	Drawing Number
21.07.22	2020042	1 WL	RL	MPE2-GNK-LN-DWG-4000
Project				North
Moore	bank Pi	recinct	East	
Mooreban	k Logistics	Park, Moore	ebank NSW	
Scale 1:50	0 @ A1			Rev
0 2.5 5 I I I	7.5 10 I I	12.5m I		E

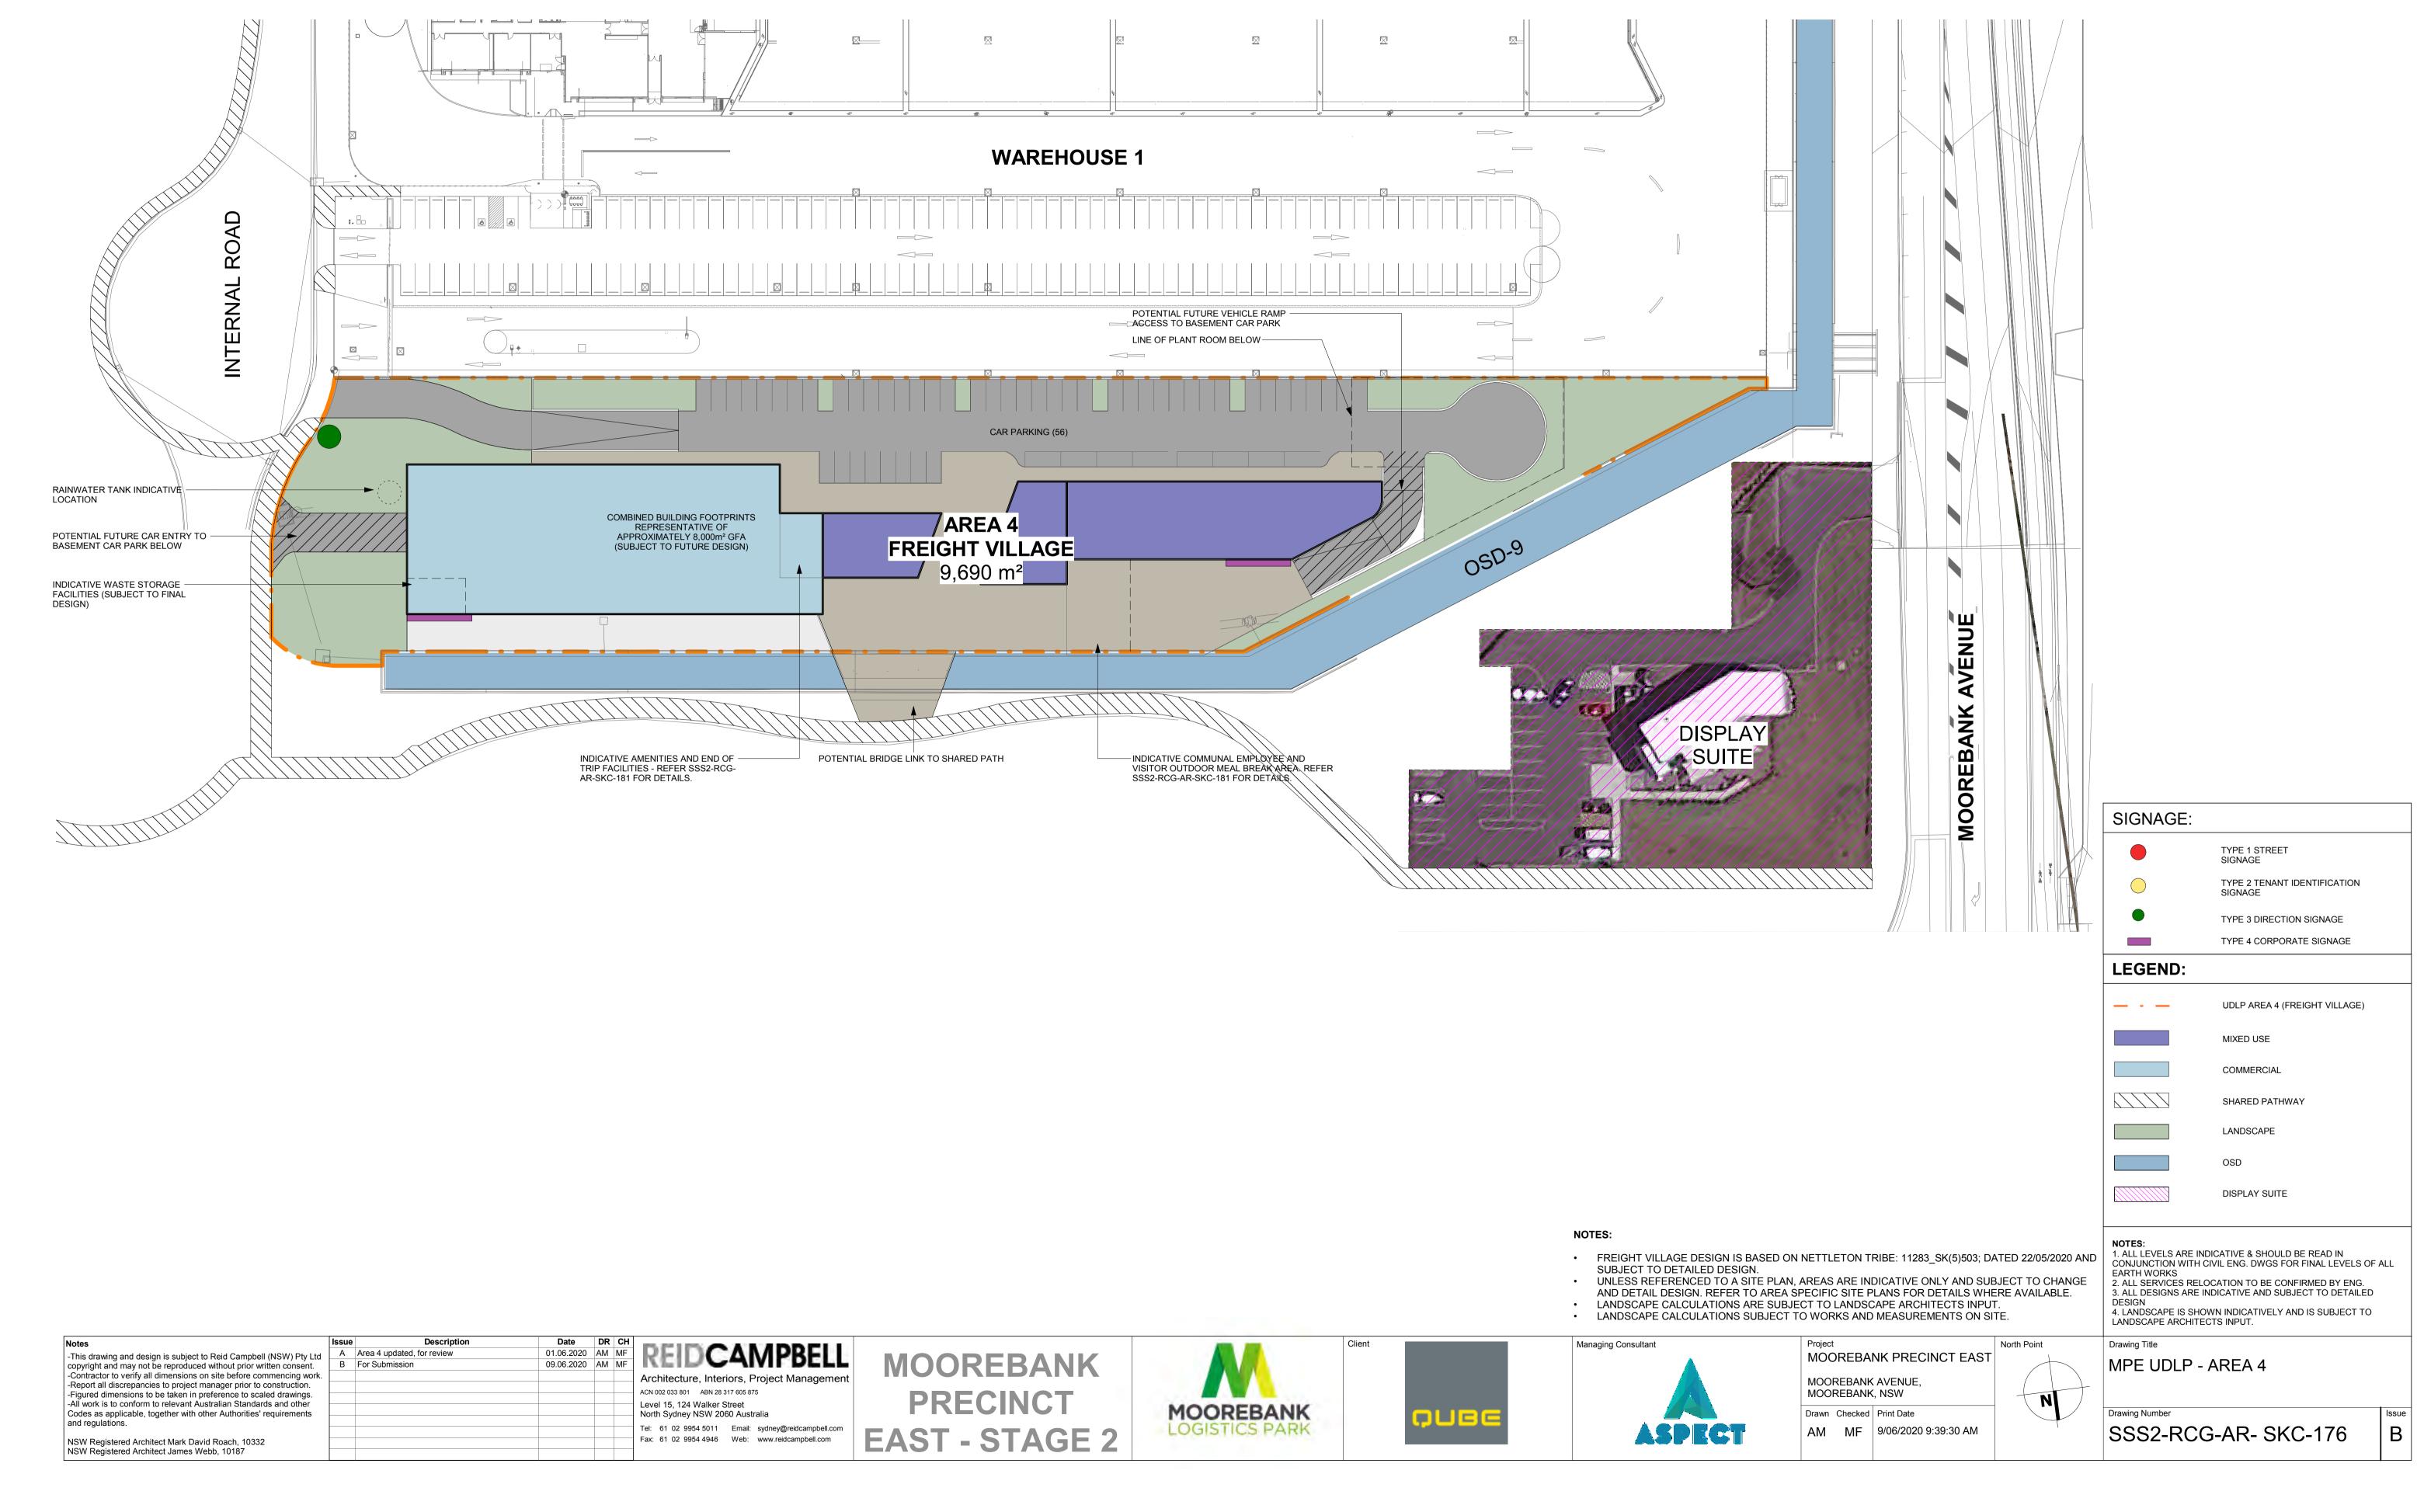


Notes	Issue	Description	Date		СН		
-This drawing and design is subject to Reid Campbell (NSW) Pty Ltd	Α	Area 4 updated, for review	01.06.2020	AM	MF	REIDCAMPBELL	
copyright and may not be reproduced without prior written consent.	В	For Submission	09.06.2020	AM	MF		Ν
-Contractor to verify all dimensions on site before commencing work.						Architecture, Interiors, Project Management	
-Report all discrepancies to project manager prior to construction.						ACN 002 033 801 ABN 28 317 605 875	
-Figured dimensions to be taken in preference to scaled drawings. -All work is to conform to relevant Australian Standards and other							
Codes as applicable, together with other Authorities' requirements						Level 15, 124 Walker Street North Sydney NSW 2060 Australia	
and regulations.							
						Tel: 61 02 9954 5011 Email: sydney@reidcampbell.com	
NSW Registered Architect Mark David Roach, 10332						Fax: 61 02 9954 4946 Web: www.reidcampbell.com	EA
NSW Registered Architect James Webb, 10187							







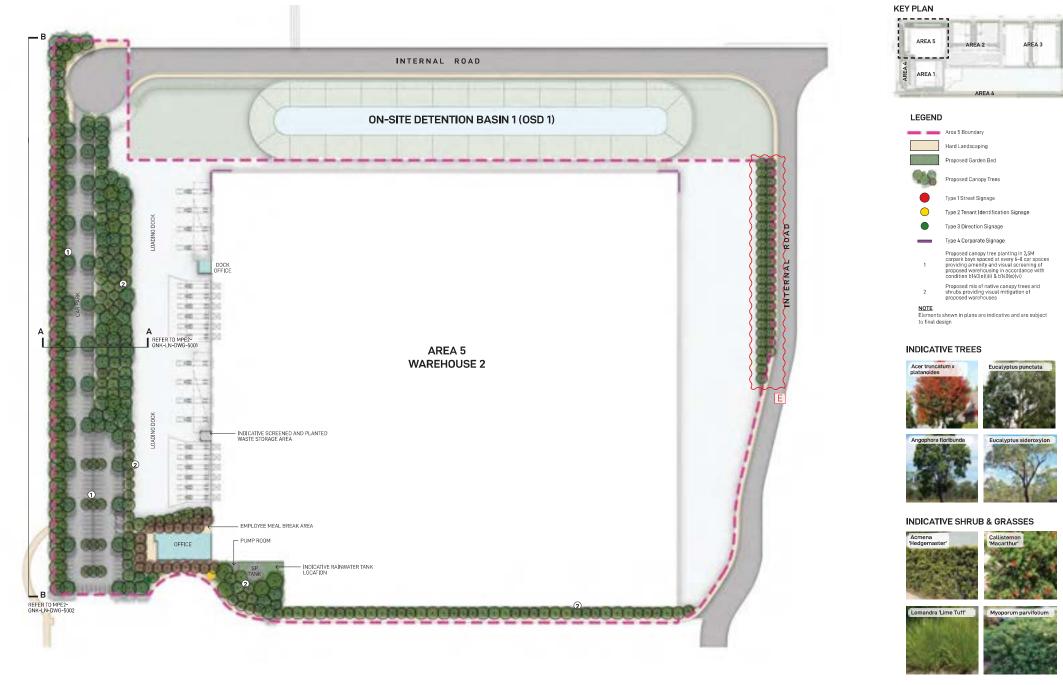

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Date Job Number Drawn 21.07.22 20200421 WL RL MPE2-GNK-LN-DWG-5000 Moorebank Precinct East Moorebank Logistics Park, Moorebank NS cale 1:750 @ A1 E 0 5 10 15 20m 1 1 1 1 1

watsSing 15 Blue Street, North Sydney NSW 2060 Ph. (02) 83290730 www.watsonyoung.com.a

Architect

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LOGOS

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www.logosproperty.com.au

Landscape Architect

GROUND ÍNK

Suite 201, 75 Archer St, Chatswood NSW 2067 Ph. (02) 9411 3279 www.groundink.com.au ABN 55 163 025 456 ACN 163 025 456

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ASPECT Suite 117 / 25 Solent Circuit Baulkham Hills NSW 2153 Ph. 0409 515 535

Project Manage

Verify all dime ions on site before commencing work. Report all discrepa construction. Flowred dimensions to be taken in preferen-All work is to conform to relevant Australian standards and other codes as applicable. Location of underground services to be proven on site and protected if necessary prior to construction. Dial before you dia. Plant species and quantities shown are indicative only and are subject to change based on futu project requirements.

A 04.06.20 Issue for Coordinatio B 28.10.20 Issue for Coordinatio C 28.10.20 Issue for C D 16.12.20 Issue for E 21.07.22 Issue for


Issue

KF RL AREA 5 KF RL KF RL WL RL LANDSCAPE MASTERPLAN

Drawn

Checked Drawing Title

Brawn Checked

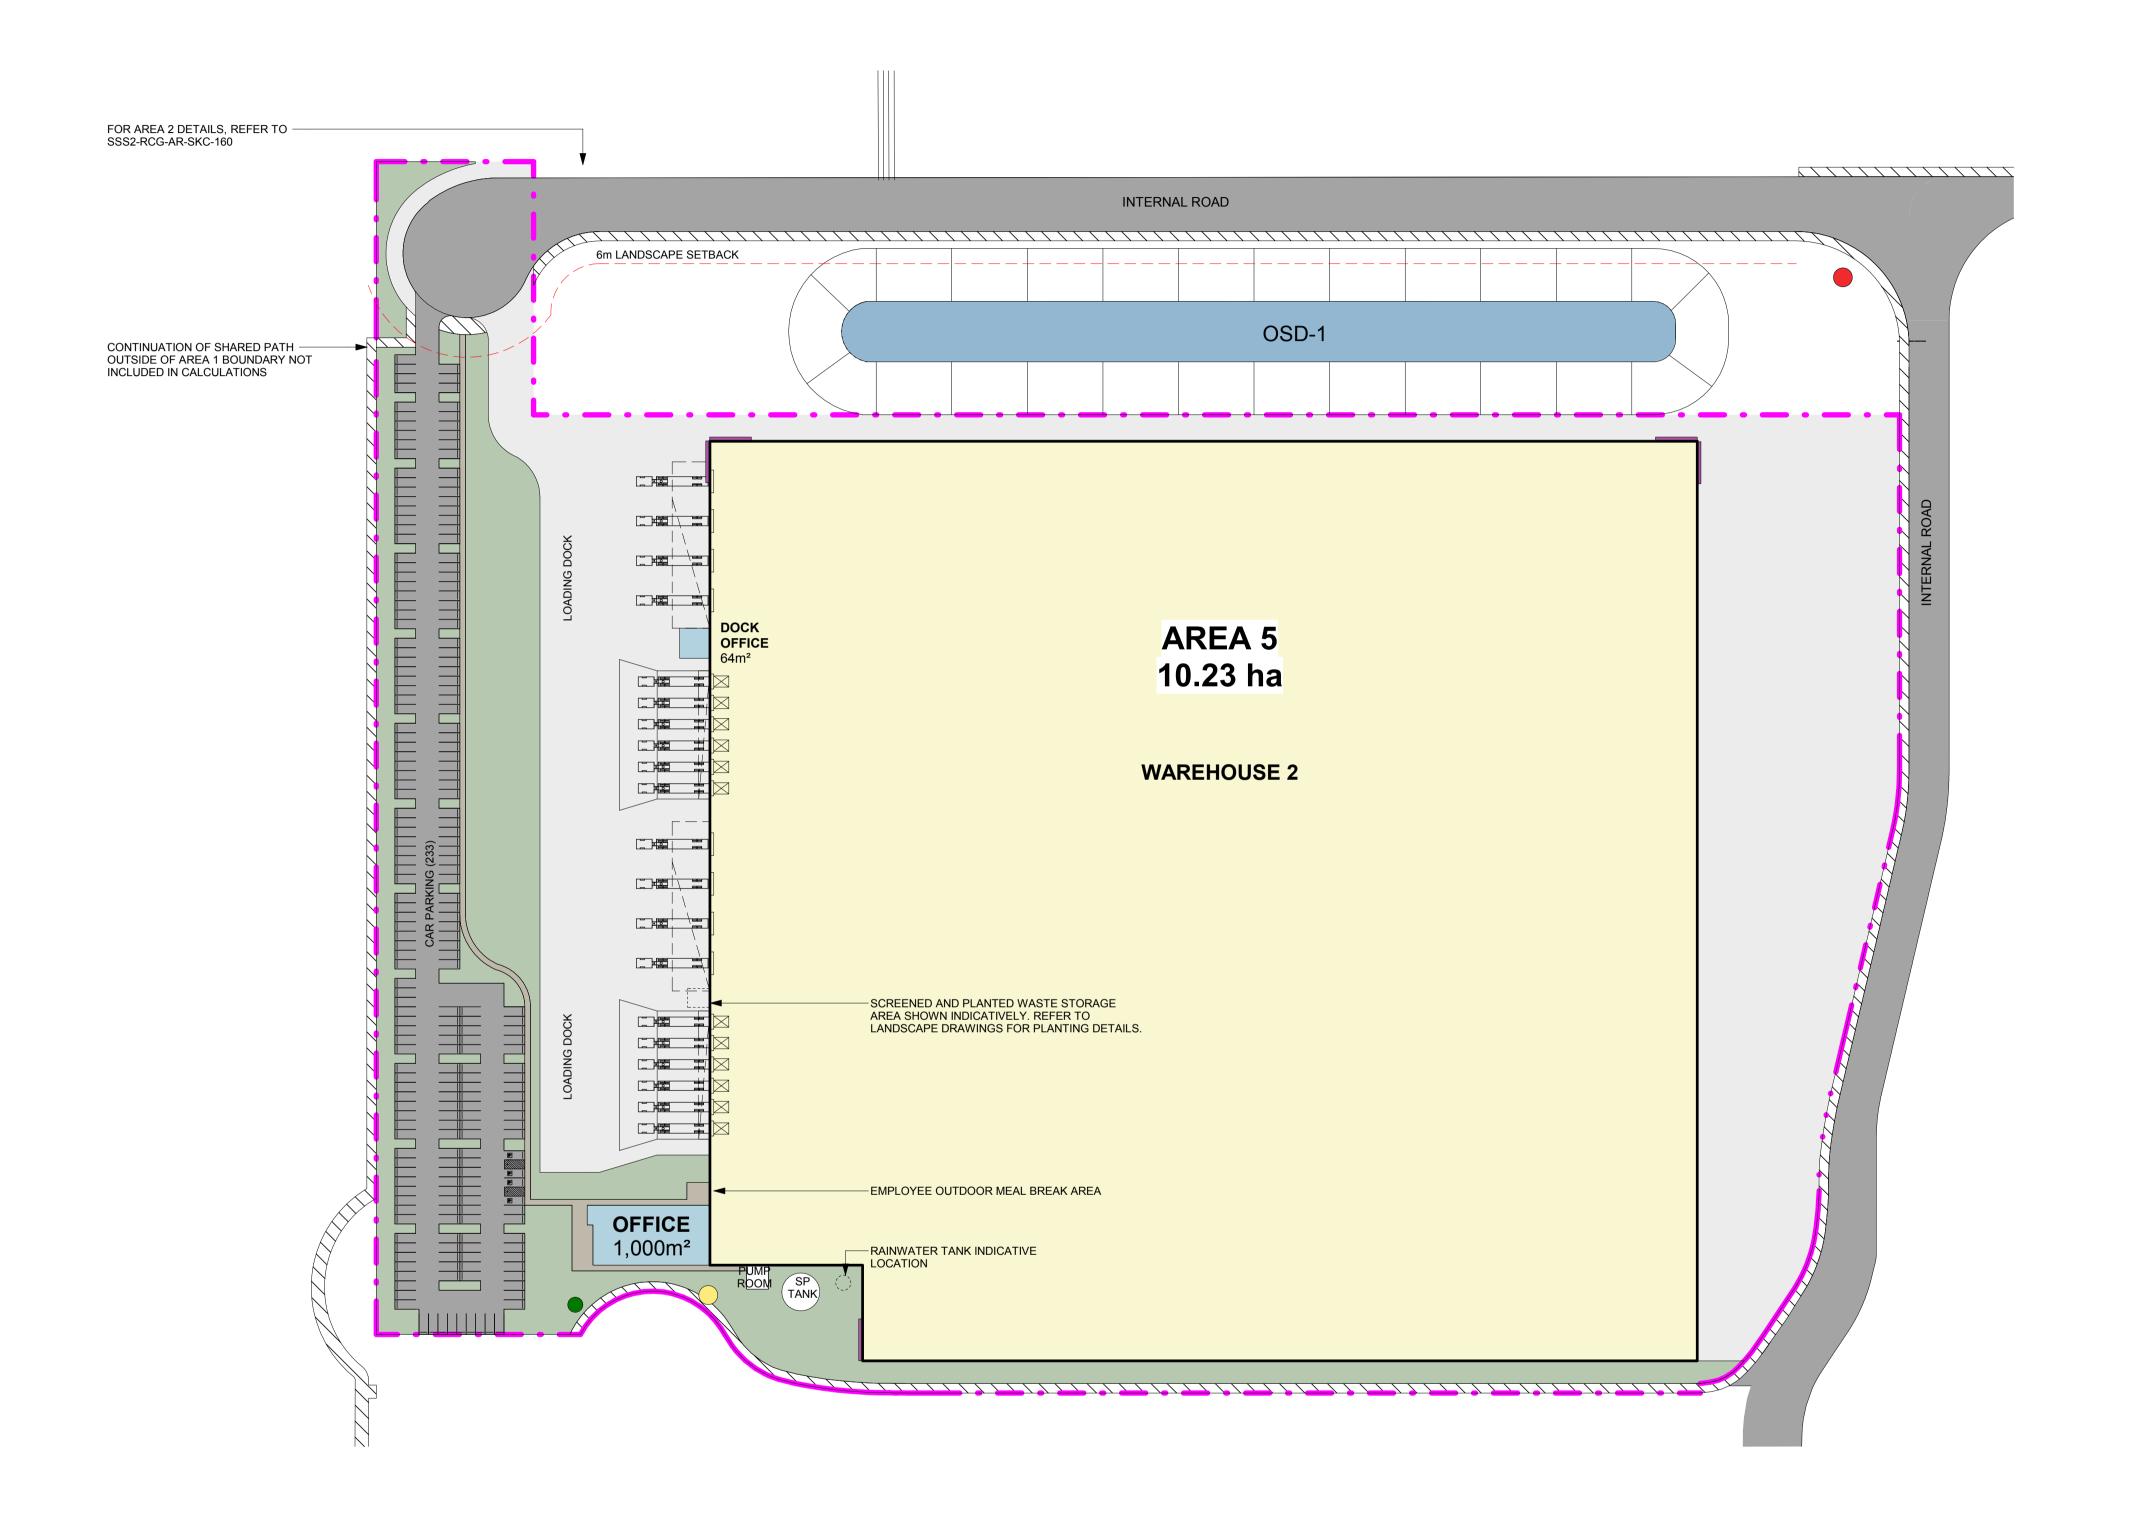

Notes	Issue	Description	Date	DR	CH		
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NSW Registered Architect Mark David Roach, 10332						Fax: 61 02 9954 4946 Web: www.reidcampbell.com	
NSW Registered Architect James Webb, 10187							
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NOTES:

- UNLESS REFERENCED TO A SITE PLAN, AREAS
- AND DETAIL DESIGN. REFER TO AREA SPECIFIC
 LANDSCAPE CALCULATIONS ARE SUBJECT TO L
 LANDSCAPE CALCULATIONS SUBJECT TO WORK



IOOREBANK PRECINCT AST - STAGE 2







Client

	TYPE 1 STREET SIGNAGE
	TYPE 2 TENANT IDENTIFICATION SIGNAGE
	TYPE 3 DIRECTION SIGNAGE
	TYPE 4 CORPORATE SIGNAGE
	LEGEND:
	UDLP AREA 2
	WAREHOUSE
	OFFICE
	SHARED PATHWAY
	LANDSCAPE
	OSD
S ARE INDICATIVE ONLY AND SUBJECT TO CHANGE IC SITE PLANS FOR DETAILS WHERE AVAILABLE. D LANDSCAPE ARCHITECTS INPUT. ORKS AND MEASUREMENTS ON SITE.	NOTES: 1. ALL LEVELS ARE INDICATIVE & SHOULD BE READ IN CONJUNCTION WITH CIVIL ENG. DWGS FOR FINAL LEVELS OF ALL EARTH WORKS 2. ALL SERVICES RELOCATION TO BE CONFIRMED BY ENG. 3. ALL DESIGNS ARE INDICATIVE AND SUBJECT TO DETAILED DESIGN 4. LANDSCAPE IS SHOWN INDICATIVELY AND IS SUBJECT TO LANDSCAPE ARCHITECTS INPUT.
t DREBANK PRECINCT EAST REBANK AVENUE,	Drawing Title MPE UDLP - AREA 5
Checked Print Date	Drawing Number Issue
MF 19/06/2020 9:40:12 AM	SSS2-RCG-AR- SKC-177

SIGNAGE:

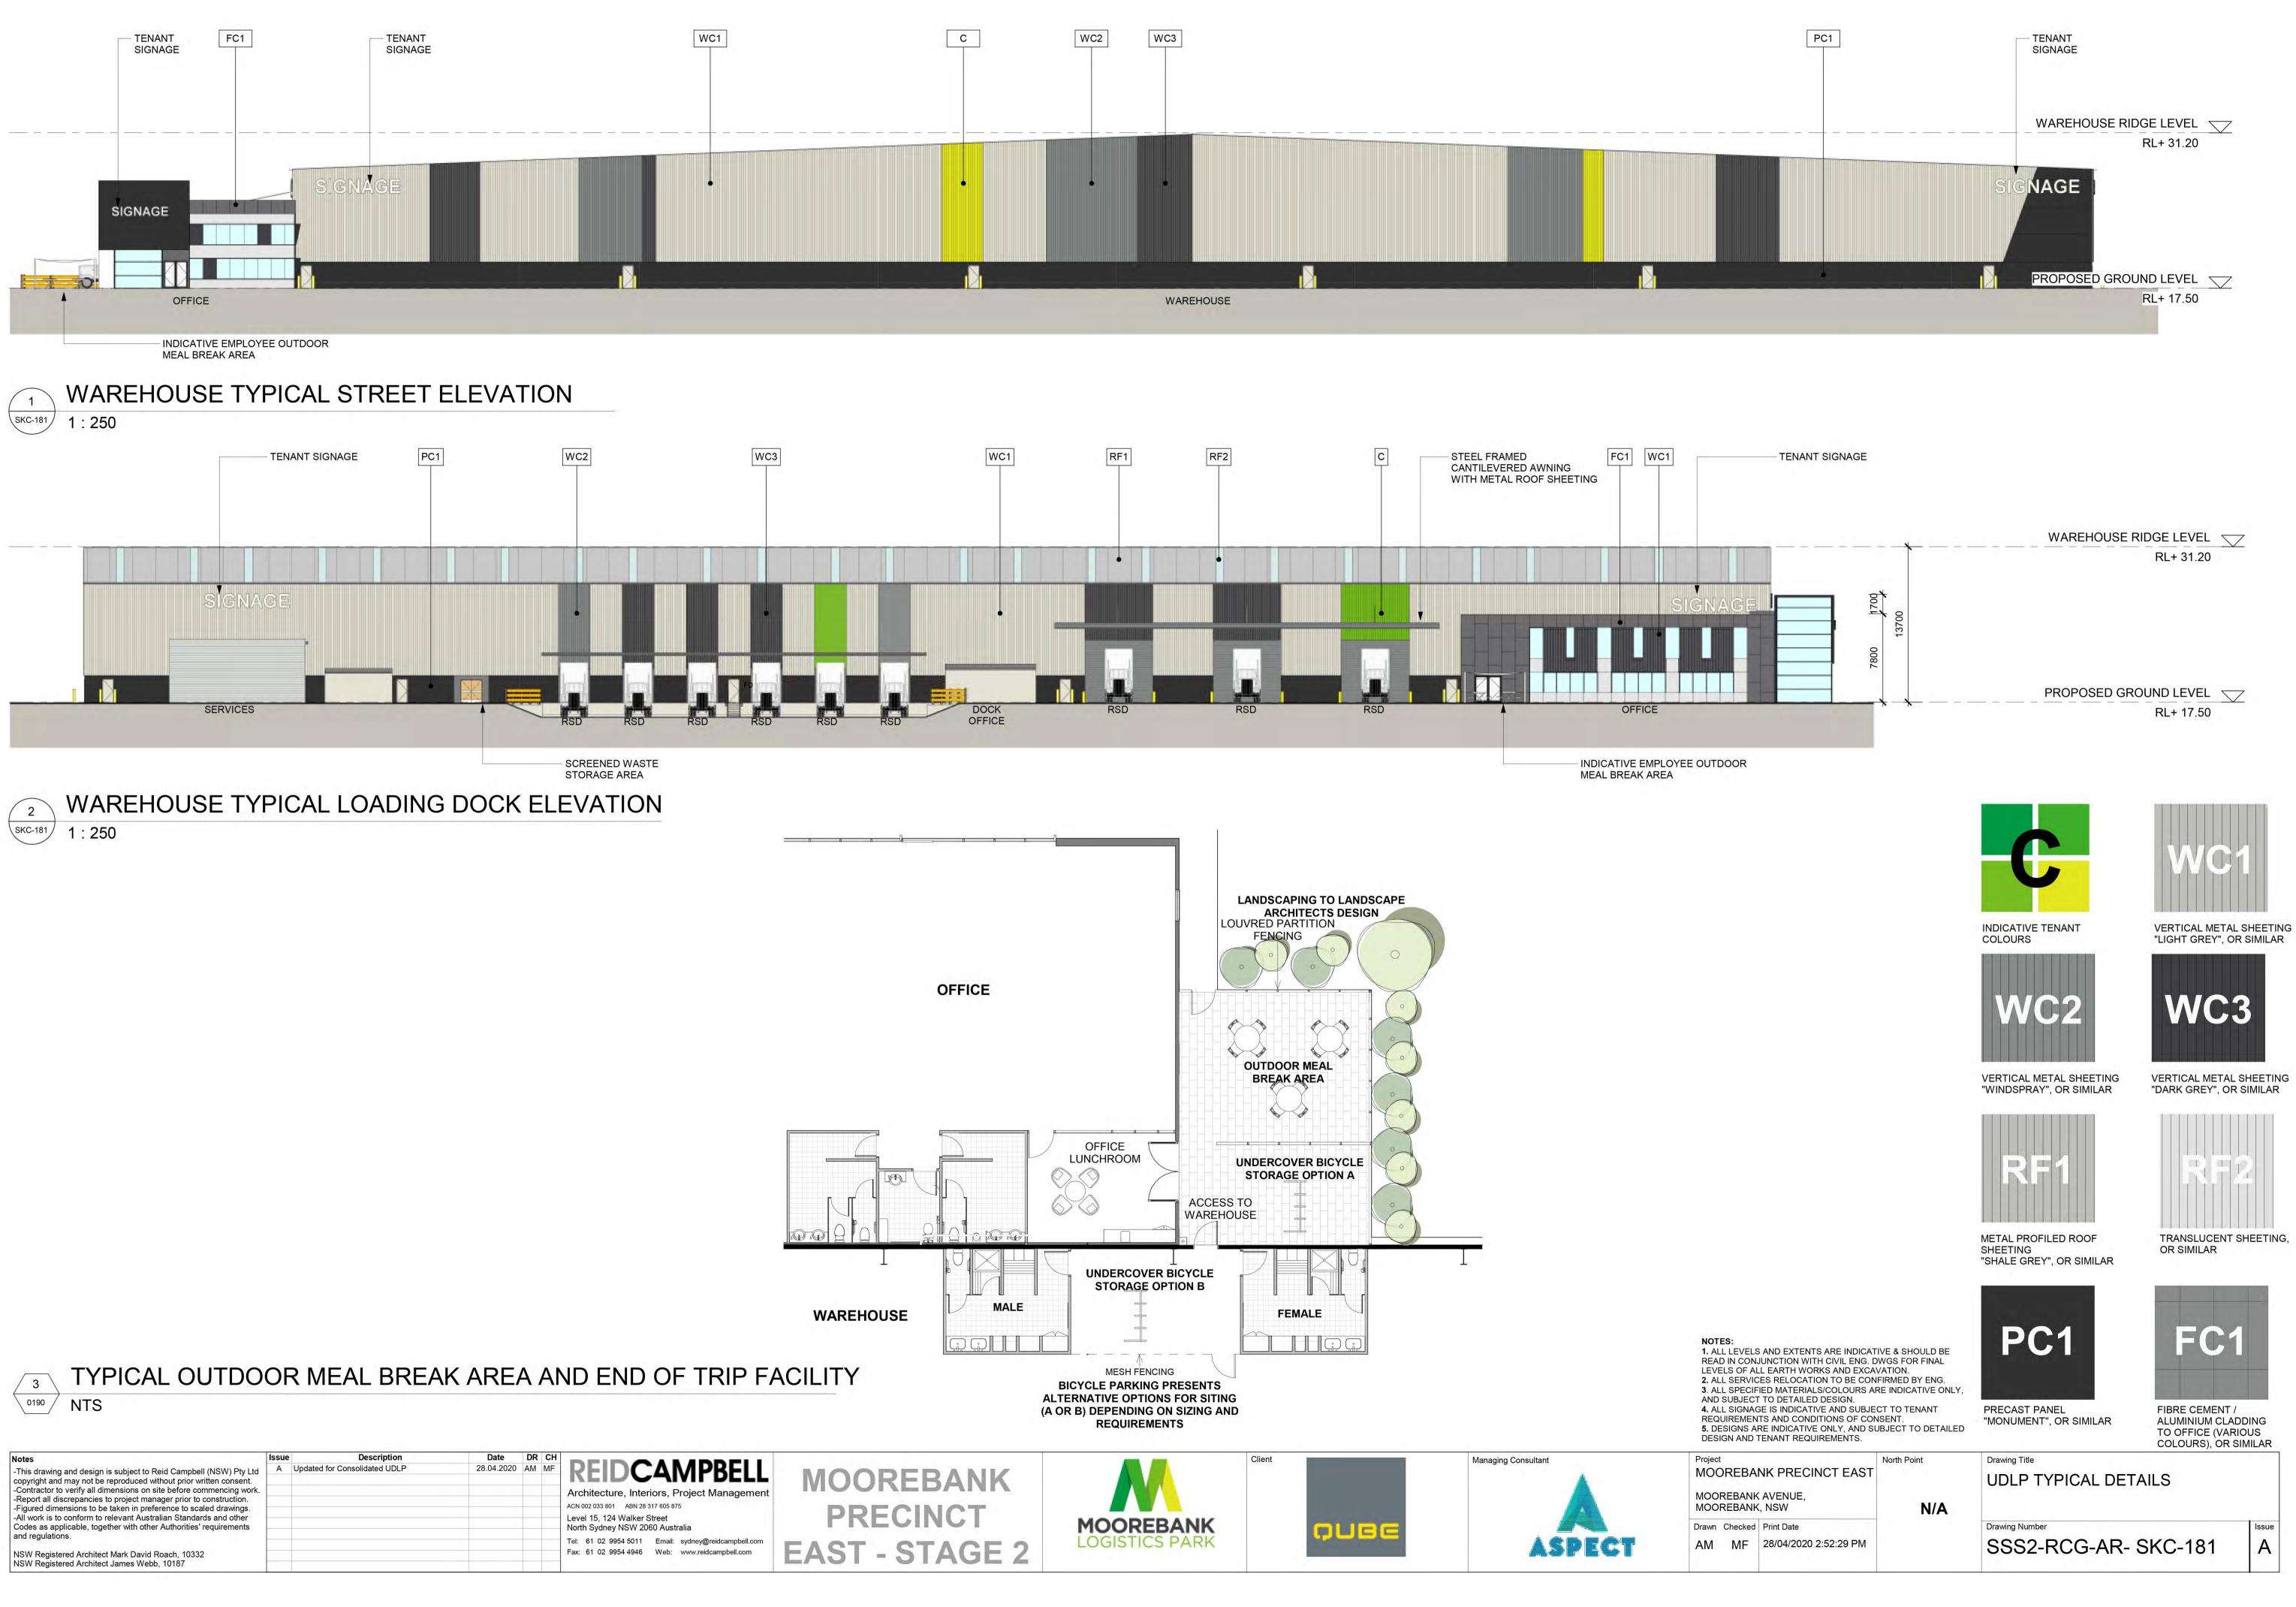

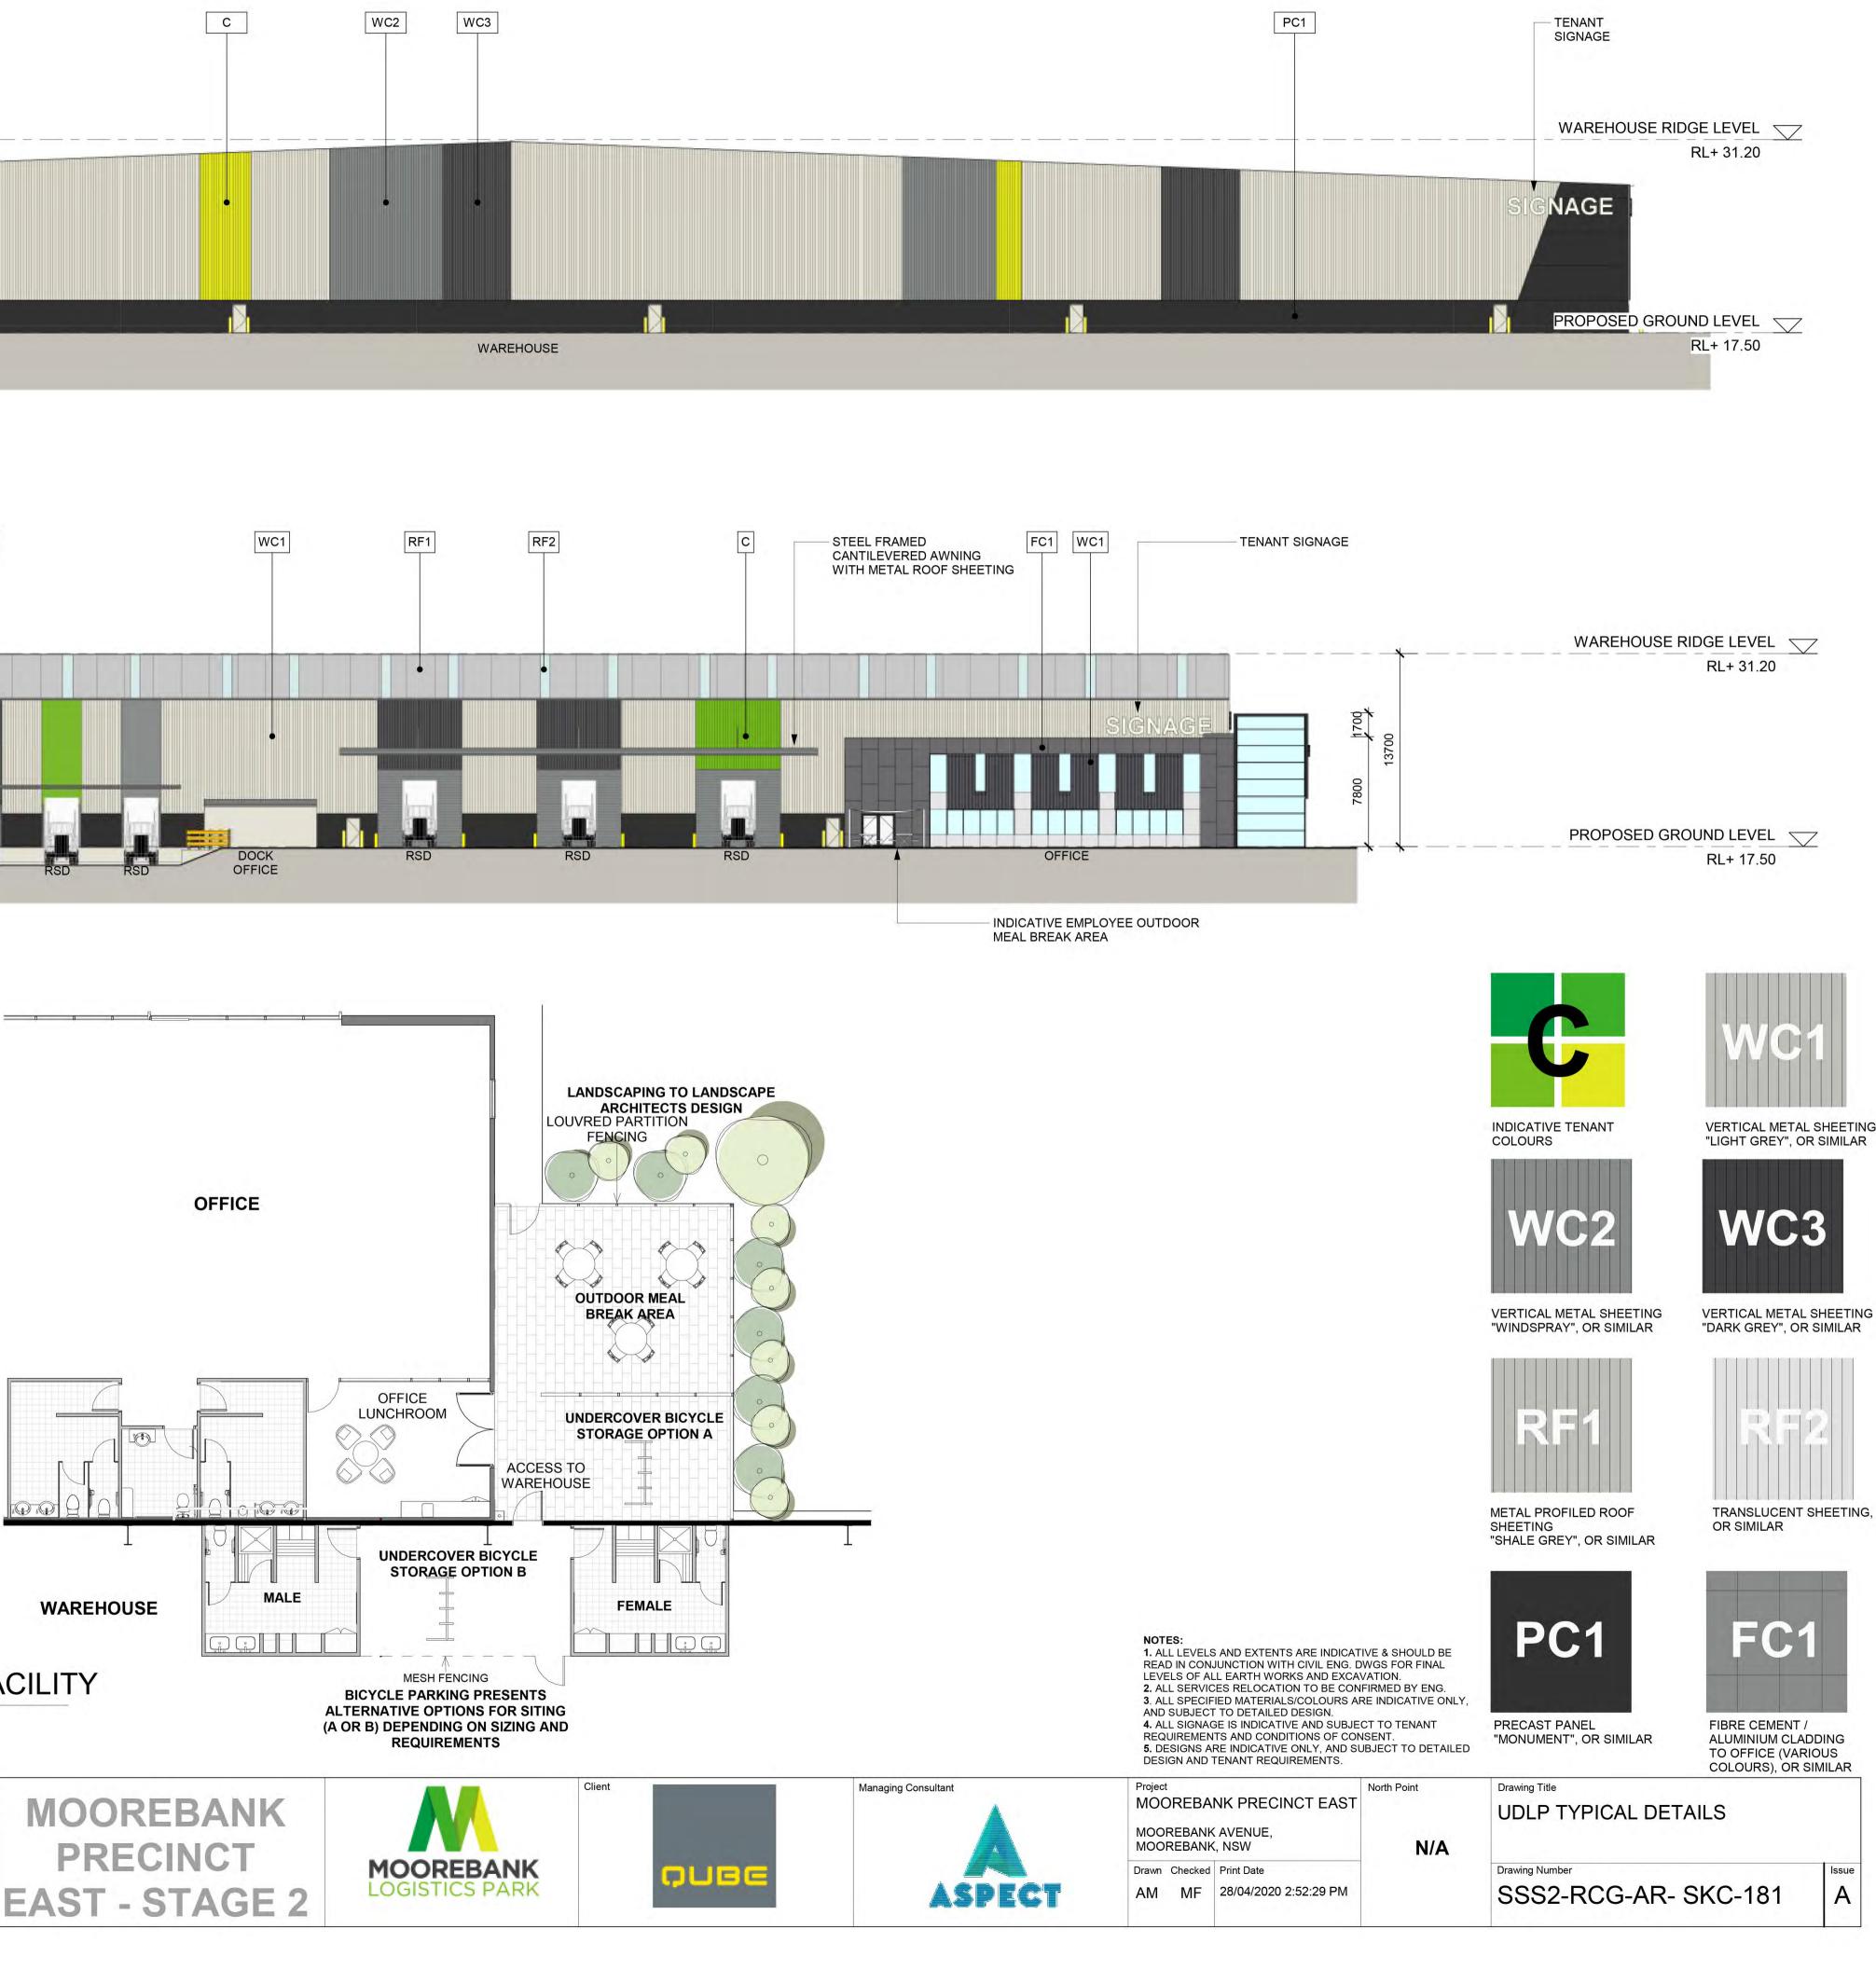

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-Figured dimensions to be taken in preference to scaled drawings. -All work is to conform to relevant Australian Standards and other						ACN 002 033 801 ABN 28 317 605 875 Level 15, 124 Walker Street
Codes as applicable, together with other Authorities' requirements and regulations.						North Sydney NSW 2060 Australia Tel: 61 02 9954 5011 Email: sydney@reidcampbell.com
NSW Registered Architect Mark David Roach, 10332 NSW Registered Architect James Webb, 10187						Fax: 61 02 9954 4946 Web: www.reidcampbell.com